ADDENDUM NO. 1 CSP# 207702

Org # 194 – K.B. Polk Center for Academically Talented & Gifted - Renovation

DALLAS INDEPENDENT SCHOOL DISTRICT

20 December 2024



20 DECEMBER 2024

20 December 2024

Any addendum issued will be listed or posted at the District website http://www.dallasisd.org/. Click on "Departments" Click On "Construction Services/Bond Office" Click On "Bond Vendor Opportunities" then click on bid Package number. Any and all addenda that are too large in size for the website will not be posted on the District website. However, all such addenda will be listed on the website with the of issuance of each addendum, and instructions to proposers for procuring such addenda from the Printing Company.

Lawton Reprographics Center Attention: North Store Address: 14305 Inwood Road Dallas, Texas 75244 Phone: 972-9802957

Email: north@lawtonrepro.com

Addenda will be available from the Printing Company for purchase. Purchase price must be obtained directly from the Printing Company.

The Bidder or proposer is responsible for obtaining all Addenda prior to submitting a bid or proposal to the district.

The following items modify the plans and specifications and shall become a part of the contract documents.

ORG #194 K.B. Polk Center for Academically Talented & Gifted - Renovation

GENERAL

 Referring to document distribution on Dallas ISD website, total estimated construction budget (CCL + IC+ Allowances) for CSP 207702 is \$6,240,164.00 as advertised in Project Manual Vol 1.
 Please refer to the spec DIV 00 11 13.

QUESTIONS

- Question: We are missing spec sections 003126, 003126.13, 003126.16, 003132 & 003132.13
 for the K.B. Polk Center for Academically Talented and Gifted project.
 - Response: Removing those sections from Volume 1 specs-Division 00 Table of Contents.
 Please, refer to revised Table of Contents attached.
- Question: Does the Fire Alarm Scope include DAS System?
 - Response: The Fire Alarm Scope does not include a Das system, It should be a delegated design. ERRCS Survey to be conducted as part of the base scope.
- Question: Where can the drawings be available?
 - Response: The drawings are available with the reprographics printer and in designated plan rooms per Division 001113 spec attached.
- Question: Is the roof under warranty?
 - Response: There is no warranty on the roof at present time.
- Question: Is all flooring irrespective of existing floor (other than the offices) being replaced with VCT?
 - Response: No, not all flooring will be replaced with VCT. Please, refer to demo scope, master schedule and finish schedule to ensure the flooring finish.
- Question: Is the abatement under the GC scope?
 - Response: Yes, please refer to the Haz Mat Task 1 report under Volume 2 Specs for more details.
- Question: Please provide more information regarding the Alternate #2 Sidewalk replacements including specifications, and locations. Also, on A1.20, Keynote P.02 shows a parking area as part of the sidewalk replacement. Please advise.
 - Response: The extent of replacement of sidewalk is clarified in sheet A1.20. Revised sheet is attached to the addendum.

- Question: On P6.01 Keynote #6 says to replace existing grease waste piping in the kitchen. Are these lines in a crawlspace or will slab saw cutting be required?
 - Response: To address the keynote #6 on sheet P6.01, refer to revised sheet P4.01 attached to this addendum.

SPECIFICATIONS

- 00 01 10 Reference Section 000100 Table of Contents
 - Removing the following specs sections from Volume 1 Project Manual Division 00 Table of Contents
 - 00 31 26 Existing Hazardous Material Information
 - 00 31 26.13 Asbestos Report
 - 00 31 26.16 Asbestos Abatement Guide
 - 00 31 32 Geotechnical Data
 - 00 31 32.13 Geotechnical Report
- 00 11 13 Reference Section 001113 Advertisement for CSP
 - Replace this specification with the attached.
- 00 41 11 Reference Section 004111 Proposal Form Base Bid (Part 1-A for the CSP)
 - o Adding \$15,500.00 as other allowances in 2.09 C Table for Proposer's Price Breakdown

DRAWINGS

- Sheet A0.11 Replace sheet with the revised attached A0.11 ABBREVIATIONS AND SHEET INDEX
 - Revised sheet notes and scope per attached
- Sheet A0.12 Replace sheet with the revised attached A0.12 PHASING PLAN
 - Revised sheet notes and scope per attached sheet.
- Sheet A1.20 Replace sheet with the revised attached A1.20 SITE PLAN
 - Revised sheet notes and scope per attached sheet.
- Sheet M3.01 Replace sheet with the revised attached M3.01 LEVEL 1 MECHANICAL OVERALL PLAN
 - Revised sheet notes and scope per attached sheet.
- Sheet M10.01 Replace sheet with the revised attached M10.01 MECHANICAL SCHEDULES
 - o Revised sheet notes and scope per attached sheet.

- Sheet P4.01 Replace sheet with the revised attached P4.01 PLUMBING UNDERFLOOR LEVEL 1 OVERALL PLAN
 - o Revised sheet notes and scope per attached sheet.
- Sheet P4.03 Replace sheet with the revised attached P4.03 PLUMBING LEVEL 2
 OVERALL PLAN
 - Revised sheet notes and scope per attached sheet.
- Sheet E5.02 Replace sheet with the revised attached E5.02 LEVEL 1 LIGHITNG PLAN B
 - Revised sheet notes and scope per attached sheet.
- Sheet E5.03 Replace sheet with the revised attached E5.03 LEVEL 2 LIGHITNG PLAN B
 - Revised sheet notes and scope per attached sheet.
- Sheet E5.04 Replace sheet with the revised attached E5.04 LEVEL 1 LIGHITNG PLAN B
 - Revised sheet notes and scope per attached sheet.
- Sheet E6.03 Replace sheet with the revised attached E6.03 LEVEL 1 LIGHITNG CONTROLS PLAN B
 - o Revised sheet notes and scope per attached sheet.
- Sheet E6.04 Replace sheet with the revised attached E6.04 LEVEL 2 LIGHTING CONTROLS PLAN A
 - o Revised sheet notes and scope per attached sheet.
- Sheet E6.05 Replace sheet with the revised attached E6.05 LEVEL 2 LIGHTING CONTROLS PLAN B
 - o Revised sheet notes and scope per attached sheet.
- Sheet E10.02 Replace sheet with the revised attached E10.2 LIGHTING CONTROLS DETAILS
 - o Revised sheet notes and scope per attached sheet.

END OF ADDENDUM

VOLUME 1 OF 2

Division 00

;
SP

Proposal Requirements

00 11 17 Intention to Propose Form Instructions to Proposers 00 21 13

Project Information

00 31 00

Available Project Information School Operation Parameters Statement 00 31 18

Proposal Documents

00 41 10	Overall Proposal Packaging Checklist
00 41 11 (a)	Materials Escalation Price Reconciliation Form
00 41 11	Proposal Form – Base Bid (Part 1-A of the CSP)
00 41 12	Proposal Form – Alternates and Unit Pricing (Part 1-C of the CSP)
00 41 13	Technical Proposal (Part 1-B of the CSP)
00 43 13	Proposal Guarantee Bond (Part 1-A of the CSP)
00 45 00	DISD Required forms combined (Part 1-A of the CSP)
00 45 20	Certificate of Non-Discrimination (Part 1-A of the CSP)
00 45 22	Notification of Hazardous Materials Affidavit (Part 1-A of the CSP)
00 45 23	Family Conflict of Interest Questionnaire (Part 1-A of the CSP)
00 45 39	MWBE Compliance Guidelines and Forms (Part 2 of the CSP)

Contract Forms

	
00 43 43	Prevailing Wage Rates Schedule
00 52 10	Standard form of Agreement between Owner and Contractor
00 52 11	General Conditions of the Contract for Construction
00 55 00	Notice to Proceed Forms
00 61 13	Performance Bond Form
00 61 16	Payment Bond Form
00 73 19	Dallas Independent School District Construction Minimum Safety Program Guidelines Manual

Division 01

General Requirements

01 10 00	Summary of Work
01 21 00	Allowances
01 22 00	Unit Prices
01 23 00	Alternates
01 25 00	Substitution Procedures
01 29 00	Payment Procedures
01 29 73	Schedule of Values
01 31 00	Project Management and Coordination
01 32 00	Construction Progress Documentation
01 32 16	Construction Progress Schedule
01 32 33	Photographic Documentation
01 33 00	Submittal Procedures
01 35 43	EPA Lead-Based Paint Renovation, Repair, and Painting Program
01 40 00	Quality Requirements

Dallas ISD Construction Services

SECTION 00 01 10 - TABLE OF CONTENTS

01 42 00	References
01 45 23	Testing Adjusting and Balancing for HVAC – (updated 1-28-2020 Final)
01 50 00	Temporary Facilities and Controls
01 52 14	Temporary Facilities for Students
01 60 00	Product Requirements
01 73 00	Execution
01 77 00	Closeout Procedures & Checklist
01 78 23	Operation and Maintenance Data
01 78 39	Project As-Builts & Record Documents
01 79 00	Demonstration and Training
01 91 00	General Cx Requirements (1-28-20 Final)

VOLUME 2 OF 2

Division 00

00 01 00	Project Manual Cover
00 01 01	Project Title Page
00 01 07	Seals Page
00 01 10	Table of Contents
00 01 15	List of Drawing Sheets

Project Information

00 31 26	Existing Hazardous Material Information
00 31 26.13	Asbestos Report
00 31 26.16	Asbestos Abatement Guide
00 31 32	Geotechnical Data
00 31 32.13	Geotechnical Report

Division 02

Existing Conditions

02 41 19 Selective Demolition

Division 03

Concrete

03 54 16 Hydraulic Cement Underlayment

Division 04

Masonry

04 01 20.63	Brick Masonry Cleaning
04 20 00	Unit Masonry
04 72 00	Cast Stone Masonry

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05 05 10	Metal Finishes
05 40 00	Cold-Formed Metal Framing
05 50 00	Metal Fabrications
05 52 13	Pip and Tube Railings
	Division 06
Wood Plastics	a and Compositos
	Miscellaneous Rough Carpentry
00 41 10	Tradio Edifinato Facea Afontectara Capineto
	Division 07
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	Moisture Protection Moisture Vapor Emission Control System
	SBS Modified Bitumen Membrane Roofing
	Minor Roof Renovation Work
	Sheet Metal Flashing and Trim
07 72 00	Roof Accessories
07 84 13	Penetration Firestopping
07 84 46	Fire-Resistive Joint Systems
07 92 00	Joint Sealants
	Division 08
	DIVISION 00
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	Hollow Metal Doors and Frames
	Interior Aluminum Doors and Frames
	Flush Wood Doors
	Access Doors and Frames Aluminum-Framed Entrances and Storefronts
	Door Hardware
	Glazing
00 00 00	Clazing
	Division 09
Finishes	
09 01 60	Terrazzo Floor Cleaning
09 22 16	Non-Structural Metal Framing
09 29 00	Gypsum Board
09 30 00	Tiling
09 51 13	Acoustical Panel Ceilings
	Resilient Base and Accessories
	Resilient Tile Flooring
09 68 13	Carpet Tile
	05 05 10 05 40 00 05 50 00 05 50 00 05 52 13 Wood, Plastics 06 10 53 06 41 16 Thermal and N 07 26 35 07 52 00 07 56 50 07 62 00 07 72 00 07 84 13 07 84 46 07 92 00 Openings 08 11 13 08 12 16 08 14 16 08 31 13 08 41 13 08 41 13 08 71 00 08 80 00 Finishes 09 01 60 09 22 16 09 29 00 09 30 00 09 51 13 09 65 13 09 65 19 09 68 13

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09 81 16 09 91 00 Acoustical Blanket Insulation

Painting

00 01 10

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10 21 13	Toilet Compartments
10 28 00	Toilet, Bath, and Custodial Accessories
10 99 00	Miscellaneous Specialties

Division 11

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Division 12

Furnishings

12 36 62 Solid Surfacing Materials

Division 13

Special Construction

Not Used

Division 14

Conveying Equipment

Not Used

Division 21

Fire Suppression

Not Used

Division 22

Plumbing	
22 00 10	General Requirements for Plumbing Systems
22 05 23	General-Duty Valves for Plumbing Piping
22 05 29	Hangers and Supports for Plumbing Piping and Equipment
22 05 53	Identification for Plumbing Piping and Equipment
22 07 19	Plumbing Piping Insulation
22 10 05	Plumbing Piping
22 10 06	Plumbing Piping Specialties
22 11 16	Domestic Water Piping
22 40 00	Plumbing Fixtures

Division 23

Heating, Venti	lating and Air Conditioning
23 00 01	General Requirements for HVAC Systems
23 00 10	Basic Mechanical Requirements
23 05 13	Common Motor requirements for HVAC Equipment
23 05 17	Sleeves and Sleeve Seals for HVAC Piping
23 05 19	Meters and Gages for HVAC Piping
23 05 23	General Duty Valves for HVAC Piping
23 05 29	Hangers and Supports for HVAC Equipment
23 05 29	Hangers and Supports for HVAC Piping and Equipment
23 05 53	Mechanical Identification
23 05 93	Testing, Adjusting, and Balancing for HVAC
23 07 13	Duct Insulation
23 07 19	HVAC Piping Insulation
23 08 00	Commissioning of HVAC
23 09 00	Instrumentation and Control for HVAC
23 09 23	Energy Management Control System (Bacnet IP-Tridium)
23 09 25	Variable Frequency Drives
23 21 13	Hydronic Piping
23 23 00	Refrigerant Piping
23 31 00	HVAČ Ducts and Casings
23 33 00	Air Duct Accessories
23 34 23	HVAC Power Ventilators
23 37 00	Air Outlets and Inlets
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23 81 19	Self Contained Air Conditioners
23 81 26.13	Small Capacity Split-System Air Conditioners
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26 05 05	Selective Demolition for Electrical
26 05 19	Low-Voltage Electrical Power Conductors and Cables
26 05 26	Grounding and Bonding for Electrical Systems
26 05 29	Hangers and Supports for Electrical Systems
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26 05 53 26 05 73	Conduit for Electrical Systems
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26 05 73	Conduit for Electrical Systems Identification for Electrical Systems Power System Studies
26 05 73 26 08 00	Conduit for Electrical Systems Identification for Electrical Systems Power System Studies Commissioning of Electrical Systems
26 05 73 26 08 00 26 09 23	Conduit for Electrical Systems Identification for Electrical Systems Power System Studies Commissioning of Electrical Systems Lighting Control Devices
26 05 73 26 08 00 26 09 23 26 27 26	Conduit for Electrical Systems Identification for Electrical Systems Power System Studies Commissioning of Electrical Systems Lighting Control Devices Wiring Devices
26 05 73 26 08 00 26 09 23 26 27 26 26 28 13 26 28 16.16 26 29 13	Conduit for Electrical Systems Identification for Electrical Systems Power System Studies Commissioning of Electrical Systems Lighting Control Devices Wiring Devices Fuses Enclosed Switches Enclosed Controllers
26 05 73 26 08 00 26 09 23 26 27 26 26 28 13 26 28 16.16	Conduit for Electrical Systems Identification for Electrical Systems Power System Studies Commissioning of Electrical Systems Lighting Control Devices Wiring Devices Fuses Enclosed Switches Enclosed Controllers Lightning Protection for Structures
26 05 73 26 08 00 26 09 23 26 27 26 26 28 13 26 28 16.16 26 29 13 26 41 13 26 43 00	Conduit for Electrical Systems Identification for Electrical Systems Power System Studies Commissioning of Electrical Systems Lighting Control Devices Wiring Devices Fuses Enclosed Switches Enclosed Controllers Lightning Protection for Structures Surge Protective Devices
26 05 73 26 08 00 26 09 23 26 27 26 26 28 13 26 28 16.16 26 29 13 26 41 13 26 43 00 26 51 00	Conduit for Electrical Systems Identification for Electrical Systems Power System Studies Commissioning of Electrical Systems Lighting Control Devices Wiring Devices Fuses Enclosed Switches Enclosed Controllers Lightning Protection for Structures Surge Protective Devices Interior Lighting
26 05 73 26 08 00 26 09 23 26 27 26 26 28 13 26 28 16.16 26 29 13 26 41 13 26 43 00	Conduit for Electrical Systems Identification for Electrical Systems Power System Studies Commissioning of Electrical Systems Lighting Control Devices Wiring Devices Fuses Enclosed Switches Enclosed Controllers Lightning Protection for Structures Surge Protective Devices
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26 05 73 26 08 00 26 09 23 26 27 26 26 28 13 26 28 16.16 26 29 13 26 41 13 26 43 00 26 51 00 26 56 00	Conduit for Electrical Systems Identification for Electrical Systems Power System Studies Commissioning of Electrical Systems Lighting Control Devices Wiring Devices Fuses Enclosed Switches Enclosed Controllers Lightning Protection for Structures Surge Protective Devices Interior Lighting Exterior Lighting
26 05 73 26 08 00 26 09 23 26 27 26 26 28 13 26 28 16.16 26 29 13 26 41 13 26 43 00 26 51 00 26 56 00 Electronic Saf 28 46 00	Conduit for Electrical Systems Identification for Electrical Systems Power System Studies Commissioning of Electrical Systems Lighting Control Devices Wiring Devices Fuses Enclosed Switches Enclosed Controllers Lightning Protection for Structures Surge Protective Devices Interior Lighting Exterior Lighting Division 28 sety and Security Fire Detection and Alarm
26 05 73 26 08 00 26 09 23 26 27 26 26 28 13 26 28 16.16 26 29 13 26 41 13 26 43 00 26 51 00 26 56 00 Electronic Saf 28 46 00 28 51 00	Conduit for Electrical Systems Identification for Electrical Systems Power System Studies Commissioning of Electrical Systems Lighting Control Devices Wiring Devices Fuses Enclosed Switches Enclosed Controllers Lightning Protection for Structures Surge Protective Devices Interior Lighting Exterior Lighting Division 28 ety and Security Fire Detection and Alarm In Building Two Way Emergency Responder Communication Enhancement System
26 05 73 26 08 00 26 09 23 26 27 26 26 28 13 26 28 16.16 26 29 13 26 41 13 26 43 00 26 51 00 26 56 00 Electronic Saf 28 46 00	Conduit for Electrical Systems Identification for Electrical Systems Power System Studies Commissioning of Electrical Systems Lighting Control Devices Wiring Devices Fuses Enclosed Switches Enclosed Controllers Lightning Protection for Structures Surge Protective Devices Interior Lighting Exterior Lighting Division 28 sety and Security Fire Detection and Alarm

Not Used

Procurement Services

November 24, 2024

The Dallas Independent School District ("District") is soliciting Competitive Sealed Proposals ("CSP") from qualified sources relative to the provision of the following request For Competitive Sealed Proposals ("CSP"). This procurement will be managed under the Dallas ISD Construction Services department.

For information on how to obtain the CSP documents, go to the District's **Construction Services** website **http://www.dallasisd.org. Click on "Departments;" click on "Construction Services/Bond Office;" click on "Bond Vendor Opportunities;"** then click on the bid package number. Follow the Document Distribution instructions to obtain the CSP documents. The CSP documents contain the necessary information to submit a CSP to the District, including construction documents, selection criteria, estimated budget, project scope, schedule, and other information that contractors may require to respond to the request.

Please return the "Intention to Propose" form (Specification Section 00 11 17) to the Construction Services Procurement Director listed on the form.

CSP#	Description	Closing Date	Buyers Initials
207702	ORG 194 - K.B. POLK CENTER FOR ACADEMICALLY TALENTED AND GIFTED - RENOVATION	01/08/2025	DBE

A pre-proposal meeting will be held at 6911 Victoria Ave, Dallas, TX 75209 on 12/09/2024, 2.30 PM at campus in-person for all interested parties. This meeting is not mandatory, but information discussed will be extremely helpful in preparation of the proposal.

All general contractors and sub-contractors are encouraged to attend this meeting. Contractors will meet A/E(s) and PM at the school to start site tours. The first site tour will take place immediately following the pre-proposal. The following is the schedule for each site tour:

School Org#	School Name	Date	Time	School Address, Location of Meeting
194	K.B. POLK CENTER FOR ACADEMICALLY TALENTED AND GIFTED	12/09/2024	3:00 PM	6911 Victoria Ave, Dallas, TX 75209

All Construction Services procurements must be physically delivered to the Construction Services office, at the Linus D. Wright Dallas ISD Administration Building 9400 North Central Expressway, Suite 800 Dallas, TX 75231. (Call 972.925.7200 for directions). Delivery to other locations will result in rejection of a CSP.

Completed CSP Package Part 1-A, 1-B and 1-C are due on Wednesday, 01/08/2025 at 2:00 PM (local time).

Completed CSP Package Part 2 is due on Thursday, 01/09/2025 at 3:00 PM (local time).

Any materials received after the respective closing dates / times will not be considered.

The District will open and read the names of the proposers and prices submitted in responsive CSPs beginning at 3:00 P.M. local time <u>upon submittal of Part 2</u> of the Package, via GOOGLE MEET at Dallas ISD Construction Services, Linus D. Wright Dallas ISD Administration Building 9400 North Central Expressway, Suite 800 Dallas, TX 75231.

CSP 207702 ORG 194 - K.B. POLK CENTER FOR ACADEMICALLY TALENTED AND GIFTED - RENOVATION - BID OPENING

Thursday, January 9, 2025 · 3:00 – 4:00pm

Time zone: America/Chicago Google Meet joining info

Video call link: https://meet.google.com/ppe-awip-zjp Or dial: (US) +1 385-988-0483 PIN: 766 688 857#

No further information will be officially released until after the date the agenda is publicized for the Board of Trustees briefing.

The right is reserved to reject any or all bids, proposals, CSPs or statements of qualification and to waive technicalities.

The Dallas Independent School District is committed to the ideals of equal opportunity in all its business endeavors.

The Dallas Independent School District's Construction Services projects have a 30% Minority and Women-Owned Business Enterprise (M/WBE) construction goal.

RUN TWO TIMES ONLY AS FOLLOWS:

11/24/2024 and 12/01/2024



DALLAS INDEPENDENT SCHOOL DISTRICT

PROCUREMENT SERVICES - CONSTRUCTION SERVICES

DOCUMENT DISTRIBUTION

CONSTRUCTION SERVICES

CSP 207702 ORG 194 - K.B. POLK CENTER FOR ACADEMICALLY TALENTED AND GIFTED – RENOVATION J194 P1000 1

SOLICITATION TIMELINE:

Issue Date:	11/24/2024
First Advertisement Date	11/24/2024
Second Advertisement Date	12/01/2024
Preproposal Meeting	12/09/2024 2:30 PM
Question Deadline	12/13/2024
Question Responses from the District	12/20/2024
CSP Response Due Dates Pt 1-A and Pt 1-B	01/08/2025 2:00 PM
CSP Response Due Date Pt 2	01/09/2025 3:00 PM
CSP Evaluation	01/15/2025
Anticipated Board Approval	02/27/2025

1. DOCUMENT DISTRIBUTION:

The attached "Document Distribution" page details how documents and addenda will be distributed.

2. ESTIMATED CONSTRUCTION BUDGET INCLUDING ALLOWANCES:

Total Estimated Construction Budget (CCL + IC+ Allowances) for CSP 207702 \$6,240,164.00

3. Scope of Work. The Work consists of:

ORG 194 - K.B. POLK CENTER FOR ACADEMICALLY TALENTED AND GIFTED – RENOVATION - Project consists of the following:

- 4. Provide secure front vestibule
- 5. Renovate administration area
- 6. Replace exterior waterproofing/sealant joints
- 7. Replace fire alarm system
- 8. Provide exterior lighting controls
- 9. Replace exterior lights with LED lighting
- 10. Replace carpet/VCT flooring and base throughout facility
- 11. Provide new marquee sign
- 12. Perform mild detergent medium pressure wash of exterior
- 13. Replace interior lights with LED lighting and lighting controls
- 14. Mechanical/HVAC improvements including IDF/MDF air conditioning
- 15. Plumbing improvements
- 16. Contact Information:

<u>Technical</u> questions and all other questions related to this solicitation are to be referred to:

Attention: Dallas ISD Procurement Services Email: <u>ProcurementCS@dallasisd.org</u>

Please notate the solicitation number 207702 in the subject line of your email.

DOCUMENT DISTRIBUTION CSP PACKAGE 207702

Documents will be distributed as follows:

Hard copy and file distribution are provided, beginning 11/25/2024.

Printing Company Name: Lawton Reprographics Center

Attention: North Store

Address: 14305 Inwood Road City, State and Zip Dallas, TX 75244 Phone: 972 980 2957

Email: north@lawtonrepro.com

Any addendum issued will be listed or posted at the **Dallas ISD Construction Services** website http://www.dallasisd.org/ Click on "Departments"; click on "Construction Services/Bond Office"; click on "Bond Vendor Opportunities"; then click on the bid package number. Any and all addenda that are too large in size for the website will not be posted on the District website. However, all such addenda will be listed on the website with the date of issuance of each addendum, and instructions to proposers for procuring such addenda from **Lawton Reprographics Center**

Documents are available as follows:

- Full size sets of plans and specifications and USB drives of the same information and details are available for purchase at the Printing Company noted above. Purchase price must be obtained directly from the Printing Company.
- The purchases of additional USB drives of proposal documents in PDF format are available only to purchasers of at least one (1) full size plans and specifications. Purchase price must be obtained directly from the Printing Company.
- Addenda will be available from the Printing Company for purchase. Purchase price must be obtained directly from the Printing Company.

Delivery pricing can be obtained from Lawton Reprographics Center

The bidder or proposer is responsible for obtaining all Addenda prior to submitting a bid or proposal to the District.

A list of Plan Rooms and other entities that have documents available for viewing are as follows:

DRAWINGS AND SPECIFICATIONS ARE AVAILABLE AT THE FOLLOWING:

Dallas/Fort Worth Minority Supplier Development Council

Sha'Ron Richardson 214-630-0747

<u>construction@dfwmsdc.com</u>

8828 N. Stemmons Freeway, Ste. 550

Dallas, TX 75247

Regional Hispanic Contractors Association

John H. Martinez

john@regionalhca.org

3918 North Hampton Rd.

Dallas, TX 75212

Regional Black Contractors Association of North Texas, Inc.

John Proctor 214-565-8946

info@blackcontractors.org 2627 Martin Luther King Jr. Blvd,

Dallas, TX 75215

Fort Worth Hispanic Chamber of Commerce

Gilbert Juarez 817-625-5411

gilbert@pic-printing.com 1327 N. Main Street https://www.fwhccplanroom.com/ Fort Worth, TX 76164

Greater Dallas Hispanic Chamber of Commerce

Gabriela Carvallo

gabriela@gdhcc.com

214-521-6007

1402 N. Corinth St., Ste 225

Dallas, TX 75215

Construction Connect

Michael Stubbs 800-364-2059
Content@ConstructConnect.com 30 Technology Parkway South, Ste 100

Norcross, GA 30092

Dodge Data & Analytics formerly McGraw-Hill Construction Dodge

support@construction.com 877-784-9556

4300 Beltway Place, Ste. 180 Arlington, TX 76018

Dallas Black Chamber of Commerce

Tigist Solomon 214-702-6652

tsolomon@dbcc.org 2922 Martin Luther King Jr. Blvd., Building A, Ste. 104

Dallas, TX 75215

Fort Worth Metropolitan Black Chamber of Commerce

Jeremiah Anderson

817-871-6558

janderson@fwmbcc.org

1150 South Fwy, Ste. 211

Fort Worth, TX 76104

Virtual Builders Exchange, LLC

Heidi Shaffer
210-564-6900
heidi@virtualbx.com
4047 Naco Perrin, Ste.100
San Antonio, TX 78217

 Dallas ISD Construction Services
 CSP 207702

 00 11 13
 Page 6 of 6
 Addendum #1, 12/20/2024

Revised 5/1/2024

Name of Contractor	

COMPETITIVE SEALED PROPOSAL (Part 1A) to DALLAS INDEPENDENT SCHOOL DISTRICT FOR THE FOLLOWING WORK:

PART 1. General Information

Competitive Sealed Proposal (CSP) 207702, consisting of improvements to:

ORG#	PROJECT NAME	PROJECT TYPE	ADDRESS
194	ORG 194 - K.B. POLK CENTER FOR ACADEMICALLY TALENTED AND GIFTED	RENOVATION	6911 Victoria Ave, Dallas, TX 75209

PART 2. Proposal Form

2.01 Agreement of Proposal Submittal

The undersigned, as a designated representative of the proposer, declares such firm is the only entity, as principal, with any interest in this Proposal, and the Proposal is made without collusion with any other entity.

The proposer affirms that the form of Contract, Instructions for Competitive Sealed Proposals, Supplemental Instructions for Competitive Sealed Proposal, Addenda, selection criteria, weighting/scoring system, estimated budget, Specifications, and the Drawings pertaining to this Proposal have been examined and the firm has also examined the locations, conditions, and classes of materials for the proposed Work and agrees to provide all necessary labor, materials, plant and equipment, machinery, tools, apparatus and construction means to accomplish the Work described in the Contract Documents in the manner prescribed.

The proposer agrees the quantities of Work to be performed and materials to be furnished may be increased or decreased as may be considered necessary, in the sole opinion of Dallas ISD's designated representative, to complete the Work as planned and contemplated. Adjustment for changes in Work will be in accordance with the General Conditions.

Proposal amounts must be shown in both words and figures. In case of discrepancy, the amount shown in words will govern.

2.02 Addenda

The proposer acknowledges receipt and incorporation of the following addenda into this Proposal. Proposer is to fill in the Addenda # and date and initial in the box to show receipt.

CSP 207702

Addendum No.	Addendum No.	Addendum No.	Addendum No.

Name of Contractor	

2.03 Withdrawal of Proposals

A Proposal may be withdrawn only upon written request by the proposer or his duly authorized representative, provided such request is received by the Owner at the place designated for receipt of Proposals and prior to the time fixed for the opening of Proposals.

No Proposal may be withdrawn after the time fixed for the opening of Proposals for a period of 90 days.

2.04 Award of Contract

The proposer to whom the award of a Contract is made will be promptly notified following Board action. If a proposer, (a) withdraws his Proposal within 90 days after the date and time fixed for the opening of Proposals in the Advertisement for Proposals, or, (b) fails or refuses to execute the Agreement, or other required forms within ten (10) days after the same are presented to him for signature, or (c) fails or refuses to furnish properly executed Performance and Payment Bonds, and certification of required insurance upon the execution of the Agreement, the Owner may award the Work to another proposer or may re-solicit the contract. The Proposal Bond is forfeited if Proposal is withdrawn after the Proposal opening, or Contract Documents are not executed in accordance with the above requirements.

The Owner reserves the right to reject any or all Proposals and to waive any irregularities in any Proposal received. The Owner further reserves the right to limit the number of contracts awarded and/or to be performed concurrently to any one Contractor if such appears to be in the best interest of the District. Awards will be per published criteria and weights. Price is only 40% of the evaluation criteria, and awards may be made to other than the low dollar proposer.

2.05 Notice To Proceed (NTP) and Notice of Intent to Award (NIA)

The Contractor shall not commence the Work under this Contract until execution of the Notice to Proceed (NTP) duly signed by Dallas ISD's designated representative.

The Contractor shall acknowledge that a Notice of Intent to Award (NIA) may be issued at the Owner's discretion. The purpose of the NIA is to expedite pre-construction activities. Upon receipt of the duly signed NIA, the Contractor shall promptly proceed with the activities listed and authorized by the NIA.

2.06 Collusion, Litigation, Default, Competency

By completing and submitting a Proposal, the proposer agrees to comply with the requirements of the following paragraph. A proposer who subsequently does not agree to comply with these requirements may be disqualified. The responses to the items of the Contractor's Qualification Statement will be used in evaluation of the Proposals on the project.

Proposers may be disqualified, and their proposals not considered for any of the following specific reasons:

- 1. Reason for believing collusion exists among proposers.
- 2. Reasonable grounds for believing that any proposer is interested in more than one proposal for the work contemplated.
- 3. The proposer is involved in any litigation against the Board.
- 4. The proposer is in arrears on any existing contract with Dallas ISD or has defaulted on a previous contract with Dallas ISD.
- 5. Lack of competency as revealed by the financial statement, experience and equipment questionnaires, or omission of required proposal submittals.

Name of Contractor	

- 6. Uncompleted work which, in the judgment of the Board, will prevent or hinder the prompt completion of this Work, if awarded.
- 7. Inaccurate information or circumstances that establish reasonable grounds for belief that the proposer is not a "responsible proposer" include, but are not limited to the below examples:
 - a. Incomplete Bid Submittal e.g., Missing Base Bid proposal number.
 - b. Incorrectly Calculated Total Base Bid Proposal plus Owner's Controlled Contingency MUST add up to Total Base Bid. Please double check to confirm compliance.

By entering into a contract with Dallas ISD, the proposer agrees that (1) Work on the project will begin upon receipt of the Notice to Proceed, (2) Contractor will participate as a team member in cooperation with the Architect/Engineer (A/E) and Owner, (3) The Work will not interfere with normal instructional and learning programs of the school, (4) The Contractor will assign a full time competent superintendent for each school in the CSP and that same superintendent(s) shall remain for the duration of the contract, contingent upon that person's continued employment with the Contractor, (5)The Contractor will furnish and pay for the Bid, Performance, and Payment Bonds.

- Projects of \$25,000 and under: Bid bond is required
- Projects over \$25,000 and up to and including \$100,000: Bid and Payment Bond is required
- Projects over \$100,000: Bid, Performance and Payment Bonds are required

2.07 Ultimate Corporate Ownership

Is proposer a corporation? Check One, Yes No
Proposer's legal name and address of principal place of business:
Ultimate parent company or majority owner's name and address of principal place of business:

00 41 11

SECTION 00 41 11 - PROPOSAL FORM - BASE PROPOSAL Name of Contractor 2.08 Contractor's Price (40 Points out of 100 Possible Points in the Selective Criteria) The Proposer's Price is defined as the total amount, including Cost of the Work and allowances, for the performing or causing to be performed all Work including labor and materials, necessary to build, construct, erect and equip in accordance with the Contract Documents, Drawings, and Specifications. Contractor agrees to base its price on the proposed completion schedule and the phasing plan presented in the contract documents. The Contractor may, at their option, propose a project duration that is of less duration and indicate this duration in the box below (See Proposer's Proposed Substantial Completion Date box below). However, the duration proposed by the Contractor must be based upon the number of phases identified in the contract documents and must not be predicated upon the use of additional temporary swing space other than the swing space identified in the contract documents. documents identify the number of existing classrooms or temporary portable buildings available to the contractor for swing space. Base proposal is defined as the Cost of the Work not including allowances or alternates. (Amount shall be shown in both words and numbers; in the event of discrepancies, the words will govern.) Proposer's Price for all schools in CSP 207702, which includes the Allowances as per item 2.09 below: **Dollars**

Proposer's Price Breakdown (to be completed by proposer):

Base Proposal minus Allowances:	\$
2.09 B: Owner Controlled Contingency Allowance	\$ 296,413.00
2.09 C: Other Owner Allowances (provided by Owner, see 2.09 C below):	\$ 15,500.00
2.09 D: Proposer's Abatement Cost included in 2.08 A (Abatement is to be included in GC Base scope price. The intent of this section is to show the breakout of the abatement cost.)	
2.08 A: Proposer's Base Price plus (+) Allowances (should equal amount in Section 2.08 A above):	\$

2.09 Allowance Items

The following allowances are further described in Specification Section 01 21 00.

Dallas ISD Construction Services

CSP 207702

Name of Contractor	

В	Allowance Description: In Contract Owner Controlled Contingency (IC)	Dollar Amount (\$)
ORG 194	K.B. POLK CENTER FOR ACADEMICALLY TALENTED AND GIFTED - RENOVATION	\$296,413.00

С	Allowance Description: In Contract Owner Controlled Allowances	
	Interior Barrier Graphics Exterior Construction Screening Graphics	1. 7,500.00 2. 8,000.00

2.10 Alternates

This information is to be submitted with section 00 41 12 (Part 1-C of the CSP Package.)

2.11 Unit Pricing

This information is to be submitted with section 00 41 12 (Part 1-C of the CSP Package.)

2.12 Breakout or Separate Pricing

The successful Proposer shall provide a proposed preliminary schedule of values for each school within the CSP 3 days after Board award. In the chart below, the Proposer must provide the cost breakdown per school of the base price provided by the Proposer in paragraph 2.08A of this section

The following information is requested for information and budget verification only and it is not the basis for the quantitative evaluation of this proposal.

School Org #	School Name and Project Type	Estimated Construction Budget	Proposer's Base Bid Proposal Breakdown per School
194	K.B. POLK CENTER FOR	\$6,240,164.00	
	ACADEMICALLY TALENTED AND		
	GIFTED - RENOVATION		

Org #	School Name	Owner's Expected Substantial Completion Date	Proposer's Proposed Substantial Completion Date
194	K.B. POLK CENTER FOR ACADEMICALLY TALENTED AND GIFTED - RENOVATION	07/15/2026	

Name of Contractor	

2.13 Liquidated Damages

Time is of the essence in all Phases of the Work. It is specifically understood and agreed by and between Dallas ISD and Contractor that time is of the essence in the substantial completion of the Project.

The Contractor acknowledges and recognizes that Dallas ISD is entitled to full and beneficial occupancy and use of the completed work immediately following expiration of the Contract time. The Contractor further acknowledges and agrees that, if the Contractor fails to substantially, or cause the Substantial Completion of any portion of the Work within the Contract Time, the Owner will sustain actual damages as a result of such failure. The exact amount of such damages will be difficult to ascertain. Therefore, Dallas ISD and Contractor agree that, if the Contractor shall neglect, fail, or refuse to achieve substantial completion of the Work by the Substantial Completion date, subject to any proper extension granted by Dallas ISD, then Contractor agrees to pay to Dallas ISD the following sum(s) for each day in which such Work is not substantially completed, not as a penalty, but as liquidated damages, for the damages ("Liquidated Damages") that would be suffered by Dallas ISD as a result of delay for each and every calendar day that the Contractor shall have failed to have substantially completed the Work as required herein.

	Liquidated Damages		* Dollars Per Calend	lar Day
		Addition	Renovation	New
194	K.B. POLK CENTER FOR ACADEMICALLY TALENTED AND GIFTED - RENOVATION	N/A	\$1,500.00	N/A

^{*} The Dallas ISD's liquidated damages cost formula is 0.025% of the construction budget for the project, up to a maximum of \$1,500.00 per calendar day.

SECTION 00 41 11 – PROPOSAL FORM – BA Name of Contractor	ASE PROPOSAL
PART 3. Execution	
3.01 Proposal Form Execution	
Contractor's Firm Name (legal name)	
Federal Tax I. D. Number	
Contractor's Street Address	
Contractor's Phone Number	
Contractor's Fax Number	
Contractor's Email Address	
SUBMITTED BY:	
(Corporation, Partnership, Individual, etc.)	
Name of President of Corporation or	Name of Secretary of Corporation
Name of Principal Owner	(if applicable)
Corporation, Partnership, etc.,) is organized under t	
Firm:	
By:Printed Name	
Fitle:	
Signature:	
_egal Address:	
 Date:	
Date: Affix Corporation Seal here (if applicable)	

Α		F		0	
AΒ	ANCHOR BOLT	<u>-</u> F.###	SHEET NOTE - FINISH PLAN	OA OC	OVERALL ON CENTER(S)
VCC VC	ACOUSTICAL SEALANT ARCHITECTURAL CAST IN PLACE	FN.### FA	SHEET NOTE - FURNITURE PLAN FIRE ALARM	OCD	ON CENTER(S) OVERHEAD COILING DOOR
014	CONCRETE	FC	FIRE CODE	OCG	OVERHEAD COILING GRILLES
CM COUS	ALUMINUM COMPOSITE METAL ACOUSTICAL	FD FE	FLOOR DRAIN FIRE EXTINGUISHER	OD OFCI	OUTSIDE DIAMETER OWNER FURNISHED/
DJUST	ADJUSTABLE	FEB	FIRE EXTINGUISHER, BRACKET	OFF	CONTRACTOR INSTALLED
DJ D	ADJACENT ACCESS DOOR	FEC FG	FIRE EXTINGUISHER, CABINET ENTRANCE FLOOR GRILLES	OFF OFOI	OFFICE OWNER FURNISHED/
F	ACCESS FLOORING	FH	FIRE HYDRANT	011	OWNER INSTALLED
NFF NGG	ABOVE FINISH FLOOR AGGREGATE	FIN FIXT	FINISH/FINISHED FIXTURE	OH OP	OVERHEAD OPERABLE PARTITION
AHU	AIR HANDLING UNIT	FLRG	FLOORING	OPH	OPPOSITE HAND
ALT ALUM	ALTERNATE ALUMINUM	FLR FLSHG	FLOOR FLASHING	OPNG OPP	OPENING OPPOSITE
ANG	ANGLE	F.P.W.	FLOOD PROTECTION WALL	ORD O.S.	OVERFLOW ROOF DRAIN
ANOD APPROX	ANODIZED APPROXIMATELY	FL FM	FLOW LINE FACTORY MUTUAL	0.S. O/A	OVERFLOW SCUPPER OUTSIDE AIR
APC	ACOUSTICAL PANEL CEILING	FND	FOUNDATION	_	
ARCH ASPH	ARCHITECT/ARCHITECTURAL ASPHALT	FR GL FRP	FRITTED GLASS FIBER REINFORCED PLASTIC	<u>P</u>	OUEST NOTE ELOOP PLAN
ASPN ATC	ACRYLIC TEXTURED COATING	FRPF	FIREPROOF(ING)	P.### PW.###	SHEET NOTE - FLOOR PLAN SHEET NOTE - POWER PLAN
ATN	ATTENUATION/ATTENUATING	FSEC	FOOD SERVICE EQUIPMENT CONTRACTOR	PAC	ARCHITECTURAL PRECAST CONCRE
OTU <i>A</i> XU <i>A</i>	AUTOMATIC AUXILIARY	FS FTG	FULL SIZE FOOTING	PART PC	PARTITION POLISHED CONCRETE
AVE	AVENUE	FT	FOOT (FEET)	PCF	POUNDS PER CUBIC FOOT
AVG A/C	AVERAGE AIR CONDITIONING	FURN FURR	FURNISH FURRED/FURRING	PDP	PREFINISHED DECORATIVE PANELS
A/V	AUDIO VISUAL	FV	FIELD VERIFY	PERF	PERFORATED
В		FVC	FIRE VALVE CABINET	PLAST PLAS	PLASTER PLASTIC
3	BASE	FWC FWP	FABRIC WALL COVERING FABRIC WRAPPED WALL PANELS	PLBG	PLUMBING
BD BLDG	BOARD BUILDING	G		PLWD PNL	PLYWOOD PANEL
BLKG	BLOCKING	GALV	GALVANIZED	POL	PANEL POLISHED
BLK BM	BLOCK BEAM	GAL	GALLON	PRKG PR	PARKING PAIR
BM BOT	BEAM BOTTOM	GA GC	GAUGE GENERAL CONTRACTOR	PR PSF	PAIR POUNDS PER SQUARE FOOT
3.0.	BOTTOM OF	GD	GUARD	PSI	POUNDS PER SQUARE INCH
BR BRG	BICYCLE RACK BEARING	GEN GF	GENERAL GLASS FILM	PT PTD	PAINT PAINTED
BRK	BRICK	GI	GALVANIZED IRON	PTS	PAINTED
BRKT BSMT	BRACKET BASEMENT	GL GL BLK	GLASS, GLAZING GLASS BLOCK	PVC PVG	POLYVINYL CHLORIDE PAVING
BTW .	BETWEEN	GL BLK GMP	GLASS BLOCK GUARANTEED MAXIMUM PRICE	PVMT	PAVEMENT
3&B 3-B	BALLED & BUR LAPPED	GR	GRADE, GRADING	P.L. PL	PROPERTY LINE PLASTIC LAMINATE
3-B 3.M.	BACK TO BACK BENCH MARK	GRP GRT	GRAVEL GROUT	P/C	PRECAST
B/F	BOTH FACES	GSF	GLAZING SURFACE FILM	PFP	PREFINISHED PANEL
С		GSF GYP	GROSS SQUARE FOOT GYPSUM	Q	
CAB	CABINET		OTI SOM	QT	QUARRY TILE
CB	CATCH BASIN CLOSED CIRCUIT TELEVISION	<u>H</u>		R	
CCTV CEM	CEMENT	HB HC	HOSE BIBB HOLLOW CORE	R.###	SHEET NOTE - REFLECTED CEILING F
CER	CERAMIC	HDCP	HANDICAPPED	R RAD	RISER RADIUS
CFMF CFT	COLD FORMED METAL FRAMING CORK FLOOR TILE	HDWR HD	HARDWARE HEAD	RBA	RESILIENT BASE AND ACCESSORY
CIP	CAST IN PLACE CONCRETE	HD HFS	HALF FULL SIZE	RCP RD	REFLECTED CEILING PLAN ROOF DRAIN
CJ CKBD	CONTROL JOINT CHALKBOARD	HLB	HORIZONTAL LOUVER BLINDS	REBAR	REINFORCING BAR
CLG	CEILING	HM HORIZ	HOLLOW METAL HORIZONTAL	RECEPT RECEP	RECEPTION RECEPTACLE
CLR CL	CLEAR(ANCE) CLOSET	HP	HORSEPOWER	RECOM	RECOMMENDATION
CM	CONSTRUCTION MANAGER	HR HT	HOUR HEIGHT	REC REG	RECESSED REGULATION
CMU	CONCRETE MASONRY UNIT	HVAC	HEATING/VENTILATING/	REINF	REINFORCED
CNTR COL	COUNTER COLUMN	HW	AIR CONDITIONING HOT WATER	REQD RET	REQUIRED RETURN
COMPRESS	COMPRESSIBLE	HYD	HYDRANT	REV	REVISION
COMP	COMPOSITION CONCRETE	I		RE RF	REFER TO
COND	CONDITION	<u>I</u> ID	INSIDE DIAMETER	RFG	RESINOUS FLOORING ROOFING
CONF	CONFERENCE CONSTRUCTION	INCL	INCLUDE	RH	RIGHT HAND
CONTR	CONTRACTOR	INFO INSUL	INFORMATION INSULATION	RM RO	ROOM ROUGH OPENING
CONT	CONTINUOUS	INT	INTERIOR	ROW	RIGHT OF WAY
CORRU	CORRUGATED CORRIDOR	IN	INCH	RS RSF	ROLLER SHADE RESILIENT SHEET FLOORING
CPS	CARPET SHEET	IPS	INSIDE PIPE SIZE	RSF	RENTABLE SQUARE FOOT
CPT CSM	CARPET TILE CAST STONE MASONRY	J		RTF R/AG	RESILIENT TILE FLOORING RETURN AIR GRILLE
CSMT	CASEMENT	JAN	JANITOR	R/A	RETURN AIR
CTR CTSK	CENTER COUNTERSUNK	JST JT	JOIST JOINT	0	
CU FT	CUBIC FOOT (FEET)	1		S	OUEET VA ==
CU YD	CUBIC YARD		Ι ΔΜΙΝΔΤΕ/ΓΝ	S.### SAWU	SHEET NOTE - SITE SOUND ABSORBING WALL UNITS
CW C-C	COLD/CHILLED WATER CENTER TO CENTER	LAM LAV	LAMINATE(D) LAVATORY	SCHED	SCHEDULE(D)
C.O.	CASED OPENING	LGTH	LENGTH	SC SECT	STAINED CONCRETE SECTION
D		LH LV	LEFT HAND LEVEL	SF	SQUARE FEET
) D.###	SHEET NOTE - DEMO PLAN	LIN	LINEAR	SHLV SHTHG	SHELVES/SHELVING SHEATHING
)	DEEP/DEPTH	LL LT	LIVE LOAD LIGHT	SHTHG SHT	SHEET
OBL DEFL	DOUBLE DEFLECTION	L I LVR	LOUVER	SIM	SIMILAR
DEFS	DECORATIVE EXTERIOR FINISH	LWT	LIGHTWEIGHT	SKY SMV	SKYLIGHT STONE MASONRY VENEER
OF .	DRINKING FOUNTAIN	M		SPEC	SPECIFICATION
DGL DIAG	DECORATIVE GLASS DIAGONAL		METER	SQ SS	SQUARE SOILD SURFACE
OIA	DIAMETER	M MM	METER MILLIMETER	SSTL	STAINLESS STEEL
DIM DISC	DIMENSION DISCONNECT	MACH	MACHINE	STA STAB	STATION STABILIZE(D)
DISP	DISPENSER	MAINT MAS	MAINTENCE MASONRY	STAB	SOUND TRANSMISSION
DL DN	DEAD LOAD DOWN	MATL	MATERIAL	STC	COEFFICIENT STONE COUNTERTOP
ON OR	DOOR	MAX MECH	MAXIMUM MECHANICAL	STF	STONE FACING
os	DOWNSPOUT	MECH MEJ	MECHANICAL MASONRY EXPANSION JOINT	STL	STEEL
DSC DTL	DIMENSIONAL STONE CLADDING DETAIL	MEP	MECHANICAL, ELECTRICAL	STOR STRUCT	STORAGE STRUCTURE/STRUCTURAL
DWG(S)	DRAWING(S)	MF	PLUMBING METAL FINISHES	SUSP	SUSPENDED
E		MFR	MANUFACTURER	SW S/AD	SWITCH SUPPLY AIR DIFFUSER
ĒΑ	EACH SYSTEM OF SERVICE STATE OF STATE O	MH MIN	MANHOLE MINIMUM	-	
EFOB EJ	EXTERIOR FACE OF BUILDING EXPANSION JOINT	MIN MISC	MINIMUM MISCELLANEOUS		TDEAS
ELAS	ELASTIC (ELASTOMERIC)	ML	METAL LATH	T TA	TREAD TOILET ACCESSORY
ELEC	ELECTRICAL	MLDG MO	MOULDING MASONRY OPENING	TA TCOC	TOILET ACCESSORY TEXTURE COATING ON CONCRETE
ELEV EL	ELEVATOR ELEVATION	MO MR	MASONRY OPENING MOISTURE RESISTANT	TC	TRAFFIC COATING
ELAST	ELASTOMERIC	MSV	MANUFACTURED STONE VENEER	TEL TEMP	TELEPHONE TEMPERED
EMED	ENTRANCE FLOOR MATS	MTD MTG	MOUNTED MOUNTING	THK	THICK(NESS)
EMER EP	EMERGENCY EXPLOSION PROOF	MTL	METAL	THRES TKBD	THRESHOLD TACK BOARD
EQUIP	EQUIPMENT	MULL	MULLION	T.O.	TACK BOARD TOP OF
EQ EWC	EQUAL ELECTRIC WATER COOLER	MWP N I	METAL WALL PANEL	TOS	TOP OF STEEL
EWC EWH	ELECTRIC WATER COOLER ELECTRIC WATER HEATER	N	NOT IN CONTRACT	TOSS TR	TOP OF STRUCTURAL SLAB TRIM (METAL EDGE TRIM)
ΞW	EACH WAY	NIC NOM	NOT IN CONTRACT NOMINAL	TRANS	TRANSFORMER
EXH EXIST	EXHAUST EXISTING	NO. OR#	NUMBER	TS TTC	TUBE STEEL TELEPHONE TERMINAL CABINET
	EXPANSION	NRA	NET RENTABLE SQUARE FOOT	TUC	TILT-UP CONCRETE
EXPAN EXP	EXPOSED	NRC	NOISE REDUCTION COEFFICIENT	TV	TELEVISION

TYPICAL

EXTERIOR

2		I	3		I
		11			
11		#	SHEET NAME	DATE	REVISION
UL UNO	UNDERWRITERS LABORATORY UNLESS NOTED OTHERWISE	GENERAL A0.00	COVED CHEET	11 NOV 2024	100% Construction Documents
UPH UR	UPHOLSTERY URINAL	A0.10	COVER SHEET GRAPHIC STANDARDS	11 NOV 2024	100% Construction Documents
V		A0.11 A0.12	ABBREVIATIONS AND SHEET INDEX PHASING PLAN	20 DEC 2024 20 DEC 2024	ADDENDUM #1
VAC VERT	VACUUM VERTICAL	A0.20 A0.31	CODE INFORMATION LIFE SAFETY PLAN	11 NOV 2024 11 NOV 2024	100% Construction Documents 100% Construction Documents
VEST VLB	VESTIBULE VERTICAL LOUVER BLINDS	A0.32	LIFE SAFETY PLAN	11 NOV 2024	100% Construction Documents
VLD	VERTIONE ECOVER BEINDO	A0.33 A0.60	LIFE SAFETY PLAN REFERENCE (MOUNTING HEIGHTS)	11 NOV 2024 11 NOV 2024	100% Construction Documents 100% Construction Documents
W	WALL CONFERING	A0.61	REFERENCE (MOUNTING HEIGHTS)	11 NOV 2024	100% Construction Documents
WC WCD	WALL COVERING - DRY ERASE	A0.70	MASTER SCHEDULE	11 NOV 2024	100% Construction Documents
WDW WD WDV	WINDOW WOOD WOOD VENEER	STRUCTURAL S1.01	STRUCTURAL NOTES	11 NOV 2024	100% Construction Documents
WF WFA	WOOD VENEER WIDE FLANGE WOOD ATHLETIC FLOORING	S1.02	STRUCTURAL ABREVIATIONS & SYMBOLS LEGEND	11 NOV 2024	100% Construction Documents
WFE WH	ENGINEERED WOOD PLANK FLOORING WALL HUNG	S1.03 S2.00	SPECIAL INSPECTIONS MARQUEE SIGN ELEVATION AND DETAILS	11 NOV 2024 11 NOV 2024	100% Construction Documents100% Construction Documents
WI WP	WROUGHT IRON WALL PROTECTION	S2.01 S2.02	KITCHEN ADDITION FOUNDATION PLAN AND DETAILS LEVEL 2 RTU PLAN	11 NOV 2024 11 NOV 2024	100% Construction Documents 100% Construction Documents
WR WWF	WATER REPELLENTS WELDED WIRE FRABIC	S2.03	ROOF PLAN	11 NOV 2024	100% Construction Documents
W.P. W/I	WORK POINT WITHIN	S3.01 S5.01	TYPICAL CONCRETE DETAILS STEEL DETAILS	11 NOV 2024 11 NOV 2024	100% Construction Documents100% Construction Documents
W/O W/	WITHOUT WITH	ARCHITECTUR		0-0-0 0-1	2000
		A1.20 A1.40	SITE PLAN SITE DETAILS	20 DEC 2024 11 NOV 2024	ADDENDUM #1 1 1 1 1 1 1 1 1 1 1 1 1 1 1 1 1 1 1
XFMR	TRANSFORMER	A2.11	FIRST FLOOR DEMOLITION PLAN - AREA A	11 NOV 2024 11 NOV 2024	100% Construction Documents
		A2.12 A2.13	FIRST FLOOR DEMOLITION PLAN - AREA B SECOND FLOOR DEMOLITION PLAN - AREA A	11 NOV 2024 11 NOV 2024	100% Construction Documents100% Construction Documents
		A2.14	SECOND FLOOR DEMOLITION PLAN - AREA B	11 NOV 2024	100% Construction Documents
		A2.15 A2.16	THIRD FLOOR DEMOLITION FLOOR PLAN - AREA A THIRD FLOOR DEMOLITION FLOOR PLAN - AREA B	11 NOV 2024 11 NOV 2024	100% Construction Documents100% Construction Documents
		A2.21	FIRST FLOOR COMPOSITE PLAN	11 NOV 2024	100% Construction Documents
		A2.22 A2.23	SECOND FLOOR COMPOSITE PLAN THIRD FLOOR COMPOSITE PLAN	11 NOV 2024 11 NOV 2024	100% Construction Documents100% Construction Documents
		A2.24 A2.31	ROOF COMPOSITE PLAN FIRST FLOOR PLAN - AREA A	11 NOV 2024 11 NOV 2024	100% Construction Documents100% Construction Documents
		A2.32	FIRST FLOOR PLAN - AREA B	11 NOV 2024	100% Construction Documents
		A2.33 A2.34	SECOND FLOOR PLAN - AREA A SECOND FLOOR PLAN - AREA B	11 NOV 2024 11 NOV 2024	100% Construction Documents100% Construction Documents
		A2.35 A2.36	THIRD FLOOR PLAN - AREA A THIRD FLOOR PLAN - AREA B	11 NOV 2024 11 NOV 2024	100% Construction Documents 100% Construction Documents
		A2.37	ROOF PLAN - AREA A	11 NOV 2024 11 NOV 2024	100% Construction Documents
		A2.38 RD1.00	ROOF PLAN - AREA B DEMOLITION ROOF PLAN	11 NOV 2024 11 NOV 2024	100% Construction Documents100% Construction Documents
		R1.00	CONSTRUCTION ROOF PLAN	11 NOV 2024	100% Construction Documents
		R2.00 R2.01	ROOF DETAILS ROOF DETAILS	11 NOV 2024 11 NOV 2024	100% Construction Documents100% Construction Documents
		A2.41 A2.42	REFELECTED CEILING PLAN FIRST FLOOR- AREA A REFELECTED CEILING PLAN FIRST FLOOR- AREA B	11 NOV 2024 11 NOV 2024	100% Construction Documents 100% Construction Documents
		A2.43	REFELECTED CEILING PLAN SECOND FLOOR- AREA A	11 NOV 2024 11 NOV 2024	100% Construction Documents
		A2.44 A2.45	REFELECTED CEILING PLAN SECOND FLOOR- AREA B REFELECTED CEILING PLAN THIRD FLOOR- AREA A	11 NOV 2024 11 NOV 2024	100% Construction Documents 100% Construction Documents
		A2.46	REFELECTED CEILING PLAN THIRD FLOOR- AREA B	11 NOV 2024	100% Construction Documents
		A2.61 A2.62	FIRST FLOOR FINISH PLAN - AREA A FIRST FLOOR FINISH PLAN - AREA B	11 NOV 2024 11 NOV 2024	100% Construction Documents100% Construction Documents
		A2.63 A2.64	SECOND FLOOR FINISH PLAN - AREA A SECOND FLOOR FINISH PLAN - AREA B	11 NOV 2024 11 NOV 2024	100% Construction Documents100% Construction Documents
		A2.65	THIRD FLOOR FINISH PLAN - AREA A	11 NOV 2024	100% Construction Documents
		A2.66 A2.70	THIRD FLOOR FINISH PLAN - AREA B ENLARGED PLANS	11 NOV 2024 11 NOV 2024	100% Construction Documents100% Construction Documents
		A2.80 A2.81	ENLARGED TOILETROOM PLANS - BASE BID ENLARGED TOILETROOM PLANS - ALTERNATE #4	11 NOV 2024 11 NOV 2024	100% Construction Documents 100% Construction Documents
		A2.81 A2.82	ENLARGED TOILETROOM PLANS - ALTERNATE #4	11 NOV 2024 11 NOV 2024	100% Construction Documents
		A2.83 A2.84	ENLARGED TOILETROOM PLANS - ALTERNATE #4 ENLARGED TOILETROOM PLANS - ALTERNATE #4	11 NOV 2024 11 NOV 2024	100% Construction Documents100% Construction Documents
		A3.10	ELEVATIONS	11 NOV 2024	100% Construction Documents
		A3.11 A6.10	ELEVATIONS DOOR LEAF TYPE	11 NOV 2024 11 NOV 2024	100% Construction Documents100% Construction Documents
		A6.60 A8.10	PARTITION TYPES INTERIOR ELEVATIONS	11 NOV 2024 11 NOV 2024	100% Construction Documents100% Construction Documents
		A9.25	TILE INSTALLATION (FLOOR & WALL)	11 NOV 2024	100% Construction Documents
		A10.10 A10.11	COMMERCIAL CASEWORK (LEGEND & SCHEDULES) CASEWORK DETAILS	11 NOV 2024 11 NOV 2024	100% Construction Documents100% Construction Documents
		MECHANICAL			
		M0.01 M0.02	MECHANICAL SYMBOL LEGEND MECHANICAL GENERAL NOTES AND ABBREVIATIONS	11 NOV 2024 11 NOV 2024	100% Construction Documents 100% Construction Documents
		MD3.01	MECHANICAL DEMOLITION LEVEL 1 OVERALL PLAN	11 NOV 2024	100% Construction Documents
		MD3.04 MD3.07	MECHANICAL DEMOLITION LEVEL 2 OVERALL PLAN DEMOLITION LEVEL 3 OVERALL PLAN	11 NOV 2024 11 NOV 2024	100% Construction Documents100% Construction Documents
		MD4.01	MECHANICAL DEMOLITION ROOF PLAN	11 NOV 2024	100% Construction Documents
		M3.01 M3.04	LÉVEL 1 MECHANICAL OVERALL PLAN LÉVEL 2 MECHANICAL OVERALL PLAN	20 DEC 2024 11 NOV 2024	ADDENDUM #1 / 1 100% Construction Documents
		M3.07 M4.01	LEVEL 3 MECHANICAL OVERALL PLAN ROOF MECHANICAL OVERALL PLAN	11 NOV 2024 11 NOV 2024	100% Construction Documents 100% Construction Documents
		M9.01	MECHANICAL DETAILS	11 NOV 2024	100% Construction Documents
		M9.02 M10.01	MECHANICAL DETAILS MECHANICAL SCHEDULES	11 NOV 2024 20 DEC 2024	100% Construction Documents ADDENDUM #1 /1
		M10.02 M11.01	MECHANICAL SCHEDULES MECHANICAL CONTROLS	11 NOV 2024 11 NOV 2024	100% Construction Documents 100% Construction Documents
		M11.02 M11.03	MECHANICAL CONTROLS MECHANICAL CONTROLS	11 NOV 2024	100% Construction Documents 100% Construction Documents
			INICOLINIONE CONTINUES	11 NOV 2024	10070 CONSTRUCTION DOCUMENTS
		PLUMBING P0.01	PLUMBING SYMBOL LEGEND AND GENERAL NOTES	11 NOV 2024	100% Construction Documents
		PD3.01 PD3.02	DEMOLITION UNDERFLOOR - LEVEL 1 OVERALL PLAN DEMOLITION LEVEL 1 OVERALL PLAN	11 NOV 2024 11 NOV 2024	100% Construction Documents100% Construction Documents
		PD3.03	DEMOLITION LEVEL 2 OVERALL PLAN	11 NOV 2024	100% Construction Documents
		PD3.04 PD3.05	DEMOLITION LEVEL 3 OVERALL PLAN DEMOLITION ROOF PLAN	11 NOV 2024 11 NOV 2024	100% Construction Documents100% Construction Documents
		PD6.01	LEVEL 1 UNDERFLOOR DEMO PLUMBING PLANS ENLARGED	11 NOV 2024	100% Construction Documents
		PD6.02	LEVEL 1 DEMO PLUMBING PLANS ENLARGED	11 NOV 2024	100% Construction Documents

SHEET NAME

DATE REVISION

20 DEC 2024 ADDENDUM #1 1
11 NOV 2024 100% Construction Documents
20 DEC 2024 ADDENDUM #1 1
11 NOV 2024 100% Construction Documents P4.01 PLUMBING UNDERFLOOR - LEVEL 1 OVI P4.02 PLUMBING - LEVEL 1 OVERALL PLAN P4.03 PLUMBING - LEVEL 2 OVERALL PLAN P4.04 PLUMBING - LEVEL 3 OVERALL PLAN P4.05 PLUMBING - ROOF LEVEL OVERALL PLAN 11 NOV 2024 LEVEL 1 UNDERFLOOR PLUMBING PLANS ENLARGED 11 NOV 2024 LEVEL 1 PLUMBING PLANS ENLARGED 11 NOV 2024 LEVEL 2 PLUMBING PLANS ENLARGED 11 NOV 2024 P6.03 11 NOV 2024 LEVEL 3 PLUMBING PLANS ENLARGED P8.01 PLUMBING DETAILS 11 NOV 2024 PLUMBING SCHEDULES P9.01 11 NOV 2024 FIRE PROTECTION LEVEL 1 FIRE PROTECTION PLAN

ELECTRICAL GENERAL NOTES

LEVEL 2 DEMO PLUMBING PLANS ENLARGED LEVEL 3 DEMO PLUMBING PLANS ENLARGED

100% Construction Documents

11 NOV 2024 100% Construction Documents

11 NOV 2024 ELECTRICAL LEGEND & ABBREVIATIONS

ELECTRICAL E0.01 E0.02 11 NOV 2024 ED2.01 11 NOV 2024 DEMOLITION SITE PLAN 11 NOV 2024 DEMOLITION LEVEL 1 POWER PLAN DEMOLITION LEVEL 2 POWER PLAN 11 NOV 2024 ED5.01 DEMOLITION LEVEL 1 LIGHTING PLAN A 11 NOV 2024 ED5.02 DEMOLITION LEVEL 1 LIGHTING PLAN B 11 NOV 2024 ED5.03 DEMOLITION LEVEL 2 LIGHTING PLAN A 11 NOV 2024 11 NOV 2024 DEMOLITION LEVEL 2 LIGHTING PLAN B DEMOLITION LEVEL 3 LIGHTING PLAN A 11 NOV 2024 11 NOV 2024 DEMOLITION LEVEL 3 LIGHTING PLAN B 11 NOV 2024 DEMOLITION ROOF PLAN 11 NOV 2024 SITE PLAN

ED5.04 ED5.05 ED5.06 ED7.01 E2.01 E3.01 LEVEL 1 POWER OVERALL PLAN 11 NOV 2024 E3.02 LEVEL 2 POWER OVERALL PLAN 11 NOV 2024 LEVEL 3 POWER OVERALL PLAN LEVEL 1 LIGHTING PLAN A LEVEL 1 LIGHTING PLAN B LEVEL 2 LIGHTING PLAN A 20 DEC 2024 LEVEL 2 LIGHTING PLAN B 20 DEC 2024 LEVEL 3 LIGHTING PLAN A

LEVEL 3 LIGHTING PLAN B E5.06 SITE PLAN LIGHTING CONTROLS LEVEL 1 LIGHTING CONTROLS PLAN A LEVEL 1 LIGHTING CONTROLS PLAN B LEVEL 2 LIGHTING CONTROLS PLAN A LEVEL 2 LIGHTING CONTROLS PLAN B LEVEL 3 LIGHTING CONTROLS PLAN A

ROOF POWER PLAN LIGHTING CONTROLS DETAILS LIGHTING CONTROLS DETAILS LIGHTING CONTROLS DETAILS LIGHTING CONTROLS DETAILS E10.04 E10.05 **ELECRICAL DETAILS**

ELECTRICAL SCHEDULES E12.01 LEVEL 1 LIGHTING OVERALL E12.02 LEVEL 2 LIGHTING OVERALL E12.03 LEVEL 3 LIGHTING OVERALL FA4.01 FIRE ALARM LEVEL 1 OVERALL

11 NOV 2024 11 NOV 2024 11 NOV 2024 FIRE ALARM LEVEL 2 OVERALL 11 NOV 2024 FIRE ALARM LEVEL 3 OVERALL

W University Blvd

100% Construction Documents 11 NOV 2024 100% Construction Documents

100% Construction Documents 100% Construction Documents 100% Construction Documents 100% Construction Documents 100% Construction Documents 100% Construction Documents 100% Construction Documents 100% Construction Documents

100% Construction Documents 100% Construction Documents 100% Construction Documents 100% Construction Documents 100% Construction Documents 100% Construction Documents 100% Construction Documents

11 NOV 2024 100% Construction Documents 11 NOV 2024 100% Construction Documents
20 DEC 2024 ADDENDUM #1 ADDENDUM #1 ADDENDUM #1 100% Construction Documents

11 NOV 2024 100% Construction Documents 11 NOV 2024 100% Construction Documents 11 NOV 2024 100% Construction Documents
20 DEC 2024 ADDENDUM #1

20 DEC 2024 ADDENDUM #1 20 DEC 2024 ADDENDUM #1 11 NOV 2024 100% Construction Documents LEVEL 3 LIGHTING CONTROLS PLAN B 11 NOV 2024 100% Construction Documents 11 NOV 2024 100% Construction Documents 11 NOV 2024 100% Construction Documents 20 DEC 2024 ADDENDUM #1 1 11 NOV 2024 100% Construction Documents

11 NOV 2024 100% Construction Documents 11 NOV 2024 100% Construction Documents 11 NOV 2024 100% Construction Documents 11 NOV 2024 100% Construction Documents 100% Construction Documents 100% Construction Documents 100% Construction Documents FA4.02 100% Construction Documents 11 NOV 2024 100% Construction Documents FA4.03

W University Blvd

Linnet Ln

Wren Way

Waneta Dr

SCHOOL LOCATION

Dallas + Houston + Austin

143 Manufacturing Street Dallas Texas 75207

kirksey.com

214 522 1100



These drawings have been prepared as one coordinated set of

drawings and are complimentary. What is required by one

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DATE ISSUE A 11 NOV 2024 100% Construction Documents 1 20 DEC 2024 ADDENDUM #1

_______ ______

______ ______ -----PROJECT NAME ORG 194 K.B. Polk Center for

Academically Talented & Gifted

PROJECT ADDRESS 6911 Victoria Ave, Dallas, TX

2023351 KIRKSEY PROJECT NO. KEY PLAN

SHEET TITLE ABBREVIATIONS AND SHEET

SHEET NUMBER

© 2023 Kirksey

W University

Wateka Dr

Drane Dr


Wenonah Dr

Nakoma Dr

- Waneta Dr


Montrose Dr

W Mockingbird Ln

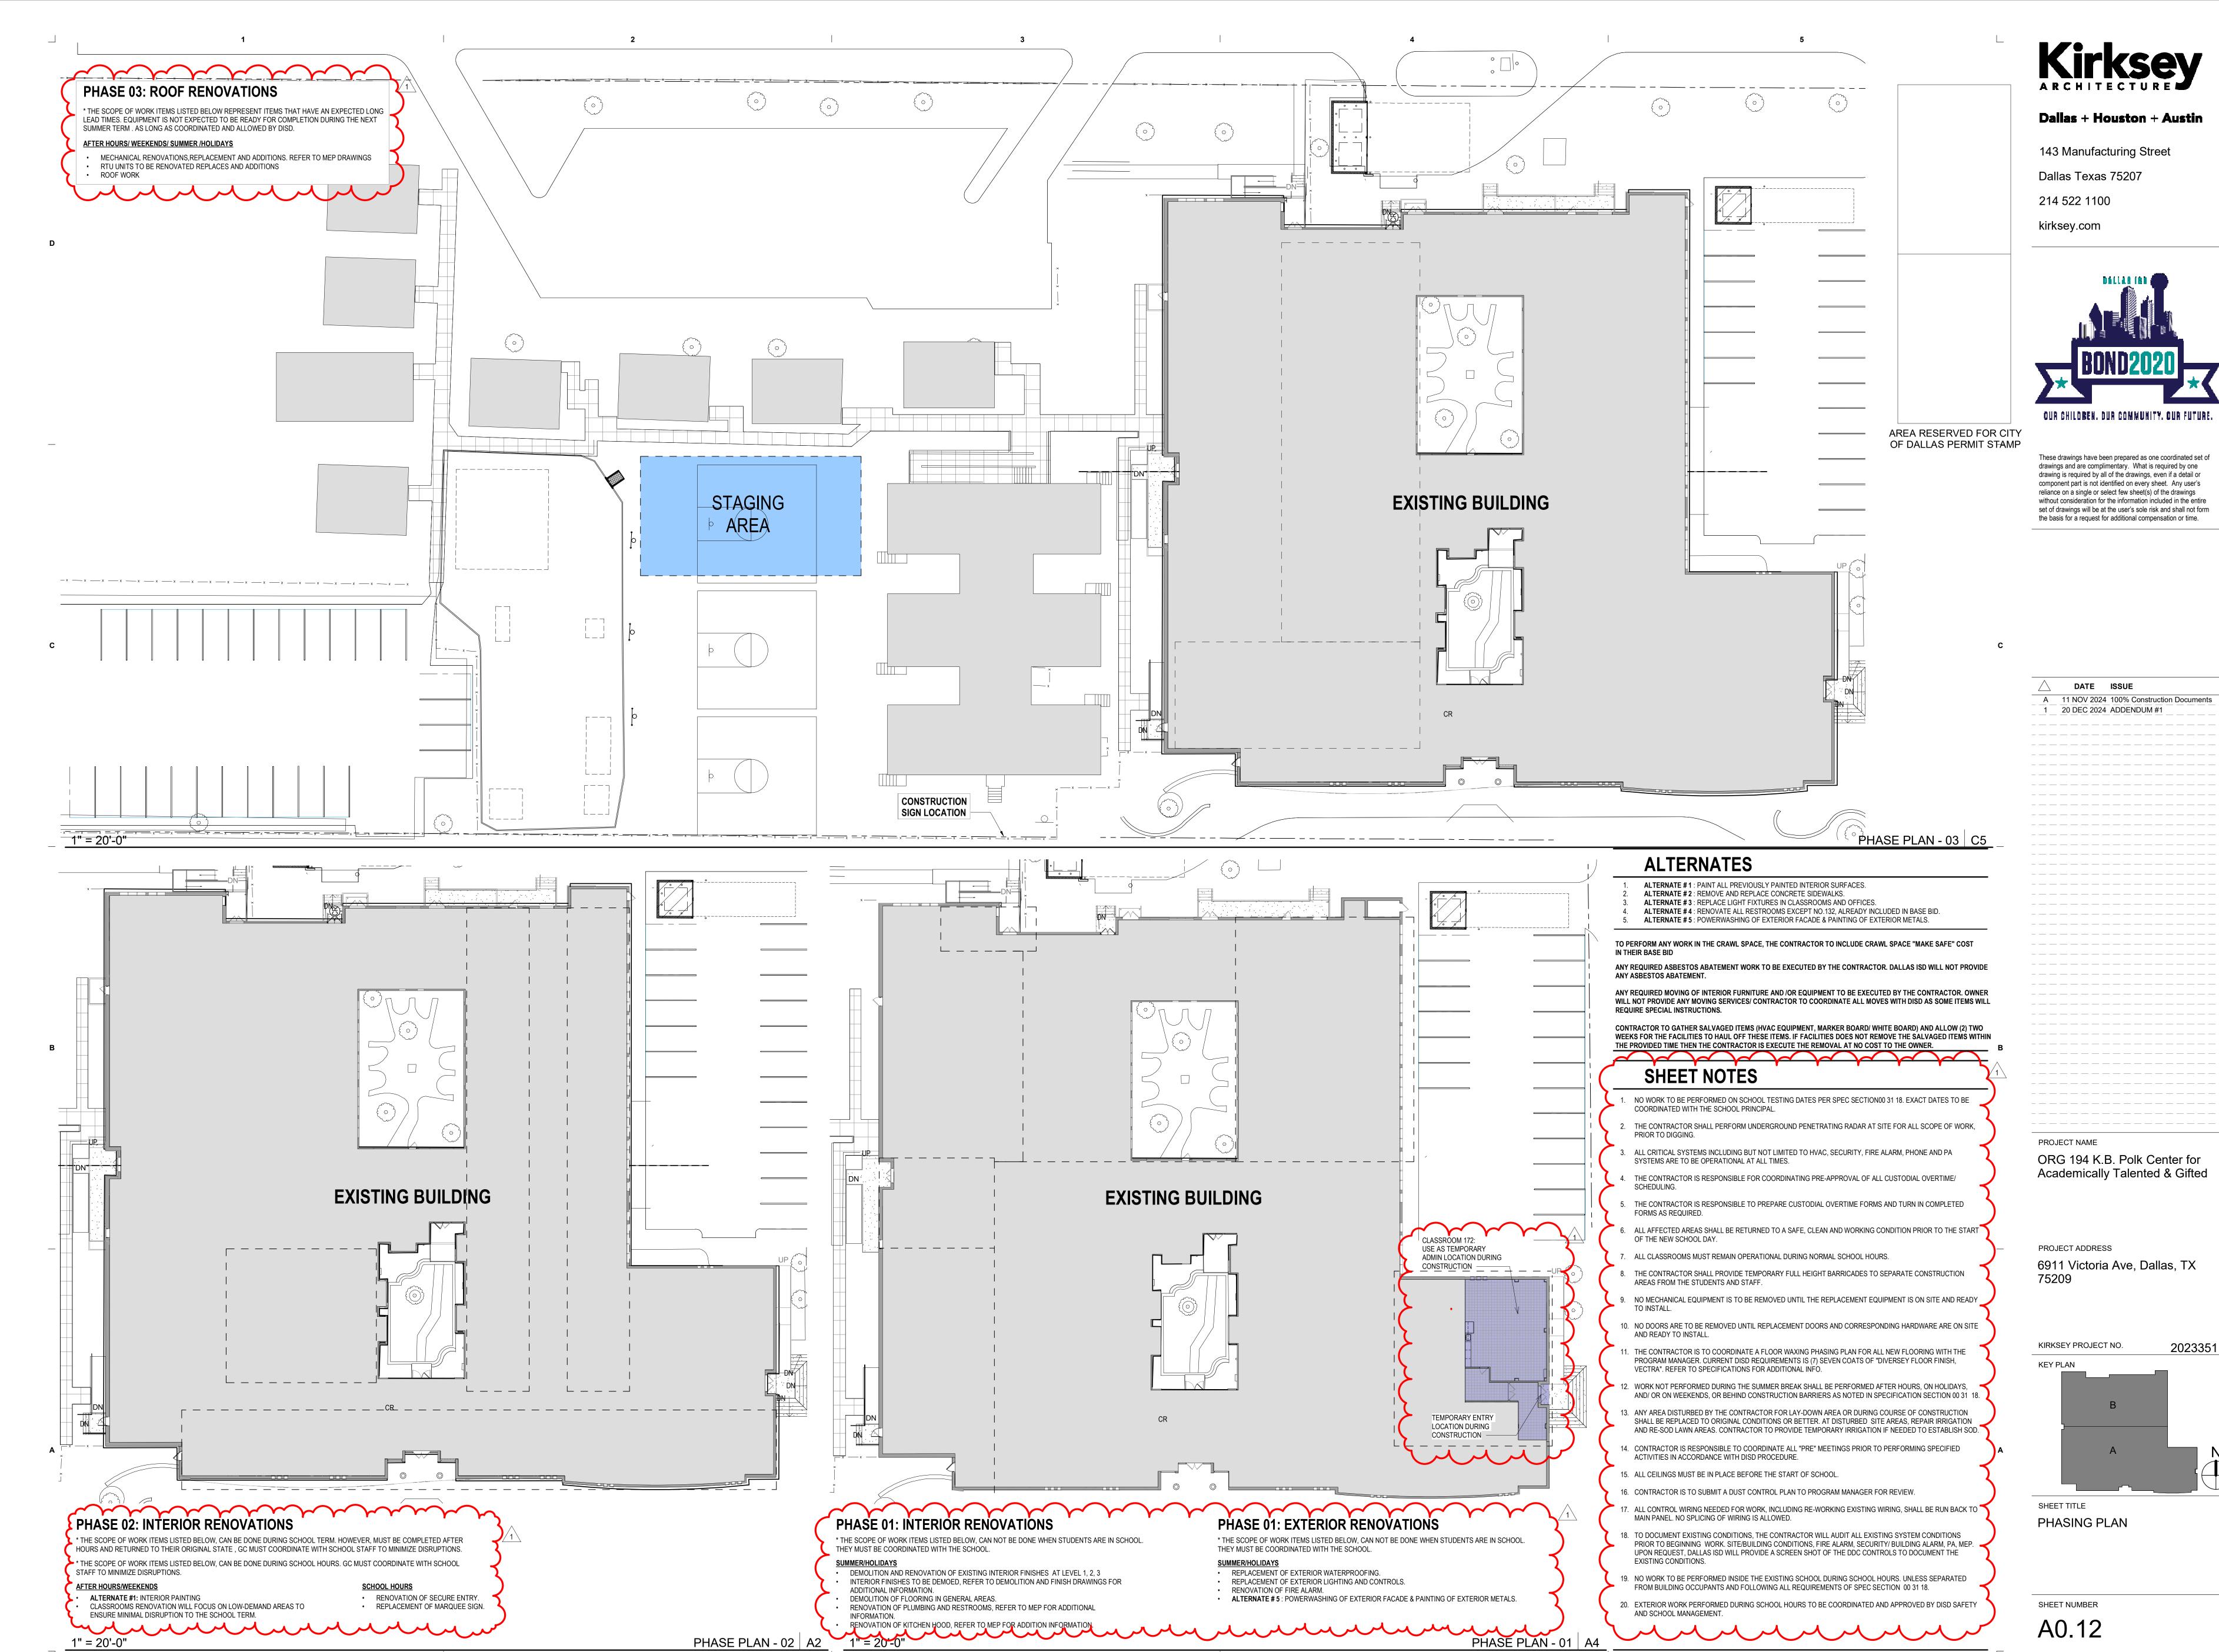

PHASE PLAN - 02 | A2

1" = 20'-0"

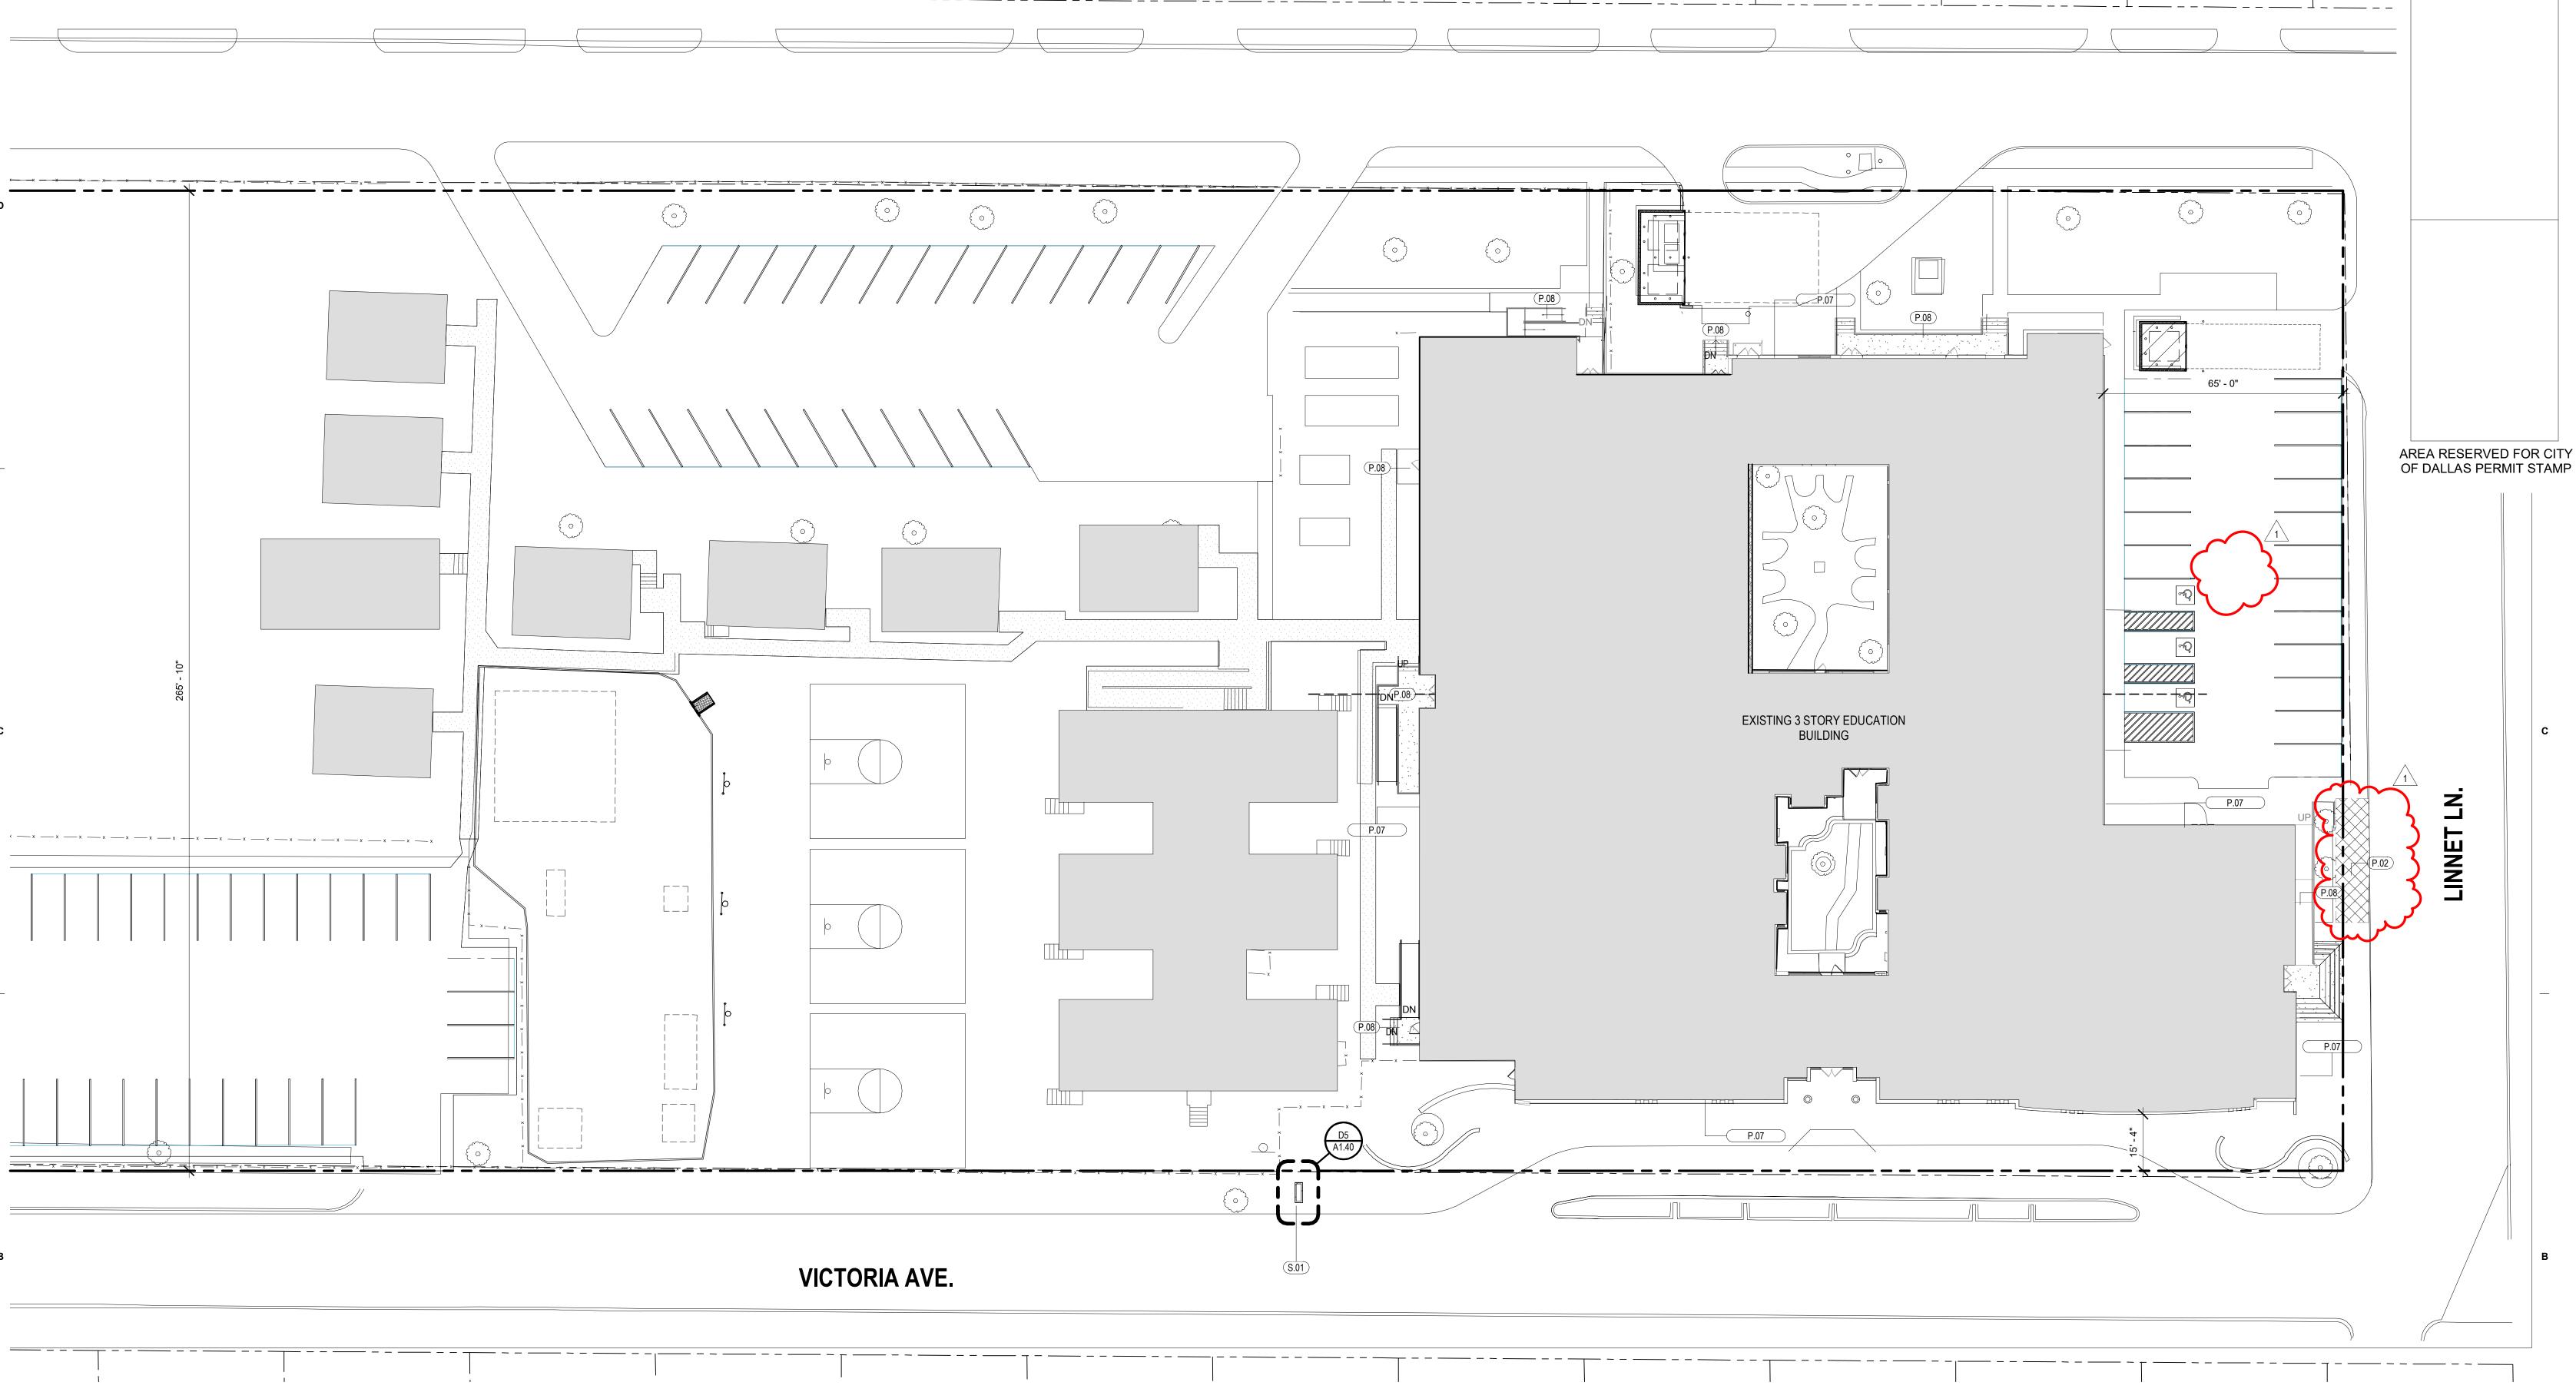



Dallas + Houston + Austin

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Dallas Texas 75207 214 522 1100

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A 11 NOV 2024 100% Construction Documents 1 20 DEC 2024 ADDENDUM #1

PROJECT NAME ORG 194 K.B. Polk Center for Academically Talented & Gifted

PROJECT ADDRESS

SITE PLAN B5

6911 Victoria Ave, Dallas, TX 75209

2023351 KIRKSEY PROJECT NO. KEY PLAN

SHEET TITLE SITE PLAN

SHEET NUMBER A1.20

© 2023 Kirksey



1" = 20'-0"









ALTERNATE #2: REMOVE AND REPLACE CONCETE SIDEWALKS. GC TO ACCOUNT FOR APPROXIMENT 300 SQFT.

ALTERNATE #5: POWER WASH EXTERIOR BUILDING FACADES OF MAIN BUILDING. ALTERNATE #5: PAINTING OF MISCELLANEOUS EXTERIOR METALS, SUCH AS HANDRAILS, CANOPY

COLUMNS, DOOR FRAMES, ETC. REF: SPECS

NEW MARQUEE SIGN


KEY NOTES

SHEET NOTES

ARCHITECTURAL SITE PLAN IS FOR REFERENCE ONLY. GENERAL CONTRACTOR AND SUBCONTRACTORS SHALL COORDINTATE THE SITE WORK WITH ALL CONSTRUCTION DOCUMENTS. ANY CONFLICTS BETWEEN THE DOCUMENTS SHALL BE BROUGHT TO THE ATTENTION OF THE ARCHITECT IMMEDIATELY FOR CLARIFICATION.

GENERAL CONTRACTOR AND SUBCONTRACTORS SHALL CONFORM TO ALL REQUIREMENTS AS REQUIRED BY THE CITY OF DALLAS AND ALL AUTHORITIES HAVING JURISDICTION.

- 3. REFERENCE THE ELECTRICAL (MEP SITE) DOCUMENTS FOR ADDITIONAL SITE INFORMATION TO INCLUDE, BUT NOT LIMITED TO THE FOLLOWING: A. LOCATIONS AND SIZES FOR SITE LIGHTING AND LIGHTING ELEMENTS B. LOCATIONS FOR TELEPHONE/CABLE/DATA BOXES. C. LOCATIONS AND SIZES FOR PULL BOXES FOR LIGHTING ELEMENTS. D. COORDINATION INFORMATION FOR EXTERIOR BUILDING ILLUMINATION AND UTILITIES.
- 4. PROTECT ALL EXISTING TREES TO REMAIN DURING CONSTRUCTION
- 5. GENERAL CONTRACTOR TO IDENTIFY ALL LOCATION FOR RE-PAINTING OF EXTERIOR METALS.
- 6. GENERAL CONTRACTOR TO IDENTIFY ALL LOCATION FOR EXTERIOR POWERWASHING OF FAÇADE.
- 7. GENERAL CONTRACTOR TO IDENTIFY ALL LOCATION FOR REPLACEMENT OF CONCETE SIDEWALKS.

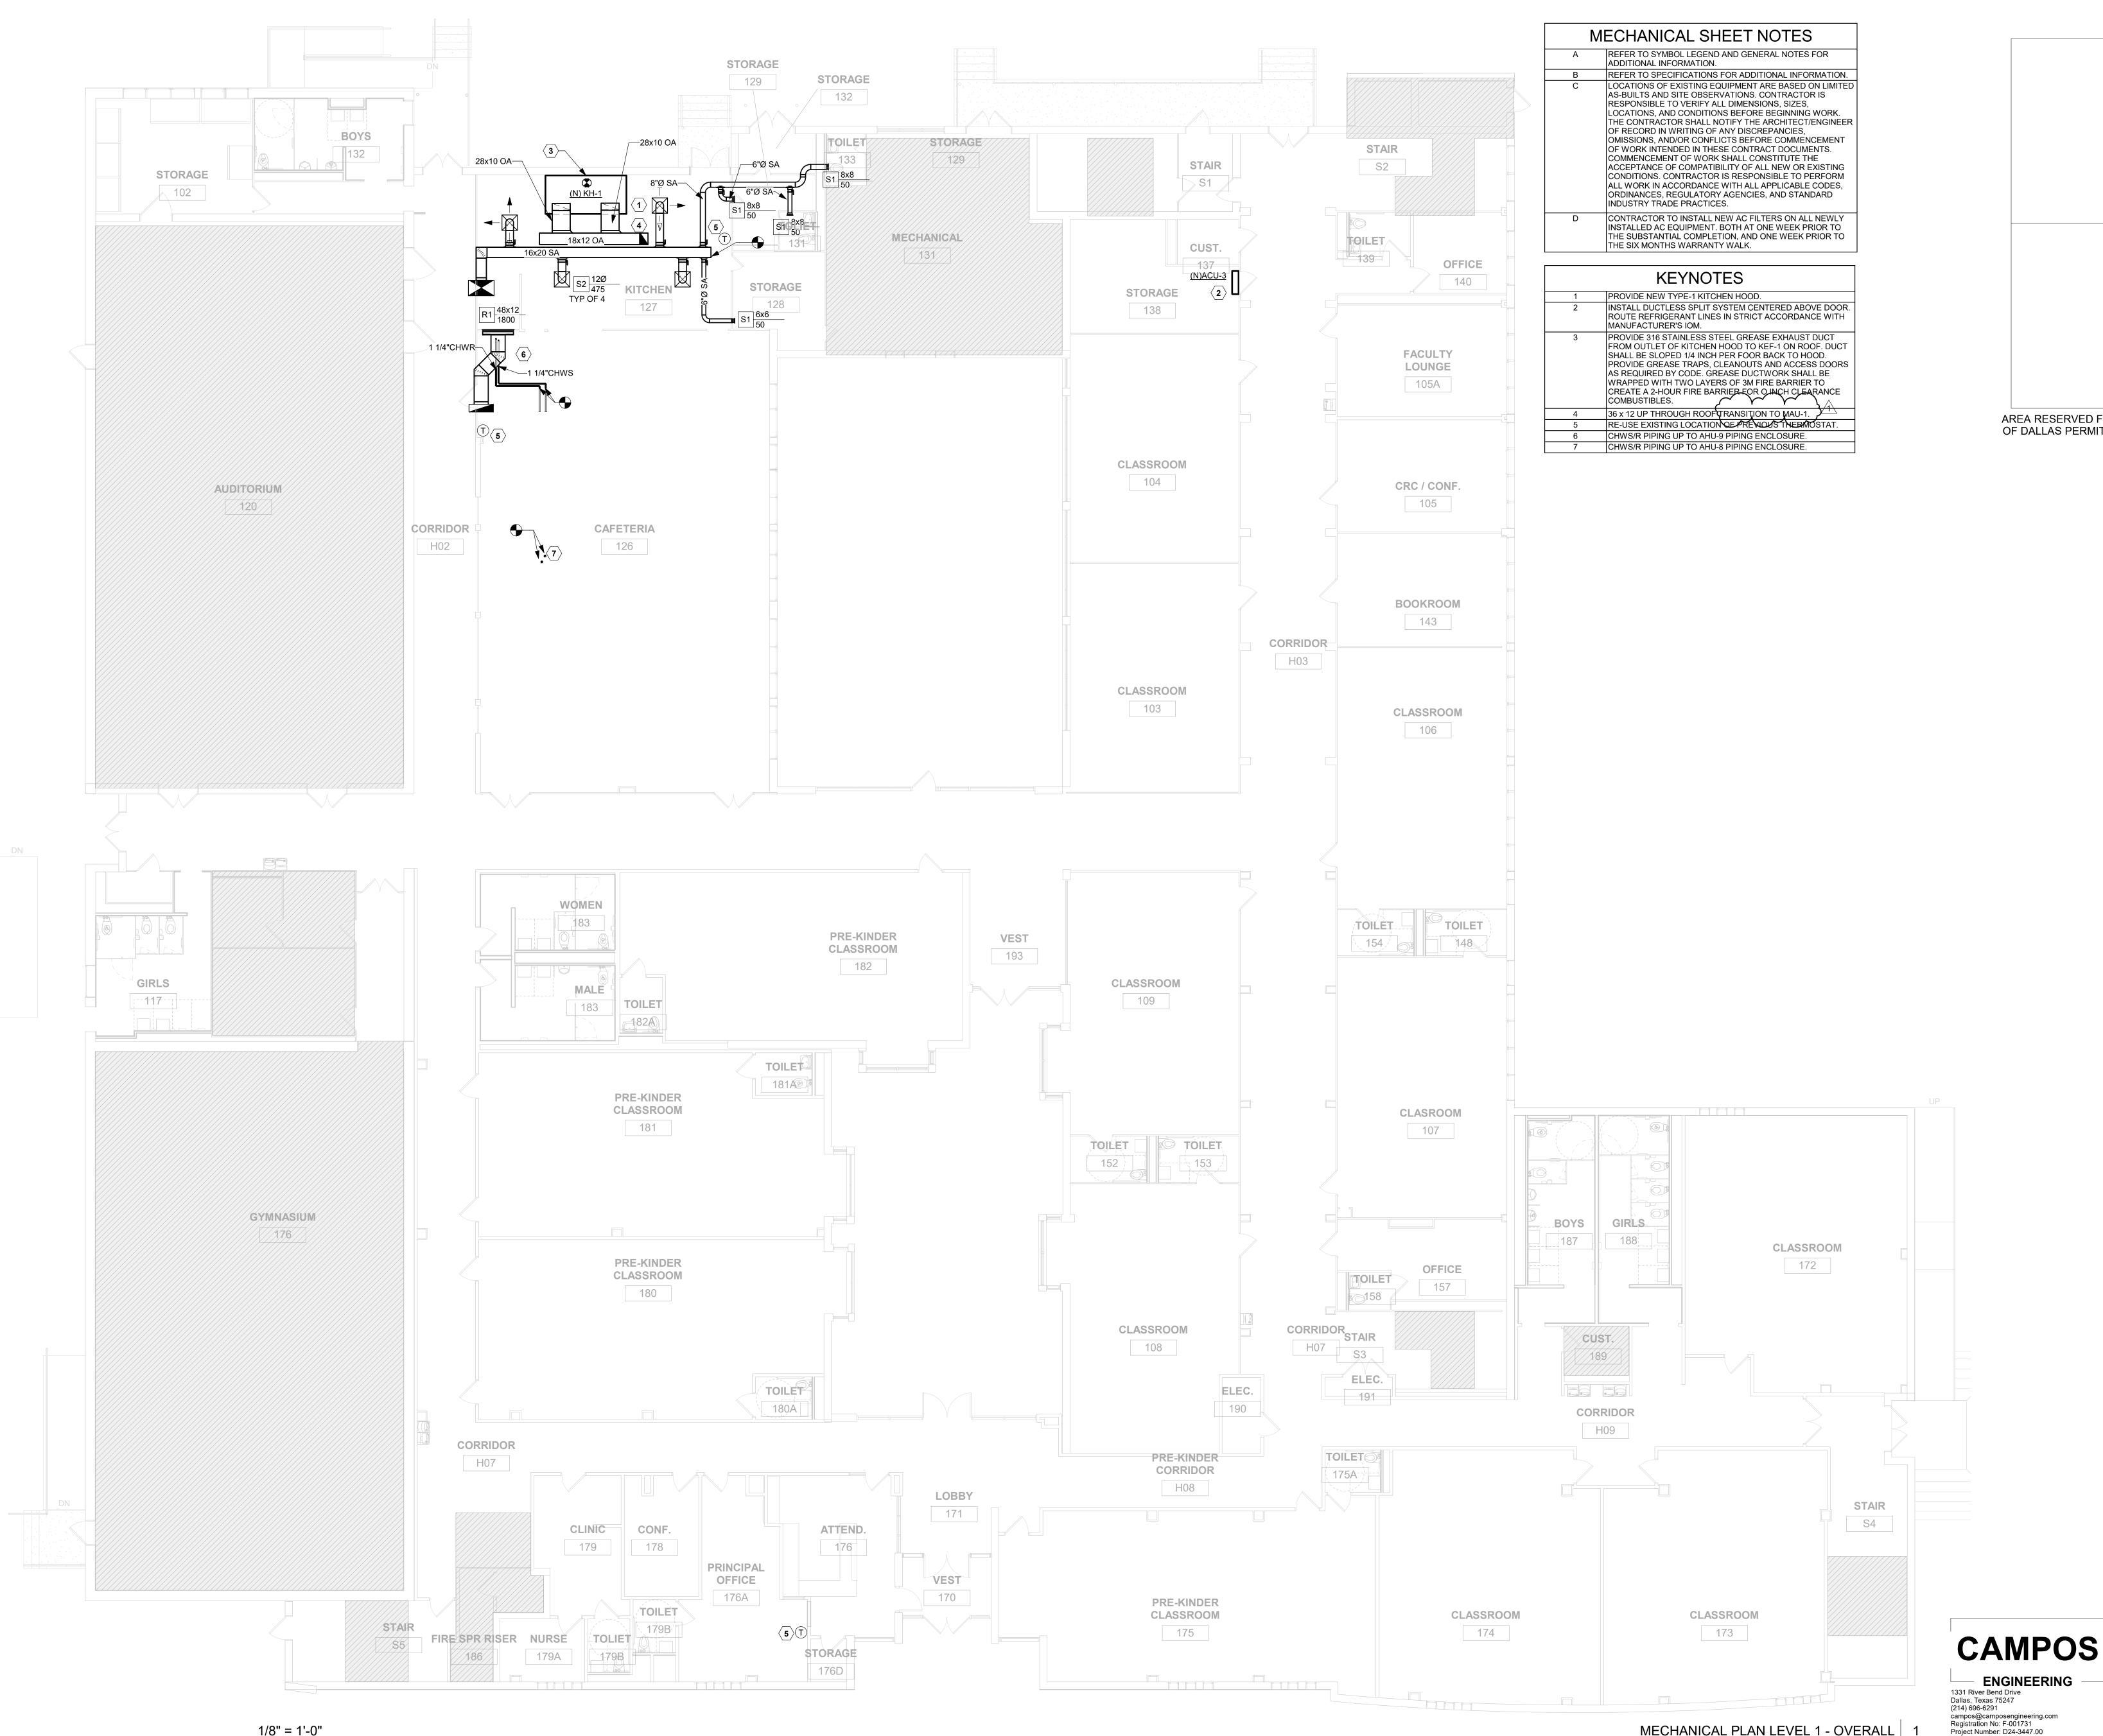



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DATE ISSUE A 11 NOV 2024 100% Construction Documents __ 1 __ 20 DEC 2024_ADDENDUM #1 __ _ _ _ _ _


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PROJECT NAME Org 194 K.B. Polk Center for Academically Talented & Gifted

PROJECT ADDRESS 6911 Victoria Ave, Dallas, TX



SHEET TITLE LEVEL 1 MECHANICAL OVERALL PLAN

> SHEET NUMBER M3.01

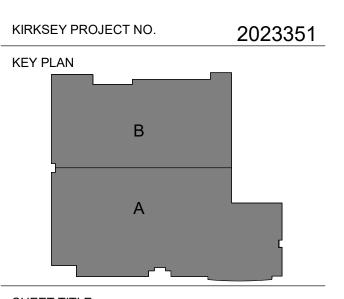1/8" = 1'-0"

MECHANICAL PLAN LEVEL 1 - OVERALL 1

													CI	HILLE	WAT	ER AIR	HAND	LING	UNIT	WITH I	ELECT	TRIC H	EAT S	SCHED	ULE									
						SU	PPLY FA	AN					ELEC.	TRIC HEAT	ING					N	ET COOLI	ING PERFO	ORMANCE	DATA					POWE	R CONN.				
MARK AHU-	ARRANGMENT	V PH OTY				ЦΒ	EAT	LAT	МВН	KW	NO.						O.D. E.A.T. L.A.T. WATER						V	ВП	PH MCA MOCP		MANUFACTURER MAKE AND MODEL	Weight	REMARKS					
7		DES	MIN	DES	M	ΛIN	S.P.	v	FN	QII	ПР	EAI	LAI	IVIDI	rvv	STAGES	TOTAL	SENS.	LAT.	D.B.	D.B.	W.B.	D.B.	E.W.T.	L.W.T.	GPM	MAX P.D.	"	FN	IVICA	IVIOCE		Lbs	
2	DOWNFLOW	14600	4380	3810	35	595	4.5	460	3	2	15	24.8	55	145.7	50.0	SCR	1144.0	712	432.0	105	82	67	55	44	54	229	20	460	3	214	225	CARRIER 39MW30W	8705	ALL
3	DOWNFLOW	17125	5140	6295		510	4.5	460	3	2	15	6.3	55	275.3	80.7	SCR	983.3	630.0	353.3	105	84	68	55	44	54	197	20	460	3	316	350	CARRIER 39MW36W	9666	ALL
4	DOWNFLOW	18300	5490	5085	50	085	4.5	460	3	2	15	21.8	55	200.3	60.0	SCR	1113.0	713.0	400.0	105	82	67	55	44	54	223	20	460	3	295	300	CARRIER 39MW40W	9386	ALL
8	DOWNFLOW	5000	5000	2500		-	1.0	460	3	1	3	44.0	95	280.5	90.0	SCR	403.0	244.0	159.0	105	88	70	55	44	54	81	20	460	3	99	100	CARRIER 39MW10W	4164	ALL EXCEPT 13
9	DOWNFLOW	2100	2100	300		-	1.0	460	3	1	2	62.6	95	74.9	25.0	SCR	86.0	71.0	15.0	105	79	65	55	44	54	17	20	460	3	33	35	CARRIER 39MW06W	3488	ALL EXCEPT 13

1. EXTERNAL STATIC PRESSURE ("WG") INCLUDES DUCTWORK, BALANCING DAMPERS AND AIR DEVICES ONLY.

2. UNITS SHALL PERFORM TO LISTED CAPACITIES. UNIT PERFORMANCE MUST SATISFY BOTH SENSIBLE AND LATENT CAPACITY REQUIREMENTS.

3. DESIGN BASIS IS CARRIER. CONTRACTOR IS RESPONSIBLE FOR VARIATIONS IN FIT AND ELECTRICAL SERVICE. 6. PROVIDE WITH TERMINAL STRIP FOR CONTROL SYSTEM INTERFACE - COORDINATE WITH CONTROLS CONTRACTOR.

7. PROVIDE WITH 2" MERV-13 FILTERS.

8. PROVIDE SUPPLY FAN WITH VARIABLE FREQUENCY DRIVE AND SHAFT GROUNDING. PROVIDE NEMA 3R BOX FOR VFD.

9. PROVIDE WITH ENTHALPY ECONOMIZER AND BAROMETRIC RELIEF. PROVIDE ECONOMIZER WITH IECC COMPLIANT FAULT DETECTION AND DIAGNOSTICS CAPABILITY.

10. PROVIDE WITH RETURN AIR SMOKE DETECTOR INTERLOCKED TO SUPPLY FAN

11. PROVIDE WITH INTEGRAL DISCONNECT AND UNPOWERED GFCI WEATHER PROOF RECEPTACLE RECEPTACLE

12. PROVIDE WITH STAINLESS STEEL OR CORROSION RESISTANT CONDENSATE DRAIN PAN 13. PROVIDE WITH FAN ARRAY.

14. PROVIDE TWO CIRCUITS. ONE CIRCUIT FOR FAN. ONE CIRCUIT FOR HEATERS.

												PACKA	GED R	OOFT	OP UN	IT WIT	H ELEC	TRIC	HEAT	SCHE	DULE									
				S	UPPLY FA	AN .				ELECTRIC	HEATING	G		NE	T COOLIN	G PERFORM	MANCE DAT	A		СОМРІ	RESSOR	COND	ENSER		POWE	R CONN.				
MARK RTU-	ARRANGEMENT	SUPP	LY CFM	O/A	CFM	EXT.	OTV	ЦD	EAT	LAT	LC/A/	NO.	CAP	ACITY (ME	BH)	O.D.	ENTER	RING	MIN.	QTY	REF.	NO.	H.P.	\ \ \ \ \ \ \ \ \ \ \ \ \ \ \ \ \ \ \	DLI	MCA	MOCP	MANUFACTURER MAKE AND MODEL	UNIT WEIGHT (LBS.)	REMARKS
		DES	MIN	DES	MIN	S.P.	QII	пР	EAI	LAI	KW	STAGES	TOTAL	SENS.	LAT.	D.B.	D.B.	W.B.	IEER	QIT	TYPE	FANS	EACH		PH	MCA	IVIOCP	7 at 5 model	(250.)	
1	DOWNFLOW	8000	8000	1220	800	0.8	1	3	62.1	90	70.0	2	219.0	145.1	73.9	105	79	67	13.2	2	R454B	2	3.26	460	3	100	110	TRANE TSK240	2125	ALL

1. EXTERNAL STATIC PRESSURE ("WG") INCLUDES DUCTWORK, BALANCING DAMPERS AND AIR DEVICES ONLY.

2. UNITS SHALL PERFORM TO LISTED CAPACITIES. UNIT PERFORMANCE MUST SATISFY BOTH SENSIBLE AND LATENT CAPACITY REQUIREMENTS.

9. PROVIDE WITH DRY BULB ECONOMIZER AND BAROMETRIC RELIEF. PROVIDE ECONOMIZER WITH IECC COMPLIANT FAULT DETECTION AND DIAGNOSTICS CAPABILITY.

3. DESIGN BASIS IS TRANE. CONTRACTOR IS RESPONSIBLE FOR VARIATIONS IN FIT AND ELECTRICAL SERVICE.

4. PROVIDE GALVANIZED INSULATED FACTORY ROOF CURB TO MATCH ROOF SLOPE. 5. PROVIDE FACTORY HAIL GUARD.

6. PROVIDE WITH TERMINAL STRIP FOR CONTROL SYSTEM INTERFACE - COORDINATE WITH CONTROLS CONTRACTOR.

PROVIDE WITH 2" MERV-13 FILTERS.

8. PROVIDE SUPPLY FAN WITH VARIABLE FREQUENCY DRIVE WITH SHAFT GROUNDING

10. PROVIDE WITH RETURN AIR SMOKE DETECTOR INTERLOCKED TO SUPPLY FAN

11. PROVIDE WITH INTEGRAL DISCONNECT AND UNPOWERED GFCI RECEPTACLE

12. PROVIDE WITH STAINLESS STEEL OR CORROSION RESISTANT CONDENSATE DRAIN PAN

13. PROVDE WITH 2-STAGE COMPRESSOR

14. PROVIDE WITH SINGLE POINT POWER CONNECTION.

										MAK	E UP A	AIR UI	NIT U	NIT S	CHED	ULE													
						MAX				E	ELECTRICA	AL INFOR	RMATION					COOL	ING INF	ORMATION					C	GAS HEAT IN	NFORMA	TION	
MARK	QTY	DOAS/RTU MODEL #	MANUFACTURER	BLOWER	RETURN AIR CFM	OUTSIDE	TOTAL CFM	WEIGHT (LBS)	ESP	μр	DUASE V	VOLT	MCA	MOCD	OUTSIDE AIR			AVING AII	R	CAPACI	TY MBH	IEED	ICMDE	CAC TVDE	INPUT	OUTPUT	TEMP	REQUIRED INPUT GAS	NOTES
					AII OI III	AIR CFM	01 111	(LDO)		HP	PHASE	VOLT	WICA	MIOCP	DB	WB	DB	WB	DP	TOTAL	SENS.	IEER	ISWIKE	GAS TYPE	BTUs	BTUs	RISE	PRESSURE	
MUA-1	1	CAS-HVAC1-I.100-13-4T-MPU	CAPTIVEAIRE	13P-1	0	1320	1320	1154	0.50	1.50	3	208	23.9	25.0	99.0	64.7	74.4	64.7	59.6	52.8	33.1	17.9	6.1	NATURAL	90123	73000	48 °F	7 IN. W.C 14 IN. W.C.	ALL

1. INVERTER SCROLL COMPRESSOR WITH INTEGRATED OIL SENSOR. DIGITAL OR STAGED SCROLL NOT AN APPROVED EQUAL.

2. DIRECT DRIVE PLENUM BLOWER. BELT DRIVEN BLOWERS ARE NOT ACCEPTABLE. 3. INTEGRATED MONITORING VIA CELLULAR CONNECTION BY MANUFACTURER.

4. REFRIGERATION PRESSURE MONITORING ON HIGH AND LOW PRESSURE SIDE OF SYSTEM INCLUDED THROUGH DIGITAL INTERFACE.

5. EC MOTOR CONDENSING FANS.

6. ELECTRONIC EXPANSION VALVE. TXV NOT ACCEPTABLE.

7. SUCTION LINE ACCUMULATOR. 8. FACTORY COMMISSIONING WITH 5 YEAR PARTS WARRANTY, 25 YEAR WARRANTY ON STAINLESS STEEL HEAT EXCHANGER.

9. AVERAGING INTAKE, EVAP AND DISCHARGE TEMPERATURE SENSORS (DISCHARGE SENSOR TO BE FACTORY MOUNTED WITHIN UNIT). 10. 81% EFFICIENT FURNACE, WITH MODULATING INDUCER TO MAINTAIN CONSTANT COMBUSTION EFFICIENCY ACROSS FIRING RANGE. 6:1 TURNDOWN WITH NG AND 5:1 TURNDOWN WITH LP.

11. SUPPLY CFM MONITORING INTEGRAL TO UNIT WITH CFM MEASUREMENT INCLUDED THROUGH DIGITAL INTERFACE.

12. HAIL GUARD FOR CONDENSING COIL.

13. 1" EXTERIOR DUAL-WALL CONSTRUCTION W/ R-4.3 INSULATION-MINIMUM 24GA EXTERIOR W/ 18GA BASE.

												DX S	PLIT SYSTE	M WIT	H EL	ECTRIC	НЕАТ	г ѕсн	EDULI	E										
	AIR HANDLER												AIR COOLED CONDENSING UNIT									COOLING PERFORMANCE DATA					1			
MARK								DOWER	CONNEC	PTION	AUX. HEATING		UNIT	COMP	PRESSORS		FANS	DOWED CONNECTION		UNI		CAPACITY (MBH)		BU)	O.D. ENTERING MIN D.B. D.B. W.B. SEER/		DEMARKS			
WARK	ARRANGEMENT	SERVES	UNIT CFM	O/A CFM				POWER CONN		TION	STAGES	ES TOT.	MANUFACTURER AND MODEL NO.	WEIGHT	1 10 1 10 2 11 11 0		TYPE NO. H.P.		POWER CONNECTION		MANUFACTURER AND MODEL NO.			WEIGHT			БП)	SEER/	R/ REMARKS	
						-	V.	Ph.	MCA	MOCP	STAGES	KW		(LBS)	NO.	EACH		NO. H.F.	V. Ph	. MCA	МОСР		_(LBS)	TOTAL	LAT	SENS	F.	F. F.	(EER)	<u> </u>
ACU/CU-2	HORIZONTAL	COMPUTER	2,000	410	0.5	1	460	3	31.0	36.0	3	18.89	TRANE GA	180	1	7.6	R454B	1 1/5	460 3	9	15.0	TRANE 4TTA	211	53.8	16.9	36.9	105	80 65	13.4	1,2,3,4,5,6,7,9
AHU-5	VERTICAL	ADMIN	2,600	300	1	1	460	3	37.0	40.0	SCR	21.02	TRANE BCVE	470	2	8.1	R454B	1 1/5	460 3	22	25.0	TRANE TTA	432	93.0	20.0	73.0	105	78 64	(14.8)	ALL
															7									, 						

1. AIR HANDLER WIRING INCLUDES AUX. HEATING.

2. EXTERNAL STATIC PRESSURE ("WG") INCLUDES DUCTWORK, BALANCING DAMPERS AND AIR DEVICES ONLY

3. SIZE, ROUTE, INSULATE AND PROVIDE APPURTENANCES FOR DX PIPING SYSTEMS, PER MANUFACTURER RECOMMENDATIONS 4. LISTED CAPACITIES ARE FOR THE AIR HANDLER UNIT AND CONDENSER UNIT COMBINATION, UNITS SHALL PERFORM TO LISTED CAPACITIES.

5. TRANE IS THE BASIS FOR DESIGN. ACCEPTABLE ALTERNATE MANUFACTURER'S ARE: TRANE AND YORK - NO EXCEPTIONS. CONTRACTOR IS RESPONSIBLE FOR VARIATIONS IN FIT AND ELECTRICAL SERVICE.

6. PROVIDE FILTER DRYER AND SIGHT GLASS ON THE DX LINES

7. FOR LONG DX LINE RUNS, USE MANUFACTURER'S RECOMMENDED LONG LINE INSTALLATION GUIDELINES

8. PROVIDE WITH DRY BULB ECONOMIZER.

9. PROVIDE WITH 2" MERV-13 FILTERS. 10. PROVIDE WITH INTEGRAL DISCONNECT SWITCH AND UNPOWERED GFCI RECEPTACLE.

11. PROVIDE WITH STAINLESS STEEL OR CORROSION RESISTANT CONDENSATE DRAIN PAN.

12. PROVIDE WITH TERMINAL STRIP FOR CONTROL SYSTEM INTERFACE - COORDINATE WITH CONTROLS CONTRACTOR.

	KITCHEN EXHAUST FAN SCHEDULE															
MARK	SERVES	CFM	EXT. SP	RPM	MOTOR		DATA			DRIVE	MAX.	CONTROL	MANUFACTURER AND	WEIGHT	REMARKS	
IVIARA	SERVES		IN. W.G.	KEWI	ENCL	HP	ВНР	V	PH	FLA	DRIVE	SONES	CONTROL	MODEL NUMBER	(LBS.)	KEIVIAKKS
KEF-1	KITCHEN HOOD	1,650	1.25	1426	ODP	0.75	.515	208	3	2.6	DIRECT	12.8	KITCHEN HOOD CONTROLS	CAPTIVEAIRE DU85HFA	06	ALL

OR APPROVED EQUAL

2. PROVIDE FAN WITH PRE WIRED INTEGRAL DISCONNECT

3. PROVIDE INSULATED FACTORY ROOF CURB TO MATCH ROOF TYPE AND SLOPE

4. PROVIDE WITH VIBRATION ISOLATORS. 5. PROVIDE WITH VARIABLE FREQUENCY DRIVE

PROVIDE WITH LIFTING LUGS 7. PROVIDE WITH VENTED EXTENSION ROOF CURB (MINIMUM 8 INCHES FROM FINISHED ROOF)

8. PROVIDE WITH HINGED BASE

9. PROVIDE WITH GREASE TROUGH

10. PROVIDE WITH PERMANENT 1 INCH THICK WASHABLE ALUMINUM FILTER 11. FAN TO BE MONITORED BY FMCS

12. INTERLOCK WITH KITCHEN HOOD CONTROLS 13. NFPA 96 AND UL 762 RATED

> **CAMPOS ENGINEERING** 1331 River Bend Drive Dallas, Texas 75247 (214) 696-6291

campos@camposengineering.com Registration No: F-001731

Project Number: D24-3447.00



Dallas + Houston + Austin

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DATE ISSUE A 11 NOV 2024 100% Construction Documents ___1 ___20 DEC 2024_ADDENDUM #1 ___ __ __ __

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______ --------------------PROJECT NAME

Org 194 K.B. Polk Center for

Academically Talented & Gifted

PROJECT ADDRESS 6911 Victoria Ave, Dallas, TX

KIRKSEY PROJECT NO. 2023351

SHEET TITLE MECHANICAL SCHEDULES

SHEET NUMBER M10.01

KEY PLAN


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PLUMBING UNDERFLOOR -LEVEL 1 OVERALL PLAN



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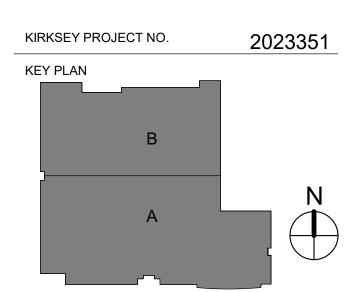
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--------------------PROJECT NAME

Org 194 K.B. Polk Center for Academically Talented & Gifted

PROJECT ADDRESS 6911 Victoria Ave, Dallas, TX 75209

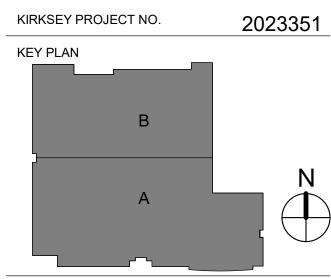

SHEET TITLE PLUMBING - LEVEL 2 OVERALL PLAN

CAMPOS ENGINEERING

1331 River Bend Drive
Dallas, Texas 75247
(214) 696-6291
campos@camposengineering.com
Registration No: F-001731
Project Number: D24-3447.00

SHEET NUMBER P4.03

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LIGHTING SHEET NOTES REFER TO SYMBOL LEGEND AND GENERAL NOTES FOR ADDITIONAL INFORMATION.
REFER TO SPECIFICATIONS FOR ADDITIONAL INFORMATION.
ALL NEW INSTALLATION AND PRODUCTS MUST MEET AND COMPLY WITH ADOPTED ELECTRICAL,
NTERNATIONAL ENERGY CONSERVATION CODES AND LATEST DISD TECHNICAL DESIGN GUIDELINES.
PROVIDE ON/OFF TOGGLE SWITCH IN MECHANICAL AND ELECTRICAL ROOMS.

KEYNOTES

PROVIDE NEW LIGHTING FIXTURES AND CONTROLS IN THIS ROOM. REFER TO E6.02 THROUGH E6.07 SHEETS FOR LIGHTING CONTROLS.

ALTERNATE #3: REPLACE EXISTING LIGHT FIXTURES IN THIS ROOM WITH NEW LED FIXTURES AND LIGHTING CONTROL SENSORS.

EXISTING LIGHTS AND CONTROLS TO REMAIN IN THIS ROOM.

REPLACE EXISTING CANOPY LIGHTS WITH NEW LED. CONNECT TO EXISTING CANOPY LIGHTING CIRCTUIS.

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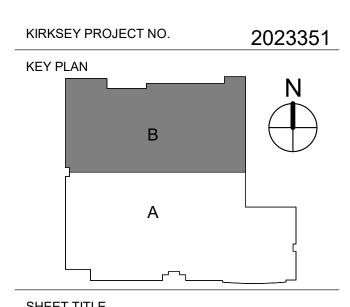
A 11 NOV 2024 100% Construction Documents

1 20 DEC 2024 Addendum #1 ______ ------------------------------

---------------PROJECT NAME Org 194 K.B. Polk Center for Academically Talented & Gifted

PROJECT ADDRESS

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SHEET TITLE LEVEL 1 LIGHTING PLAN B

CAMPOS ENGINEERING

1331 River Bend Drive
Dallas, Texas 75247
(214) 696-6291 campos@camposengineering.com Registration No: F-001731 Project Number: D24-3447.00

LEVEL 1 LIGHTING PLAN B | B5

SHEET NUMBER E5.02

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1/8" = 1'-0"

(2)

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A

KEYNOTES

PROVIDE NEW LIGHTING FIXTURES AND CONTROLS IN THIS ROOM. REFER TO E6.02 THROUGH E6.07 SHEETS FOR LIGHTING CONTROLS.

ALTERNATE #3: REPLACE EXISTING LIGHT FIXTURES IN THIS ROOM WITH NEW LED FIXTURES AND LIGHTING CONTROL SENSORS.

EXISTING LIGHTS AND CONTROLS TO REMAIN IN THIS ROOM.

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-----PROJECT NAME Org 194 K.B. Polk Center for Academically Talented & Gifted

PROJECT ADDRESS 6911 Victoria Ave, Dallas, TX 75209

2023351 KEY PLAN

LEVEL 2 LIGHTING PLAN A

CAMPOS ENGINEERING

1331 River Bend Drive
Dallas, Texas 75247
(214) 696-6291 campos@camposengineering.con Registration No: F-001731

Project Number: D24-3447.00

LEVEL 2 LIGHTING PLAN A B5

SHEET NUMBER E5.03 © 2023 Kirksey

1/8" = 1'-0"

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c

c

LIGHTING SHEET NOTES REFER TO SYMBOL LEGEND AND GENERAL NOTES FOR ADDITIONAL INFORMATION.

REFER TO SPECIFICATIONS FOR ADDITIONAL INFORMATION.

ALL NEW INSTALLATION AND PRODUCTS MUST MEET AND COMPLY WITH ADOPTED ELECTRICAL, INTERNATIONAL ENERGY CONSERVATION CODES AND LATEST DISD TECHNICAL DESIGN GUIDELINES.

PROVIDE ON/OFF TOGGLE SWITCH IN MECHANICAL AND ELECTRICAL ROOMS.

KEYNOTES

PROVIDE NEW LIGHTING FIXTURES AND CONTROLS IN THIS ROOM. REFER TO E6.02 THROUGH E6.07 SHEETS FOR LIGHTING CONTROLS.

ALTERNATE #3: REPLACE EXISTING LIGHT FIXTURES IN THIS ROOM WITH NEW LED FIXTURES AND LIGHTING CONTROL SENSORS.

EXISTING LIGHTS AND CONTROLS TO REMAIN IN THIS ROOM.

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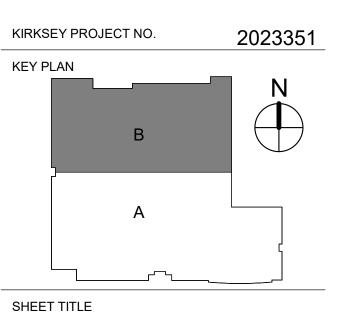
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PROJECT NAME

Org 194 K.B. Polk Center for Academically Talented & Gifted

PROJECT ADDRESS

6911 Victoria Ave, Dallas, TX 75209



LEVEL 2 LIGHTING PLAN B

CAMPOS ENGINEERING

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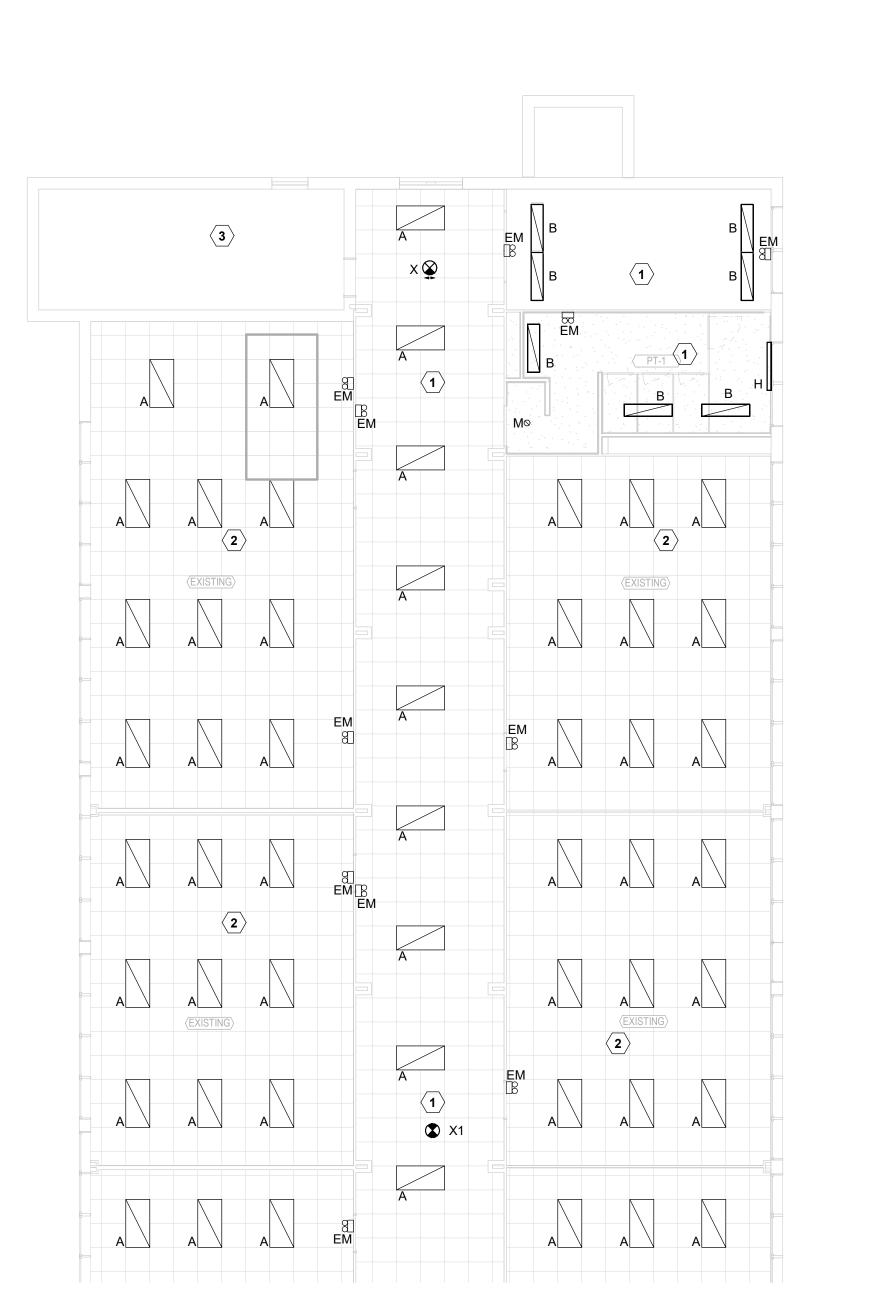
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LEVEL 2 LIGHTING PLAN B B5

SHEET NUMBER E5.04

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1/8" = 1'-0"



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KEYNOTES PROVIDE NEW LIGHTING CONTROL SYSTEM TO REPLACE EXISTING CONTROL IN THIS ROOM.

ALTERNATE #3: PROVIDE NEW LIGHTING CONTROL SYSTEM TO REPLACE EXISTING CONTROLS IN THIS ROOM.

EXISTING LIGHTS AND CONTROLS TO REMAIN IN THIS ROOM.

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PROJECT ADDRESS

6911 Victoria Ave, Dallas, TX

2023351 KIRKSEY PROJECT NO.

SHEET TITLE LEVEL 1 LIGHTING CONTROLS PLAN B

SHEET NUMBER

E6.03 © 2023 Kirksey

PRODUCT LEGEND Level 1 - Floor Plan Area B WIRE LEGEND Level 1 - Floor Plan Area B NWSXA PDT LV DX XX Aesthetic Wall Switch Occupancy Sensor, Pre-terminated CAT5e cable for Passive Dual Technology, Low Voltage, Raise/Lower Dimming communication network NPP16 D EFP Power/Relay Pack, Occupancy Controlled Dimming, External Fault Protection DP2 NPP16 D EFP SA Power/Relay Pack, Occupancy Controlled Dimming, External Fault Protection, Vacancy (default) or Auto-On NPODA KEY WH Low Voltage Wallpod, Digital keyswitch nLight Device, Bluetooth low energy communication module NWV PDT 16 KIT Low Voltage Corner Mount Sensor, Passive Dual Technology, 16 , Kit NCM PDT 10 RJB To OS6 on Level 2 - Floor Plan Area B Low Voltage Ceiling Mount Sensor, Passive Dual Technology, Large Motion / Extended Range 360° Lens, Rear RJ-45 Ports o BRG 1-3 P1 on Level 1 - Floor Plan Area A NCM PDT 9 RJB Low Voltage Ceiling Mount Sensor, Passive Dual Technology, Small Motion / Standard Range 360° Lens, Rear RJ-45 Ports NPP16 EFP SA Power/Relay Pack, External Fault Protection, Vacancy (default) or Auto-On NPP20 PL BP Plug Load, Bus power S1 NPODMA XX nLight Wired Aesthetic Wallpod NPODMA 4S DX XX nLight Wired Aesthetic Wallpod, 4 scene control, Raise/Lower Dimming Without Wires

CAT5e nLight

| \ EXISIT \ \ To OS6 on Level 2 - Floor Plan Area B -EM A A A SPACE REFER TO LEVEL 1 FLOOK EXISIT (EA A A A A

1/8" = 1'-0"

LEVEL 1 LIGHTING CONTROLS PLAN B | B5

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NPODMA DX XX

WSXA 2P FAN XX

WSXA PDT SA XX

NPOD TOUCH XX

Run Time

nLight Wired Aesthetic Wallpod,

Raise/Lower Dimming Without Wires


Wall Switch Sensor, 2-Pole, Minimum Fan

Technology, Vacancy (default) or Auto-On

Low Voltage Wallpod, Touchscreen Wall

Wall Switch Sensor, Passive Dual

campos@camposengineering.com Registration No: F-001731 Project Number: D24-3447.00

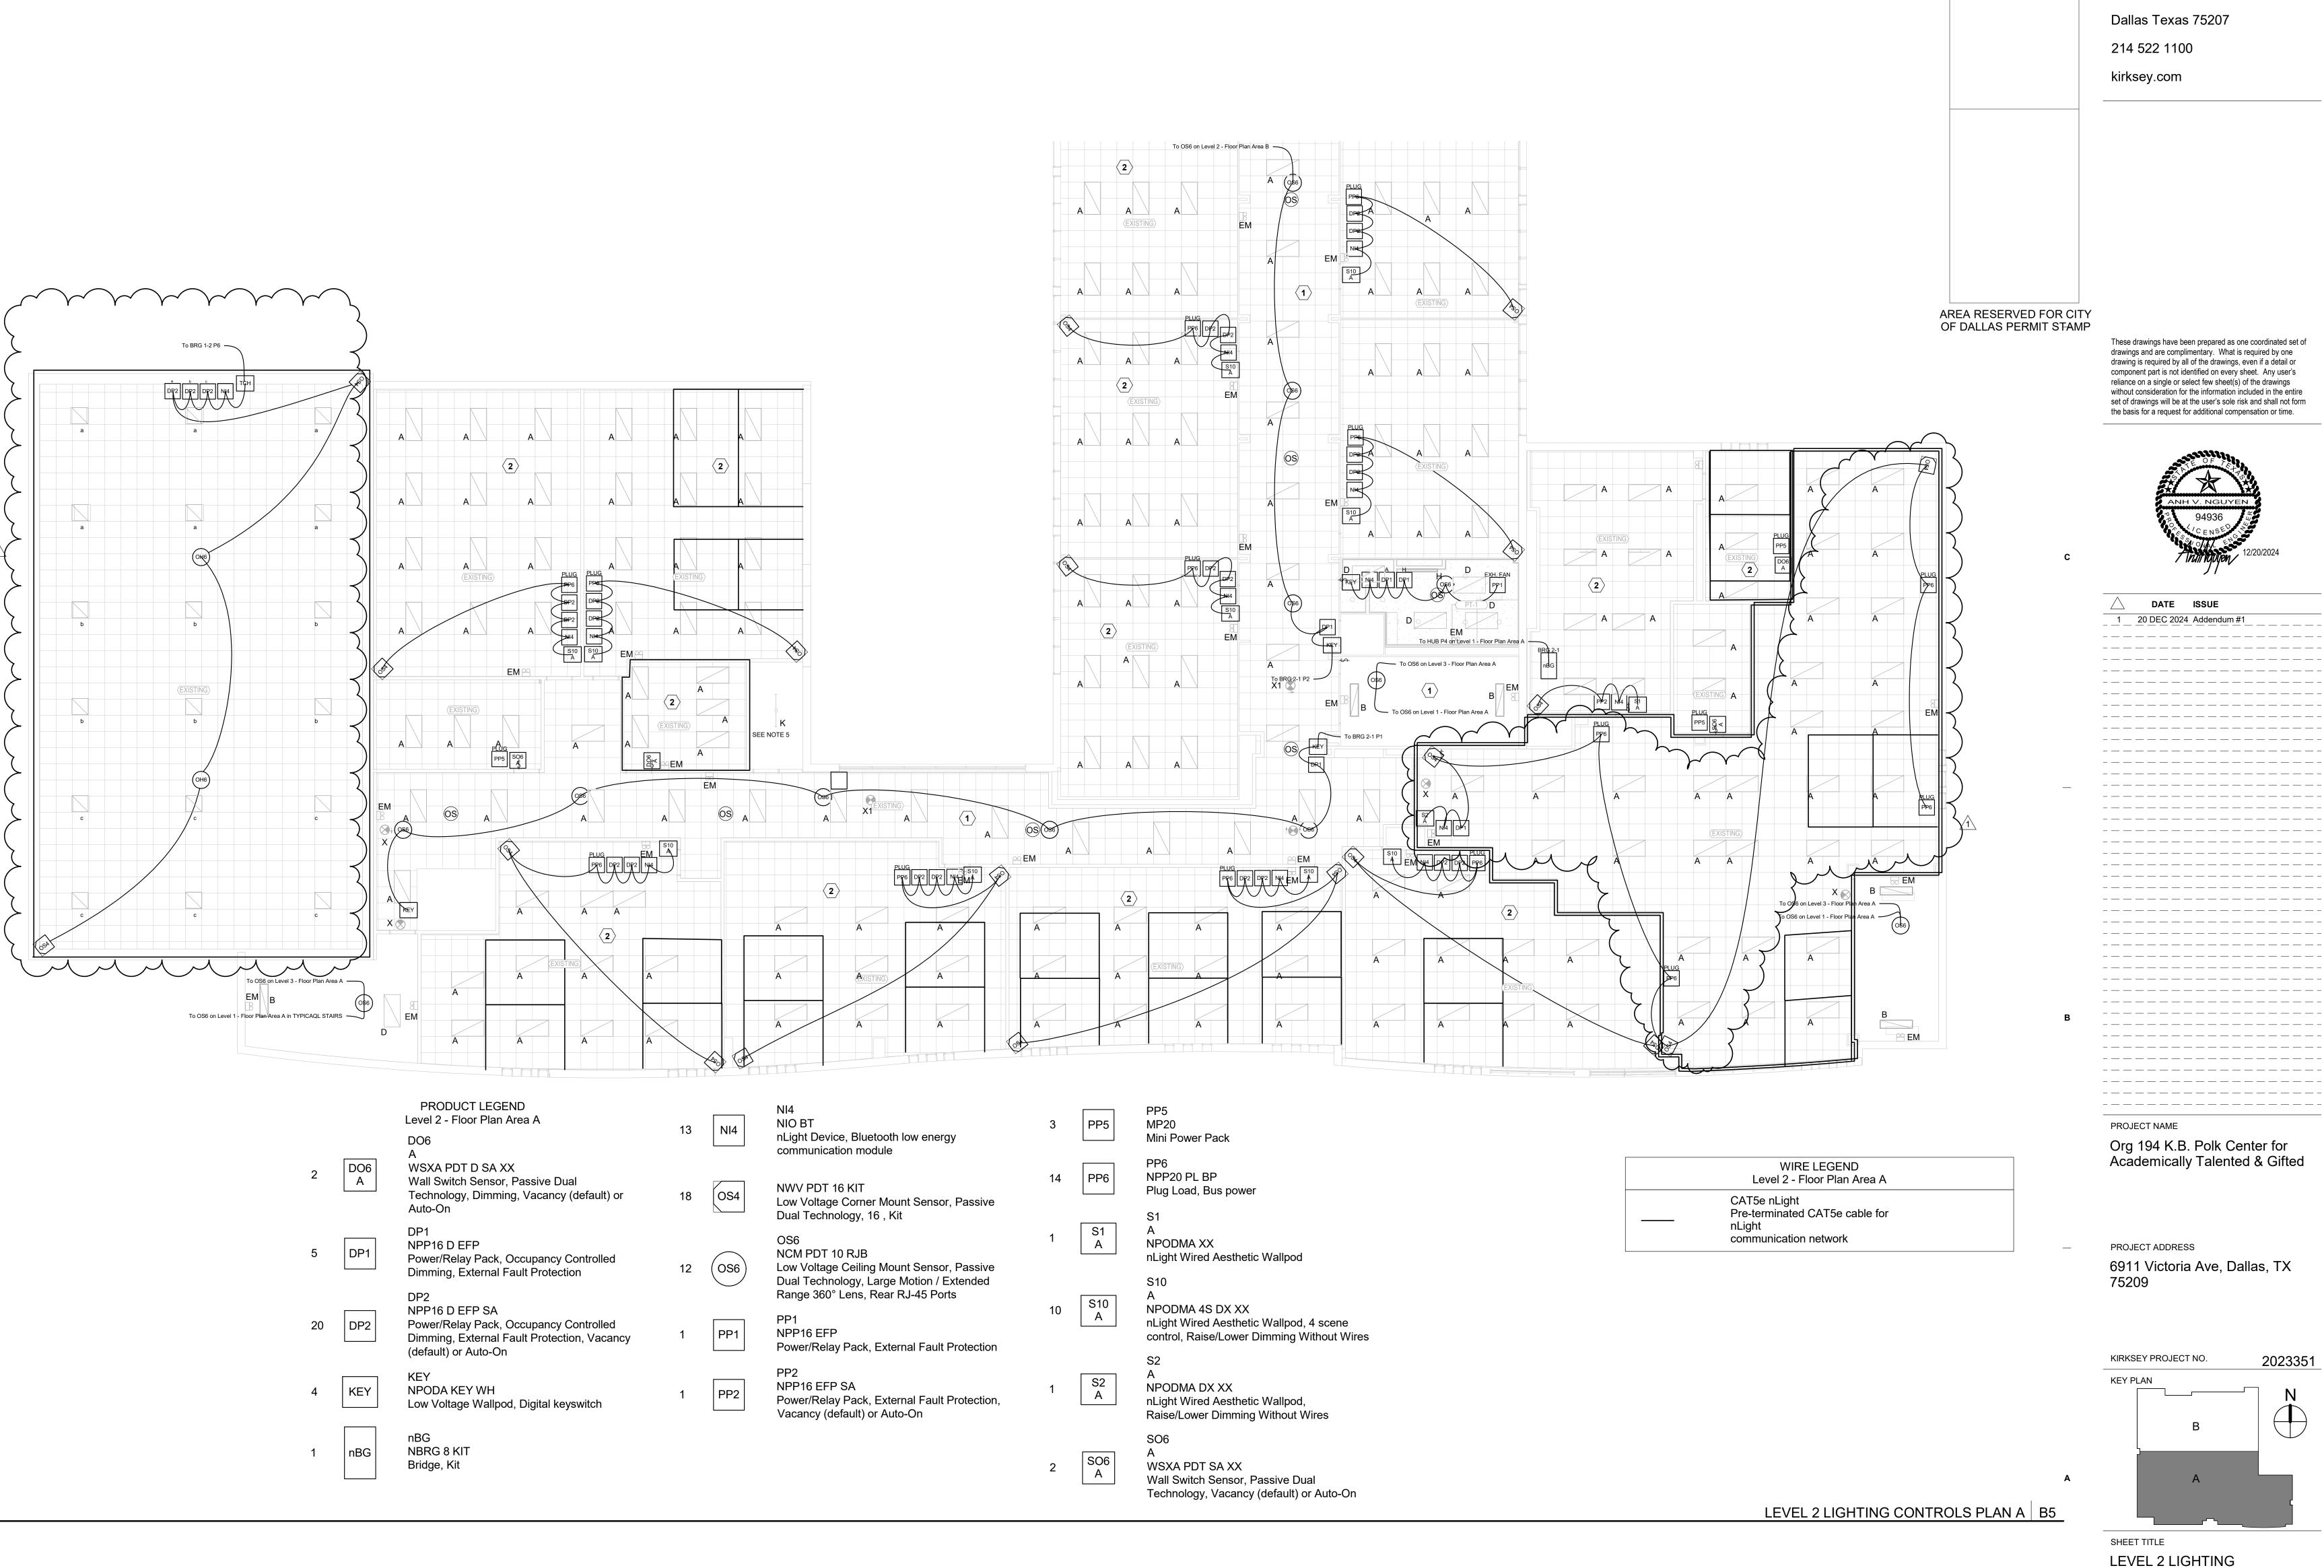

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214 522 1100

KEYNOTES

PROVIDE NEW LIGHTING CONTROL SYSTEM TO REPLACE EXISTING CONTROL IN THIS ROOM.

ALTERNATE #3: PROVIDE NEW LIGHTING CONTROL SYSTEM TO REPLACE EXISTING CONTROLS IN THIS

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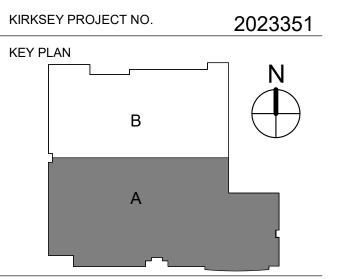
1 20 DEC 2024 Addendum #1

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PROJECT NAME

Org 194 K.B. Polk Center for Academically Talented & Gifted

PROJECT ADDRESS 6911 Victoria Ave, Dallas, TX



SHEET TITLE LEVEL 2 LIGHTING CONTROLS PLAN A

SHEET NUMBER

E6.04

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1/8" = 1'-0"

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(214) 696-6291 campos@camposengineering.com Registration No: F-001731

Project Number: D24-3447.00

KEYNOTES PROVIDE NEW LIGHTING CONTROL SYSTEM TO REPLACE EXISTING CONTROL IN THIS ROOM.

ALTERNATE #3: PROVIDE NEW LIGHTING CONTROL SYSTEM TO REPLACE EXISTING CONTROLS IN THIS

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PRODUCT LEGEND Level 2 - Floor Plan Area B

NPP16 D EFP Power/Relay Pack, Occupancy Controlled Dimming, External Fault Protection

NPP16 D EFP SA Power/Relay Pack, Occupancy Controlled Dimming, External Fault Protection, Vacancy (default) or Auto-On

KEY NPODA KEY WH Low Voltage Wallpod, Digital keyswitch

NI4 nLight Device, Bluetooth low energy communication module

NWV PDT 16 KIT OS4 Low Voltage Corner Mount Sensor, Passive Dual Technology, 16 , Kit

OS6 NCM PDT 10 RJB Low Voltage Ceiling Mount Sensor, Passive Dual Technology, Large Motion / Extended Range 360° Lens, Rear RJ-45 Ports

PP1 Power/Relay Pack, External Fault Protection

PP6 NPP20 PL BP PP6 Plug Load, Bus power

4 S10 A

NPODMA 4S DX XX nLight Wired Aesthetic Wallpod, 4 scene control, Raise/Lower Dimming Without Wires

WIRE LEGEND Level 2 - Floor Plan Area B CAT5 nLight CAT5e nLight Pre-terminated CAT5e cable for nLight communication network



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----------------PROJECT NAME Org 194 K.B. Polk Center for Academically Talented & Gifted

PROJECT ADDRESS

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2023351 KIRKSEY PROJECT NO.


SHEET TITLE LEVEL 2 LIGHTING CONTROLS PLAN B


SHEET NUMBER E6.05

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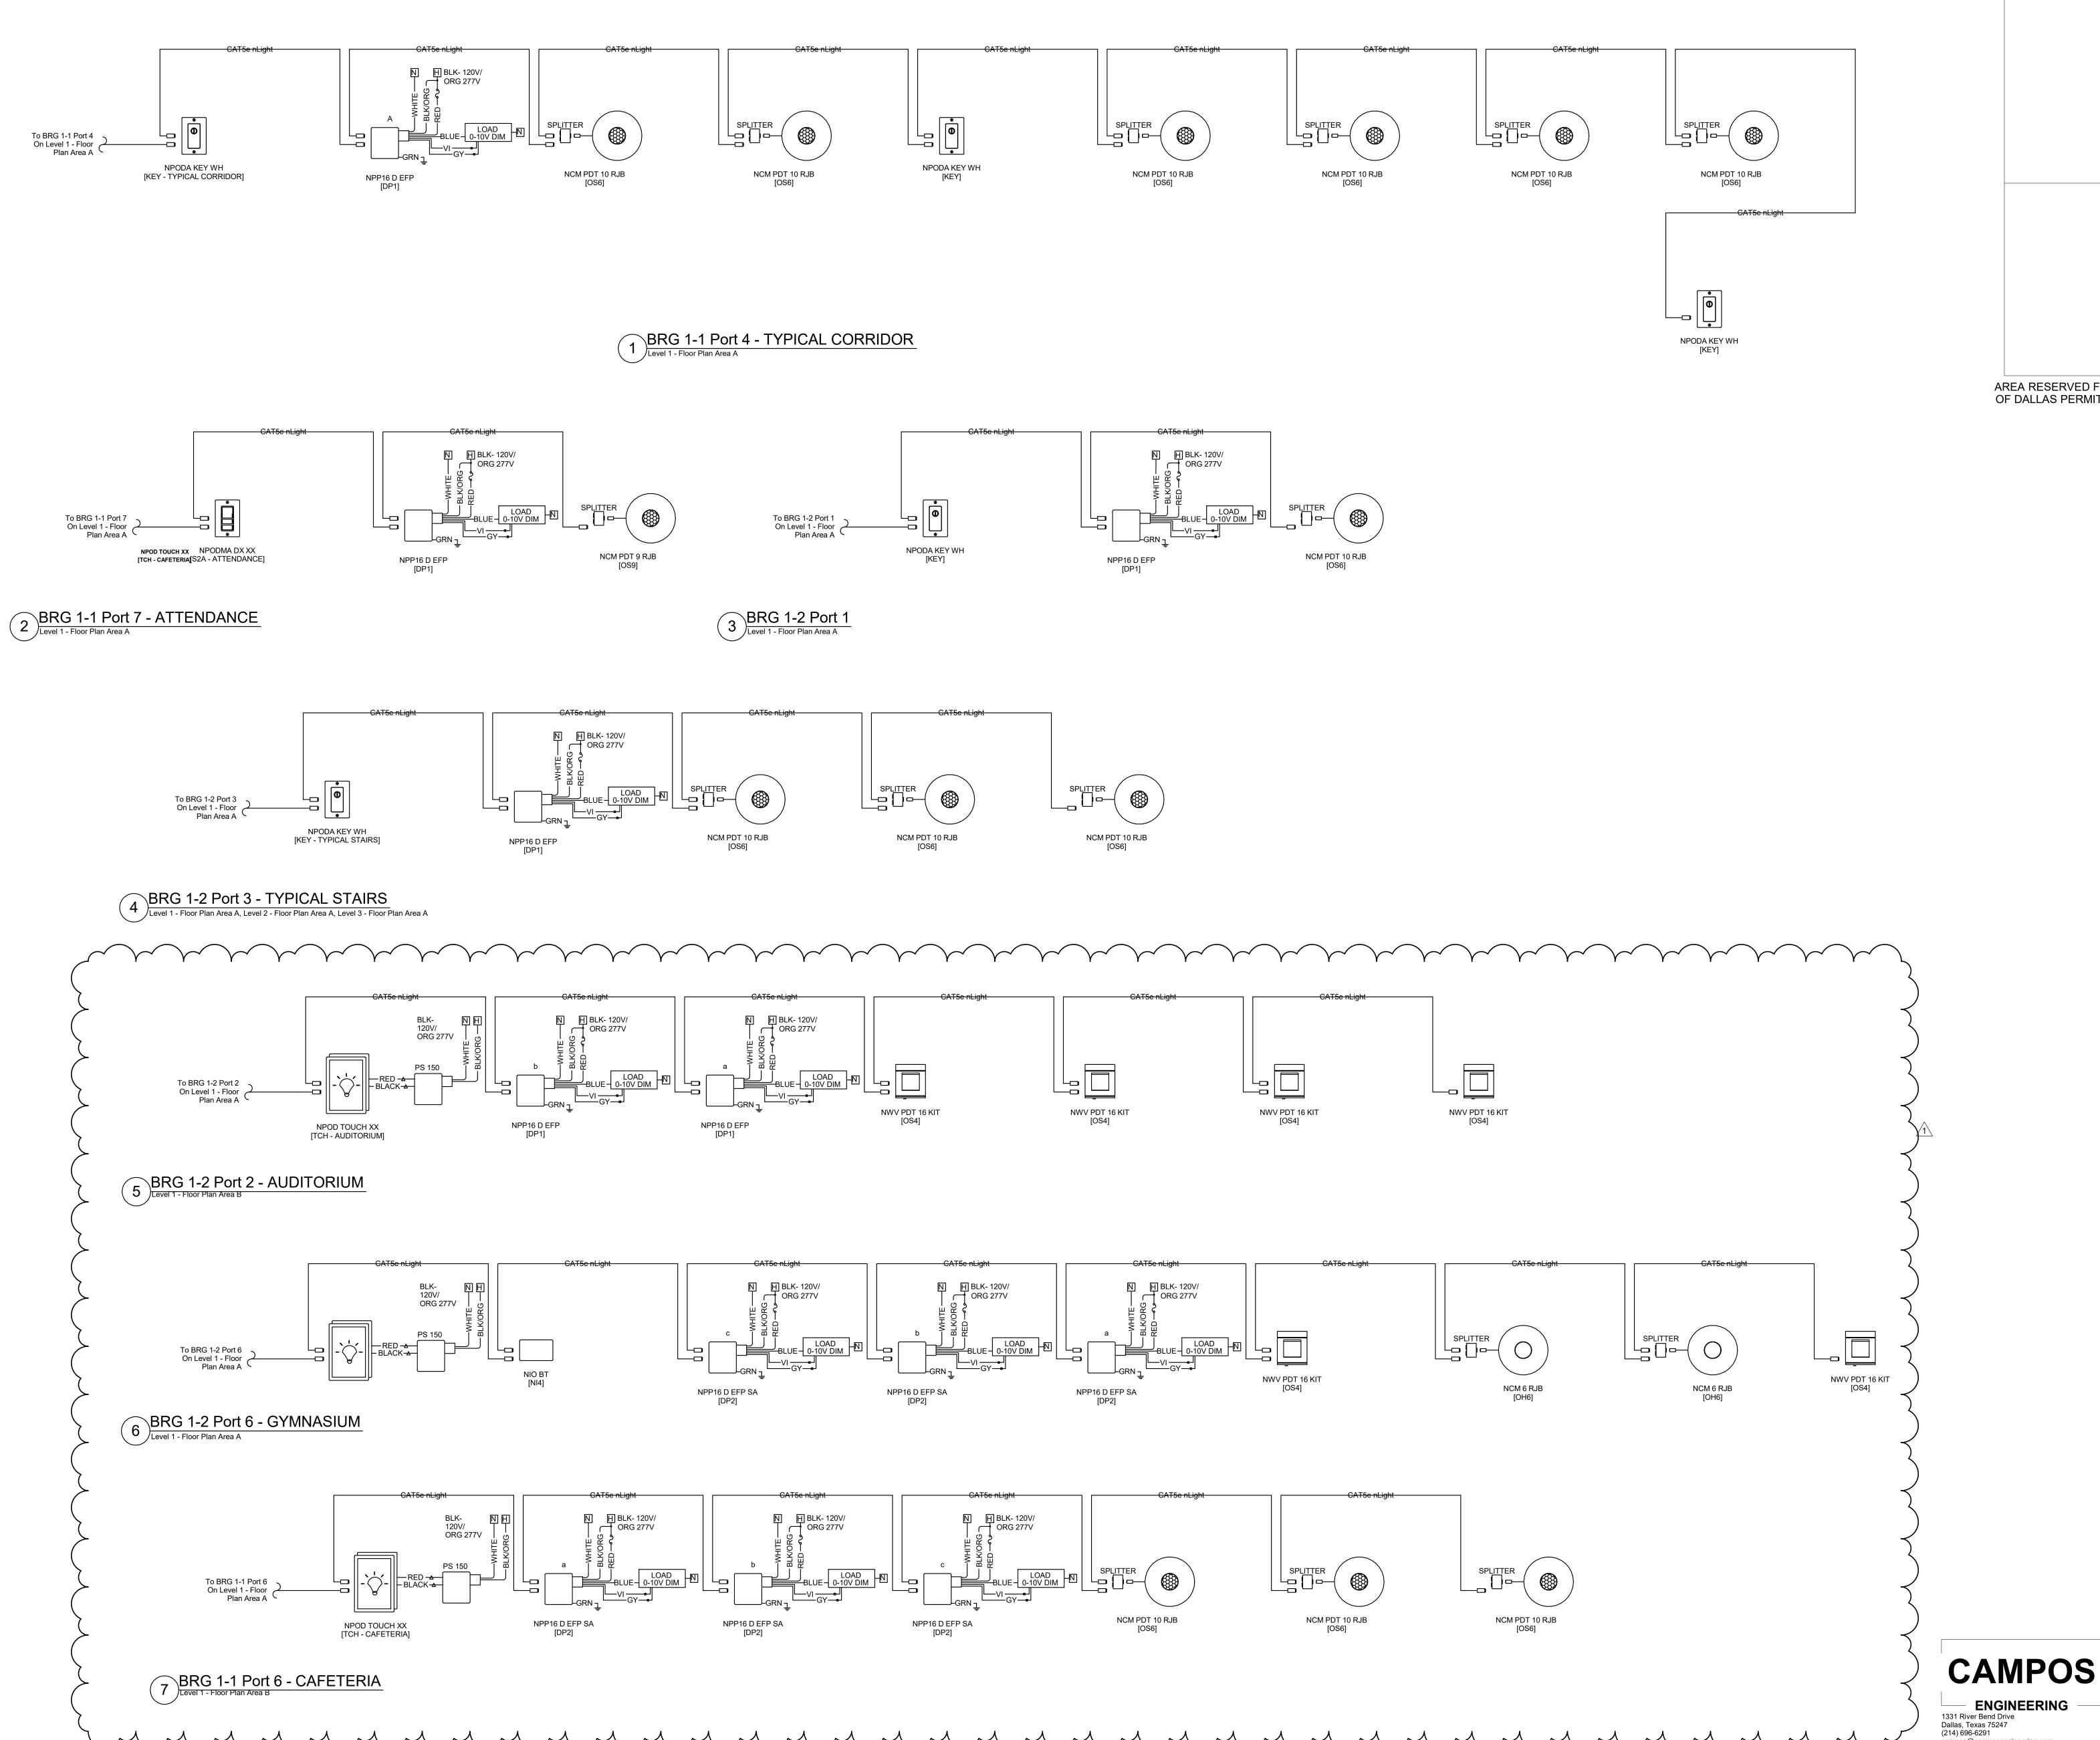
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LEVEL 2 LIGHTING CONTROLS PLAN B | B5



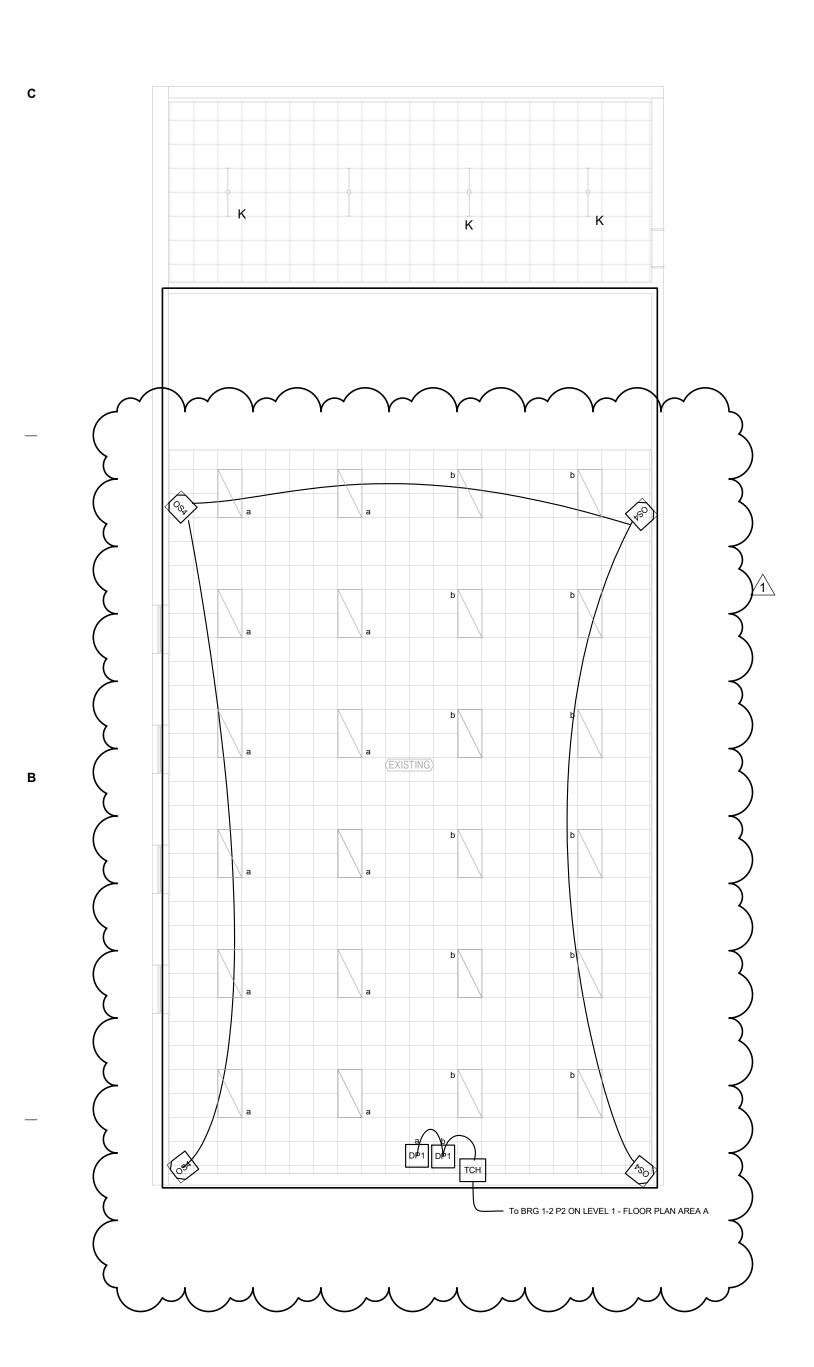

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PROJECT NAME Org 194 K.B. Polk Center for Academically Talented & Gifted

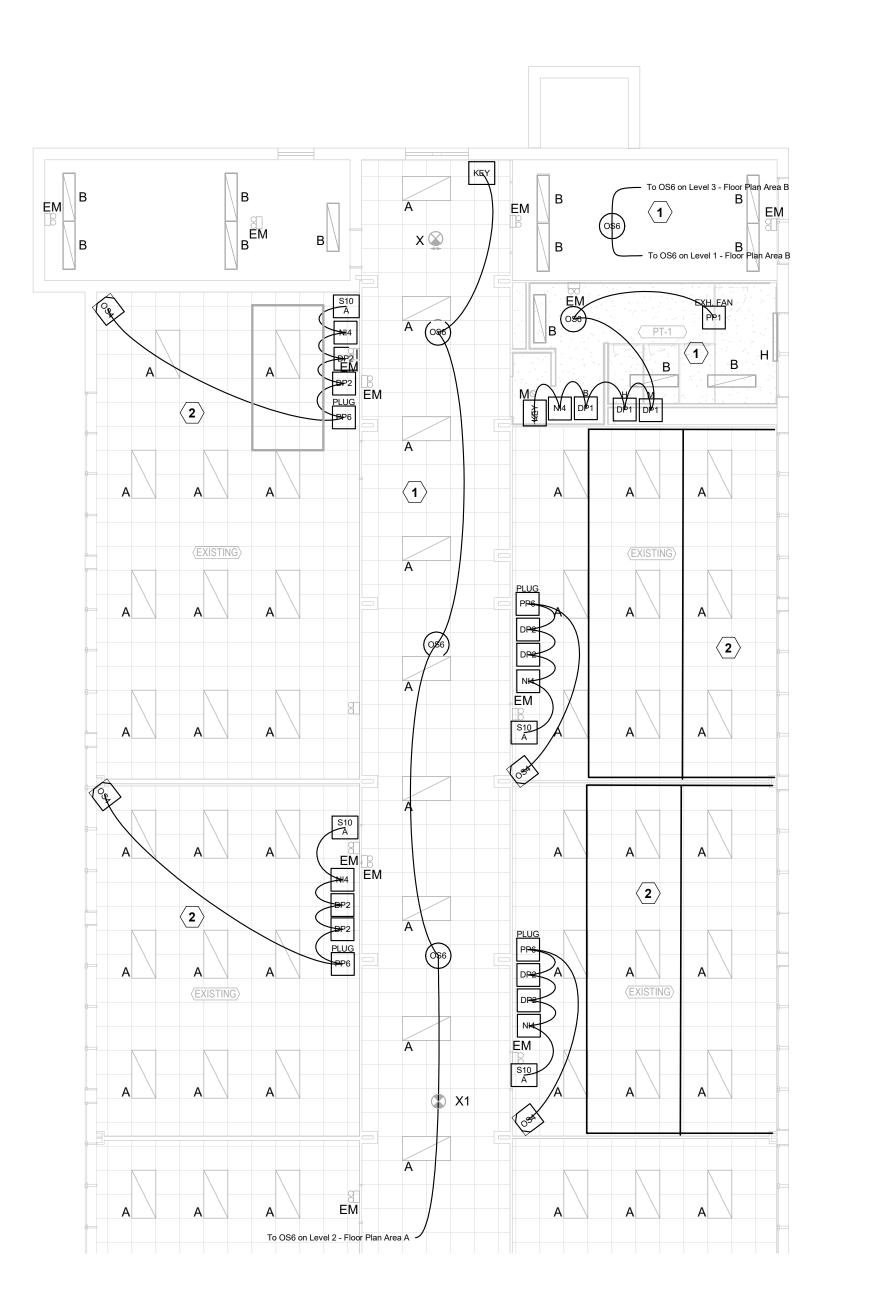PROJECT ADDRESS 6911 Victoria Ave, Dallas, TX

KEY PLAN

SHEET TITLE

DETAILS

LIGHTING CONTROLS

2023351 KIRKSEY PROJECT NO.

campos@camposengineering.com Registration No: F-001731 Project Number: D24-3447.00

SHEET NUMBER

E10.02