

ORG # 220 CSP # 207459

Mark Twain School for the Talented and Gifted

724 Green Cove Lane

DALLAS, TEXAS 75232

PROGRAM MANAGER



DISD SUPERINTENDENT OF SCHOOLS
DR. STEPHANIE ELIZALDE

BOARD OF TRUSTEES

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VOLUME 1

100% CONSTRUCTION DOCUMENTS NOT FOR CONSTRUCTION AUGUST 16, 2024



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	AT	HC.	HANDICAPPED	S	SOUTH
@ G	CENTERLINE	HGT. H.P.S.	HEIGHT HIGH PRESSURE SODIUM	S.A.G. SCHED.	SUPPLY AIR GRILLE SCHEDULE
#	NUMBER	HR. H.B. HDW.	HOUR HOSE BIBB HARDWARE	S.D. SECT.	SLOPE TO DRAIN SECTION
A AGGR.	AGGREGATE	HDWD. H.M.	HARDWOOD HOLLOW METAL	SHT. SHWR. SIM.	SHEET SHOWER SIMILAR
ASPH. ACT.	ASPHALT ACOUSTICAL CEILING TILE AIR CONDITIONING	H.C. HNDRL.	HOLLOW CORE HANDRAIL	SPEC. S.S.	SPECIFICATION STAINLESS STEEL
A/C ADJ.	ADJACENT OR	HORIZ. H.V.A.C.	HORIZONTAL HEATING, VENTILATING AND AIR CONDITIONING	STD. STL.	STANDARD STEEL
ABV.	ADJUSTABLE ABOVE	H.D.	HAND DRYER	STOR. SYM.	STORAGE SYMMETRICAL
A.F.F. AHU.	ABOVE FIN. FLOOR AIR HANDLING UNIT	I INFO.	INFORMATION	S.C. SAN.	SOLID CORE SANITARY
ALUM. ANOD.	ALUMINUM ANODIZED APPROXIMATE	INSUL. I.D.	INSULATION INSIDE DIAMETER	S.N.D.	SANITARY NAPKIN DISPENSER
APPROX. ARCH.	ARCHITECTURAL ADMINISTRATION	IN. INCL.	INCH INCLUDE	S.N.R.	SANITARY NAPKIN RECEPTACLE
ADMIN. ADD'L ALT.	ADDITIONAL ALTERNATE	INT. INV. J	INTERIOR INVERT	SQ. STRUCT. SUSP.	SQUARE STRUCTURE SUSPENDED
B BC BD.	BRICK COURSE BOARD	JAN. JT.	JANITOR JOINT	Т	
BLDG. BLK. BM.	BUILDING BLOCK BEAM	JST.	JOIST	T.D.D. TEL.	TOWEL DISPENSER & DISPOSAL TELEPHONE
BRG. BTWN.	BEARING BETWEEN	L LAM.	LAMINATE	THK. T.O.W.	THICK TOP OF WALL
BRKT. BSMT. BOT.	BRACKET BASEMENT BOTTOM	LAV. LT.	LAVATORY LIGHT	T.O.S. T.O.P.	TOP OF STEEL TOP OF PARAPET
C		LAB. LEED	LABORATORY LEADERSHIP IN ENERGY AND	T.P.D. TYP.	TOILET PAPER DISPENSER TYPICAL
CAB. C.A.D.	CABINET CHASE ACCESS DOOR	LKR. L.	ENVIRONMENTAL DESIGN LOCKER LENGTH	T.V. T.P.H.	TELEVISION TOILET PAPER HOLDER
C.G. C.J. CER.	CORNER GUARD CONTROL JOINT CERAMIC	LMC. LIN.	LINEAR METAL CEILING LINOLEUM	U	
C.I.P. CLG.	CAST IN PLACE CEILING	М		U.L. U.O.N.	UNDERWRITER'S LABORATORY UNLESS OTHERWISE NOTED
CLR. C.M.U.	CLEAR CONC. MASONRY UNIT	MANUF. MAX.	MANUFACTURER MAXIMUM	U/S U.S.G.B.C.	UNDERSIDE UNITED STATES GREEN BUILDING
COL. CONC. CORR.	COLUMN CONCRETE CORRIDOR	MECH. MTL.	MECHANICAL METAL	UR.	COUNCIL URINAL
COORD. CONT.	COORDINATE CONTINUOUS	MIN. MISC. MAS.	MINIMUM MISCELLANEOUS MASONRY	V	
CONN. CLG.	CONNECTION CEILING	M.H. M.E.P.	MANHOLE MECHANICAL, ELECTRICAL	VB V.C.T.	VAPOR BARRIER VINYL COMPOSITE TILE
CTR CLO. CONST.	CENTER CLOSET CONSTRUCTION	MIR.	AND PLUMBING MIRROR	V.C.T. VERT. V.I.F.	VINYE COMPOSITE TILE VERTICAL VERIFY IN FIELD
CONTR. C.P.	CONTRACTOR CONTROL PANEL - PROJECTION	M.O. M.T. MTD.	MASONRY OPENING MARBLE THRESHOLD MOUNTED	VEST.	VESTIBULE
CPT. CT. CTRL.	CARPET CERAMIC TILE CONTROL	MUL.	MULLION	V.O.C. V.WC. V.T.R.	VOLATILE ORGANIC COMPOUNDS VINYL WALLCOVERING VENT THROUGH ROOF
D		N N	NORTH		VENT THROUGH ROUF
DBL DET. DIA	DOUBLE DETAIL DIAMETER	N.I.C. NO.	NOT IN CONTRACT NUMBER	W	WEGT
DIA. DIM DN	DIMENSION DOWN	N.T.S. NOM.	NOT TO SCALE NOMINAL	W W.C.	WEST WATER CLOSET
DR D.O.	DOOR DOOR OPENING	0	ON CENTER	WD. W/	WOOD WITH
D.F. DEPT. DISP.	DRINKING FOUNTAIN DEPARTMENT DISPENSER	O.C. O.D.	ON CENTER OUTSIDE DIAMETER	W/O WT.	WITHOUT WEIGHT
DISP. D.P. D.S.	DISPENSER DAMP PROOFING DOWNSPOUT	OFF. O.F.I.	OFFICE OWNER FURNISHED AND INSTALLED	WDW. W.D.	WINDOW WOOD DOOR
E		OPNG. OPP.	INSTALLED OPENING OPPOSITE	WP. WR/GWP	WATERPROOF WATER RESISTANT GYPSUM
EA. E.J.	EACH EXPANSION JOINT	O.H. OVHD.	OPPOSITE HAND OVERHEAD	W.R.	WALL BOARD WATER RESISTANT
ELEV. ELEC.	ELEVATION, ELEVATOR ELECTRICAL	OZ.	OUNCE	WSCT. WT.	WAINSCOT WEIGHT
EQ. E.W.C.	EQUAL ELECTRIC WATER COOLER	P PL.	PLATE		
EXIST. EXP.	EXISTING EXPANSION EXTERIOR	PT. PLAM.	PRESSURE TREATED PLASTIC LAMINATE		
EXT. EXPO. EMER.	EXTERIOR EXPOSED EMERGENCY	PLYWD. PR. PRCST.	PLYWOOD PAIR PRECAST		
EQUIP. E.W.	EQUIPMENT EACH WAY	PREMANUF.	PREMANUFACTURED		
E.P. ENCL.	ELECTRICAL PANEL BOARD ENCLOSURE	PTN. PNT.	PARTITION PAINT		
EINI	EIMICH	PLBG. PKG./PKNG.	PLUMBING PARKING		
FIN. F.M. F.R.	FINISH FACTORY MUTUAL FIRE RETARDANT	PREP. PT.	PREPARE PORCELAIN TILES		
FL./ FLR. F.A.	FLOOR FIRE ALARM	R			
FDN. F.D.	FOUNDATION FLOOR DRAIN	RAD.	RADIUS		
F.E.C. F.O.C.	FIRE EXTINGUISHER CABINET FACE OF CONCRETE	R.A.F. R.B.	RAISED ACCESS FLOORING RUBBER BASE		
F.O.F. F.O.S. F.O.W.	FACE OF FINISH FACE OF STUD FACE OF WALL	REF. REQ.	REFERENCE REQUIRED		
F.O.W. F.R.P.	FACE OF WALL FIBERGLASS REINFORCED PLASTIC	RM. RCP	ROOM REFLECTED CEILING PLAN		
FLASH'G. FLUOR.	FLASHING FLUORESCENT	REINF. REBAR	REINFORCED REINFORCING BAR		
FTG.	FOOTING	RESIL. RGTR.	RESILIENT REGISITER		
GA.	GAUGE	REFG. R.O.	REFRIGERATOR ROUGH OPENING		
GALV. GL.	GALVANIZED GLASS	R.T.U.	ROOF TOP UNIT		
G.F.I. GYP. BD.	GROUND FAULT INTERRUPTER GYPSUM BOARD				
GRG. G.C.	GLASS REINFORCED GYPSUM GENERAL CONTRACTOR				
G.B.	GRAB BAR				
		CO	DE ANALYSIS		
	1. PROJ	ECT LOCATION:	DALLAS ISD CONSTRUCTION Mark Twain School for the Tale 724 Green Cove Lane Dallas, Texas 75232		
	2. ZONIN	NG:	School		
	3. APPLI	2021 INTERNATIO	DNAL BUILDING CODE with amendments DNAL MECHANICAL CODE with amendment DNAL PLUMBING CODE with amendments	s 2021 I	NATIONAL Electrical Code (NFPA 70) NTERNATIONAL FIRE CODE FEXAS ACCESSIBILITY STANDARDS
		ARY OCCUPANCY: GROUP E		20.2	
	5. SECO	ONDARY OCCUPAN	CY:		
		ASSEMBLY A-2	IP R		
	6. AUTO	ASSEMBLY A-2 BUSINESS GROU DMATIC FIRE SUPPR			

9. MAXIMUM TRAVEL DISTANCE:

200 feet NPFA

10. FIRE PROTECTION REQUIREMENTS:

BUILDING ELEMENT

STRUCTURAL FRAME

BEARING WALLS

EXTERIOR

EXTERIOR

FLOOR CONSTRUCTION

ROOF CONSTRUCTION

NON BEARING WALLS AND PARTITIONS

0-HOURS

0-HOURS

0-HOURS

0-HOURS

0-HOURS

0-HOURS

0-HOURS

SCOPE OF WORK

PROVIDE SECURITY UPDATES

PROVIDE SECURE FRONT VESTIBULE

REPLACE EXTERIOR WATERPROOFING / SEALANT JOINTS

REPLACE FIRE ALARM SYSTEM

REPLACE EXTERIOR LIGHTS WITH L.E.D. LIGHTING

PROVIDE EXTERIOR LIGHTING CONTROLS REPLACE VCT AND BASE AT DESIGNATED AREAS

REPLACE TEACHING SURFACES AT ALL CLASSROOMS

REPLACE CARPET / VCT AND BASE AT DESIGNATED AREAS

PROVIDE NEW MARQUEE SIGN

MECHANICAL / HVAC IMPROVEMENTS

REPLACE GREASE TRAP AND WASTE PIPING, NEW WATER HEATER AND HOSE BIBBS

PROVIDE / REPLACE IDF/MDF AIR CONDITIONING

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GENERAL

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G0.01	SHEET INDEX - SCOPE OF WORK - GENERAL NOTES
G0.02	ACCESSIBILITY / DETAILS
G0.03	PHASING PLAN

CIVIL

Sheet Number	Sheet N
C04.01	DEMO PLAN
C05.01	PAVING PLAN

STRUCTURAL

Sheet Number	r Sheet Name
S-101	GENERAL NOTES AND ABBREVIATIONS
S-201	FOUNDATION AND FRAMING PLANS
S-301	FOUNDATION DETAILS
S-302	NEW MARQUEE SIGN SECTIONS AND DETAILS
S-402	ROOF TOP UNITS PLAN
S-501	TYPICAL DETAILS

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ARCHITECTURAL			
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	AS100	SITE / ROOF PLAN	
	ASD100	SITE ENTRY PAVEMENT DEMO PLAN	
	AS101	SITE ENTRY PAVEMENT PLAN	
	AS102	MARQUEE SIGN AND DETAILS	
	AD100	COMPOSITE DEMO FLOOR PLAN	
	AD101	ENLARGED ENTRY DEMO FLOOR PLAN	
	AD102	DEMO FLOOR PLANS AREAS B,C,and D	
	AP100	COMPOSITE FLOOR PLAN	
	AP101	FLOOR PLAN AREA 'A'	
	AP102	FLOOR PLAN AREA 'B'	
	AP103	FLOOR PLAN AREA 'C'	
	AP104	FLOOR PLAN AREA 'D'	
	AP105	FLOOR PLAN AREA 'E'	
	AP106	MILLWORK DETAILS	
	AC001	COMPOSITE RFLC DEMO PLAN	
	AC002	RFLC DEMO PLAN AREA 'A', 'B', 'D'	
	AC100	COMPOSITE RFLC PLAN	
	AC101	RFLC PLAN AREA 'A', 'B', 'D'	
	AE100	EXTERIOR ELEVATIONS	
	AE101	EXTERIOR ELEVATIONS	
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M002	DETAILS AND SCHEDULES	P10 ²
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		P202
M204	ROOF PLAN MECHANICAL	D

FLOOR PLAN MECHANICAL PIPING AREA A & B

FLOOR PLAN MECHANICAL PIPING AREA C

FLOOR PLAN MECHANICAL PIPING AREA D

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E205	ROOF PLAN POWER
E205	ROOF PLAN POWER
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FLOOR PLAN AREA E POWER

DITIMBING

	ŀ	LUME	BING			
Sheet Nu	ımber	Sheet N	ame			
P001	DETAILS	& SCHE	DULES PL	UMBING		
P101	UNDERF	LOOR PL	AN PLUM	IBING DE	MO AREA	\S A8
P102	UNDERF	LOOR PL	AN PLUM	IBING DE	MO AREA	√ C
P103	UNDERF	LOOR PL	AN PLUM	IBING DE	MO AREA	√ D
P104	UNDERF	LOOR PL	AN PLUM	IBING DE	MO AREA	١E
P111	FLOOR F	PLAN PLU	JMBING D	EMO ARE	EAS A&B	
P112	FLOOR F	PLAN PLU	JMBING D	EMO ARE	EA C	
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P201	UNDERF	LOOR PL	AN PLUM	IBING AR	EAS A&B	

UNDERFLOOR PLAN PLUMBING AREA C

UNDERFLOOR PLAN PLUMBING AREA D

UNDERFLOOR PLAN PLUMBING AREA E

FLOOR PLAN PLUMBING AREAS A&B

FLOOR PLAN PLUMBING AREA C

FLOOR PLAN PLUMBING AREA D

FLOOR PLAN PLUMBING AREA E

TECHNOLOGY

T305

Sheet Name

FLOOR PLAN TECHNOLOGY AREAS A&B

FLOOR PLAN TECHNOLOGY AREA C FLOOR PLAN TECHNOLOGY AREA D FLOOR PLAN TECHNOLOGY AREA E FLOOR PLAN FIRE ALARM AREAS A&B

FLOOR PLAN FIRE ALARM AREA C FLOOR PLAN FIRE ALARM AREA D

FLOOR PLAN FIRE ALARM AREA E

ROOF PLAN FIRE ALARM

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ARCHITECT:

OWNER'S REPRESENTATIVE:

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> pu **e**d 5232

REVISIONS: NO. DATE ISSUE:

ALTERATIONS, CUTTING AND REMOVAL: LAY OUT ALL WORK AS SHOWN ON DRAWINGS. NOTIFY ARCHITECT OF ALL DISCREPANCIES

BY DEMOLITION OPERATIONS AT NO ADDITIONAL COST TO OWNER

NOTIFY ARCHITECT IMMEDIATELY.

TO DAMAGE ADJACENT WORK

STORED PER OWNER'S DIRECTION

PRIOR TO THE INSTALLATION OF NEW FINISHES.

MATERIALS BASED ON ASBESTOS SURVEY REPORT.

TO BE LEFT IN PLACE

IMMEDIATELY AND DO NOT PROCEED WITH CONSTRUCTION UNTIL DISCREPANCIES ARE

2. PROTECT EXISTING CONSTRUCTION, HVAC, ELECTRICAL, PLUMBING, AND FINISHING THAT

3. BEFORE DEMOLITION OR REMOVAL OF ANY WALL OR STRUCTURAL COMPONENT, VERIFY IF

ANY WALL OR STRUCTURAL COMPONENT IS A LOAD-BEARING COMPONENT, AND IF SO,

4. REMOVE EXISTING WALLS AND CUT AWAY PORTIONS OF EXISTING WALLS AS INDICATED.

CLEAN, PREP. AND COORDINATE AS NECESSARY PRIOR TO RECEIVE NEW WORK.

8. CAREFULLY MONITOR ASSIGNMENTS TO, AND RESPONSIBILITY OF TRADES, SO AS TO

10. COORDINATE ACTIVITIES OF ALL TRADES TO AVOID OVERCUTTING AND OVERREMOVAL

12. LIGHT FIXTURES, DOORS, FRAMES AND FINISH HARDWARE TO BE SALVAGED SHALL BE

13. CLEAN AND PREPARE ALL AREAS AFTER ALTERATION, CUTTING AND REMOVAL COMPLETE

11. CONTRACTOR SHALL REMOVE ALL DEMOLISHED MATERIAL NOT REQUESTED TO BE

14. CONTRACTOR SHALL COORDINATE WITH DISD TO CONFIRM AREAS OF HAZARDOUS

RETAINED BY OWNER PER CONSTRUCTION WASTE MANAGEMENT PLAN.

MINIMIZE DAMAGE TO EXISTING SURFACES AND REPAIR THEREOF.

ASSIGN WORK TO TRADES SKILLED IN PROCEDURES INVOLVED.

5. EXECUTE WORK IN ORDERLY AND CAREFUL MANNER WITH DUE REGARD FOR EXISTING

ARE NOT AFFECTED BY DEMOLITION. REPAIR OR REPLACE WORK INADVERTENTLY DAMAGED

CONSTRUCTION. TAKE CARE NOT TO WEAKEN OR OTHERWISE DAMAGE INTEGRITY OF WORK

6. PERFORM WORK SO AS NOT TO CUT OR REMOVE MORE THAN IS NECESSARY AND SO AS NOT

7. CONDUCT WORK IN MANNER SO AS TO MINIMIZE NOISE ACCUMULATION AND SPREAD OF DIRT

- . ALL WORK SHALL CONFORM AND COMPLY WITH ALL APPLICABLE LOCAL, MUNICIPAL, STATE NATIONAL, BUILDING CODES, FEDERAL CODES AND ORDINANCES AS WELL AS REGULATIONS FOR ADA ACCESSIBILITY ORDINANCES AND DOCUMENTS SHALL BE BROUGHT TO THE
- ATTENTION OF ARCHITECT BEFORE COMMENCING WORK. 2. THE CONTRACTOR SHALL VISIT THE SITE AND BE COMPLETELY FAMILIAR WITH SCOPE OF WORK AND EXISTING CONDITIONS. THE CONTRACTOR SHALL FIELD VERIFY ALL EXISTING CONDITIONS, DIMENSIONS, UTILITIES, EASEMENTS AND REPORT ANY DISCREPANCIES TO THE ARCHITECT BEFORE COMMENCING THE WORK. FAILURE TO NOTIFY ARCHITECT OF ANY DISCREPANCIES AND/OR CONFLICTS PRIOR TO BEGINNING OR DURING CONSTRUCTION SHALL CONSTITUTE ACCEPTANCE OF RESPONSIBILITY BY THE CONTRACTOR AND SHALL

GENERAL NOTES TO CONTRACTOR:

- BEAR ATTRIBUTABLE COSTS FOR CORRECTION. 3. THE CONSTRUCTION AREA IS LIMITED TO THE AREA OWNED AND CONTROLLED BY DALLAS INDEPENDENT SCHOOL DISTRICT. THE CONTRACTOR SHALL PROVIDE ADDITIONAL PERMANENT/TEMPORARY SUPPORTS/BARRICADES, WARNING SIGNS AND FLASHING LIGHTS
- AS MAY BE NECESSARY DURING CONSTRUCTION 5. THE CONTRACTOR SHALL BE RESPONSIBLE FOR PROPER DISPOSAL OF DEBRIS AND
- CONSTRUCTION WORK MATERIALS PER CONSTRUCTION WASTE MANAGEMENT PLAN. 6. FURNISH ALL MATERIALS, LABOR AND EQUIPMENT, AS WELL AS ALL SCHEDULING SUPERVISION AND COORDINATION TO PROVIDE A FINISHED JOB, COMPLETE AND READY FOR
- USE. ALL MATERIALS TO BE INCORPORATED INTO WORK SHALL BE NEW. 7. MUTUALLY COORDINATE WITH WORK OF OTHER CONTRACTORS AT THE SITE, WHICH MAY INCLUDE (BUT ARE NOT LIMITED TO) DOMESTIC WATER, STORM SEWER, IRRIGATION,
- ELECTRICAL, GAS, TELEPHONE, TV CABLE AND LANDSCAPE. OBTAIN APPROVALS AND PAY FOR PERMITS OR OTHER FEES REQUIRED BY GOVERNING AGENCIES FOR WORK REQUIRED AT THE JOB SITE, ON ADJACENT PROPERTIES OR ON PUBLIC
- WALKS AND THOROUGHFARES. 9. PROVIDE ARCHITECT AND OWNER A COPY OF THE PROPOSED CONSTRUCTION SCHEDULE BEFORE BEGINNING WORK.
- 10. PROVIDE OWNER SEVEN DAYS ADVANCE NOTICE OF MOBILIZATION.
- 11. COORDINATE ALL ACTIVITIES WITH THE OWNER BEFORE PREPARING CONSTRUCTION
- 12. PROVIDE TEMPORARY WALKS OR OTHERWISE MAINTAIN FULL ACCESS TO THE BUILDING AND
- ALL SERVICE FACILITIES AND FUNCTIONS THROUGHOUT THE PROCESS. 13. PROTECT EXISTING CONSTRUCTION, HVAC, ELECTRICAL, PLUMBING, AND FINISHING THAT ARE NOT AFFECTED BY DEMOLITION. REPAIR OR REPLACE WORK INADVERTENTLY DAMAGED
- BY DEMOLITION OPERATIONS AT NO ADDITIONAL COST TO OWNER 14. LAY OUT ALL WORK AS SHOWN ON DRAWINGS. NOTIFY ARCHITECT OF ALL DISCREPANCIES IMMEDIATELY AND DO NOT PROCEED WITH CONSTRUCTION UNTIL DISCREPANCIES ARE
- RESOLVED. 15. DO NOT INTERFERE WITH OTHER DALLAS INDEPENDENT SCHOOL DISTRICT CONTRACT WORK AND OPERATIONS ON THIS SITE.
- 16. THE GENERAL CONTRACTOR IS RESPONSIBLE TO KEEP AND MAINTAIN THE FIRE ALARM OPERATIONAL DURING CONSTRUCTION. EXISTING FIRE ALARM TO BE DEMOLISHED IMMEDIATELY AFTER APPROVAL. PATCH AND PAINT ALL DEMO LOCATIONS.
- 17. THE GENERAL CONTRACTOR IS RESPONSIBLE TO USE ANY ALL ACCEPTABLE METHODS TO ENSURE UNDERGROUND ARE LOCATED AND UNDISTURBED.

DISPOSAL OF DEBRIS:


- 1. REMOVAL MATERIAL, EXCEPT WHERE SPECIFICALLY NOTED OTHERWISE, BECOMES
- PROPERTY OF CONTRACTOR AND SHALL BE LEGALLY DISPOSED OF OFF SITE. 2. PROTECT, RELOCATE AND STORE ITEMS DESIGNED TO REMAIN PROPERTY OF OWNER IN
- BUILDING WHERE DIRECTED BY OWNER. 3. WHERE NEW MATERIALS MUST BE MATCHED TO EXISTING, OR MOLDS MUST BE MADE FROM EXISTING, DO NOT REMOVE OR DISPOSE OF SUCH EXISTING MATERIAL UNTIL MATCHED NEW WORK HAS BEEN APPROVED BY ARCHITECT.

PATCHING, EXTENDING AND MATCHING:


- 1. WHERE EXISTING SURFACES ARE CUT, STAINED, MARRED OR OTHERWISE DAMAGED, PATCH AND FINISH TO EXTENT REQUIRED SO AS TO MAKE PATCHING AS INCONSPICUOUS AS
- 2. FOR CONTINUOUS SURFACES: PATCH AND REFINISH TO NEAREST OFFSET INTERSECTION OR OTHER EXISTING POINT AT WHICH WORK CAN BE NEATLY TERMINATED.
- 3. FOR ASSEMBLIES: PATCH AND REFINISH ENTIRELY. 4. WHERE NEW WORK ABUTS OR FINISHES FLUSH WITH EXISTING WORK, MAKE TRANSITION AS SMOOTH AS POSSIBLE.
- 5. WHERE FINISHED SURFACE IS CUT IN SUCH A MANNER THAT A SMOOTH TRANSITION WITH NEW WORK IS NOT POSSIBLE, TERMINATE EXISTING SURFACE IN NEAT FASHION ALONG STRAIGHT LINE AT NATURAL LINE OF DIVISION AND PROVIDE TRIM APPROPRIATE TO FINISHED SURFACE.
- ASSIGN PATCHING OF FINISH MATERIALS TO CRAFTSMEN SKILLED IN PROCEDURES INVOLVED.
- PROVIDE ADEQUATE SUPPORT OR SUBSTRATE FOR PATCHING OF FINISHES.
- 8. WHERE REMOVAL OF EXISTING CONSTRUCTION EXPOSES ITEMS WHICH WERE PREVIOUSLY CONCEALED. SUCH AS WIRING, PIPES, ETC., REWORK SUCH ITEMS TO BE CONCEALED IN FINISHED CONSTRUCTION.
- 9. DOOR OPENINGS AT CMU WALLS SHOWN TO BE FILLED WILL BE TOOTHED IN.
- 10. DO NOT CUT OR REMOVE EXISTING STRUCTURAL MEMBERS, OTHER THAN TO THE EXTENT CONTAINED IN THE CONTRACT DOCUMENTS, WITHOUT WRITTEN PERMISSION OF ARCHITECT
- 11. WHERE DEVICES ARE REMOVED: INFILL HOLES AND VOIDS WITH MATCHING MATERIAL FINISHES.

KEY PLAN JMA Project Number: SHEET INDEX - SCOPE OF WORK - GENERAL NOTES **Sheet Number**

G0.01

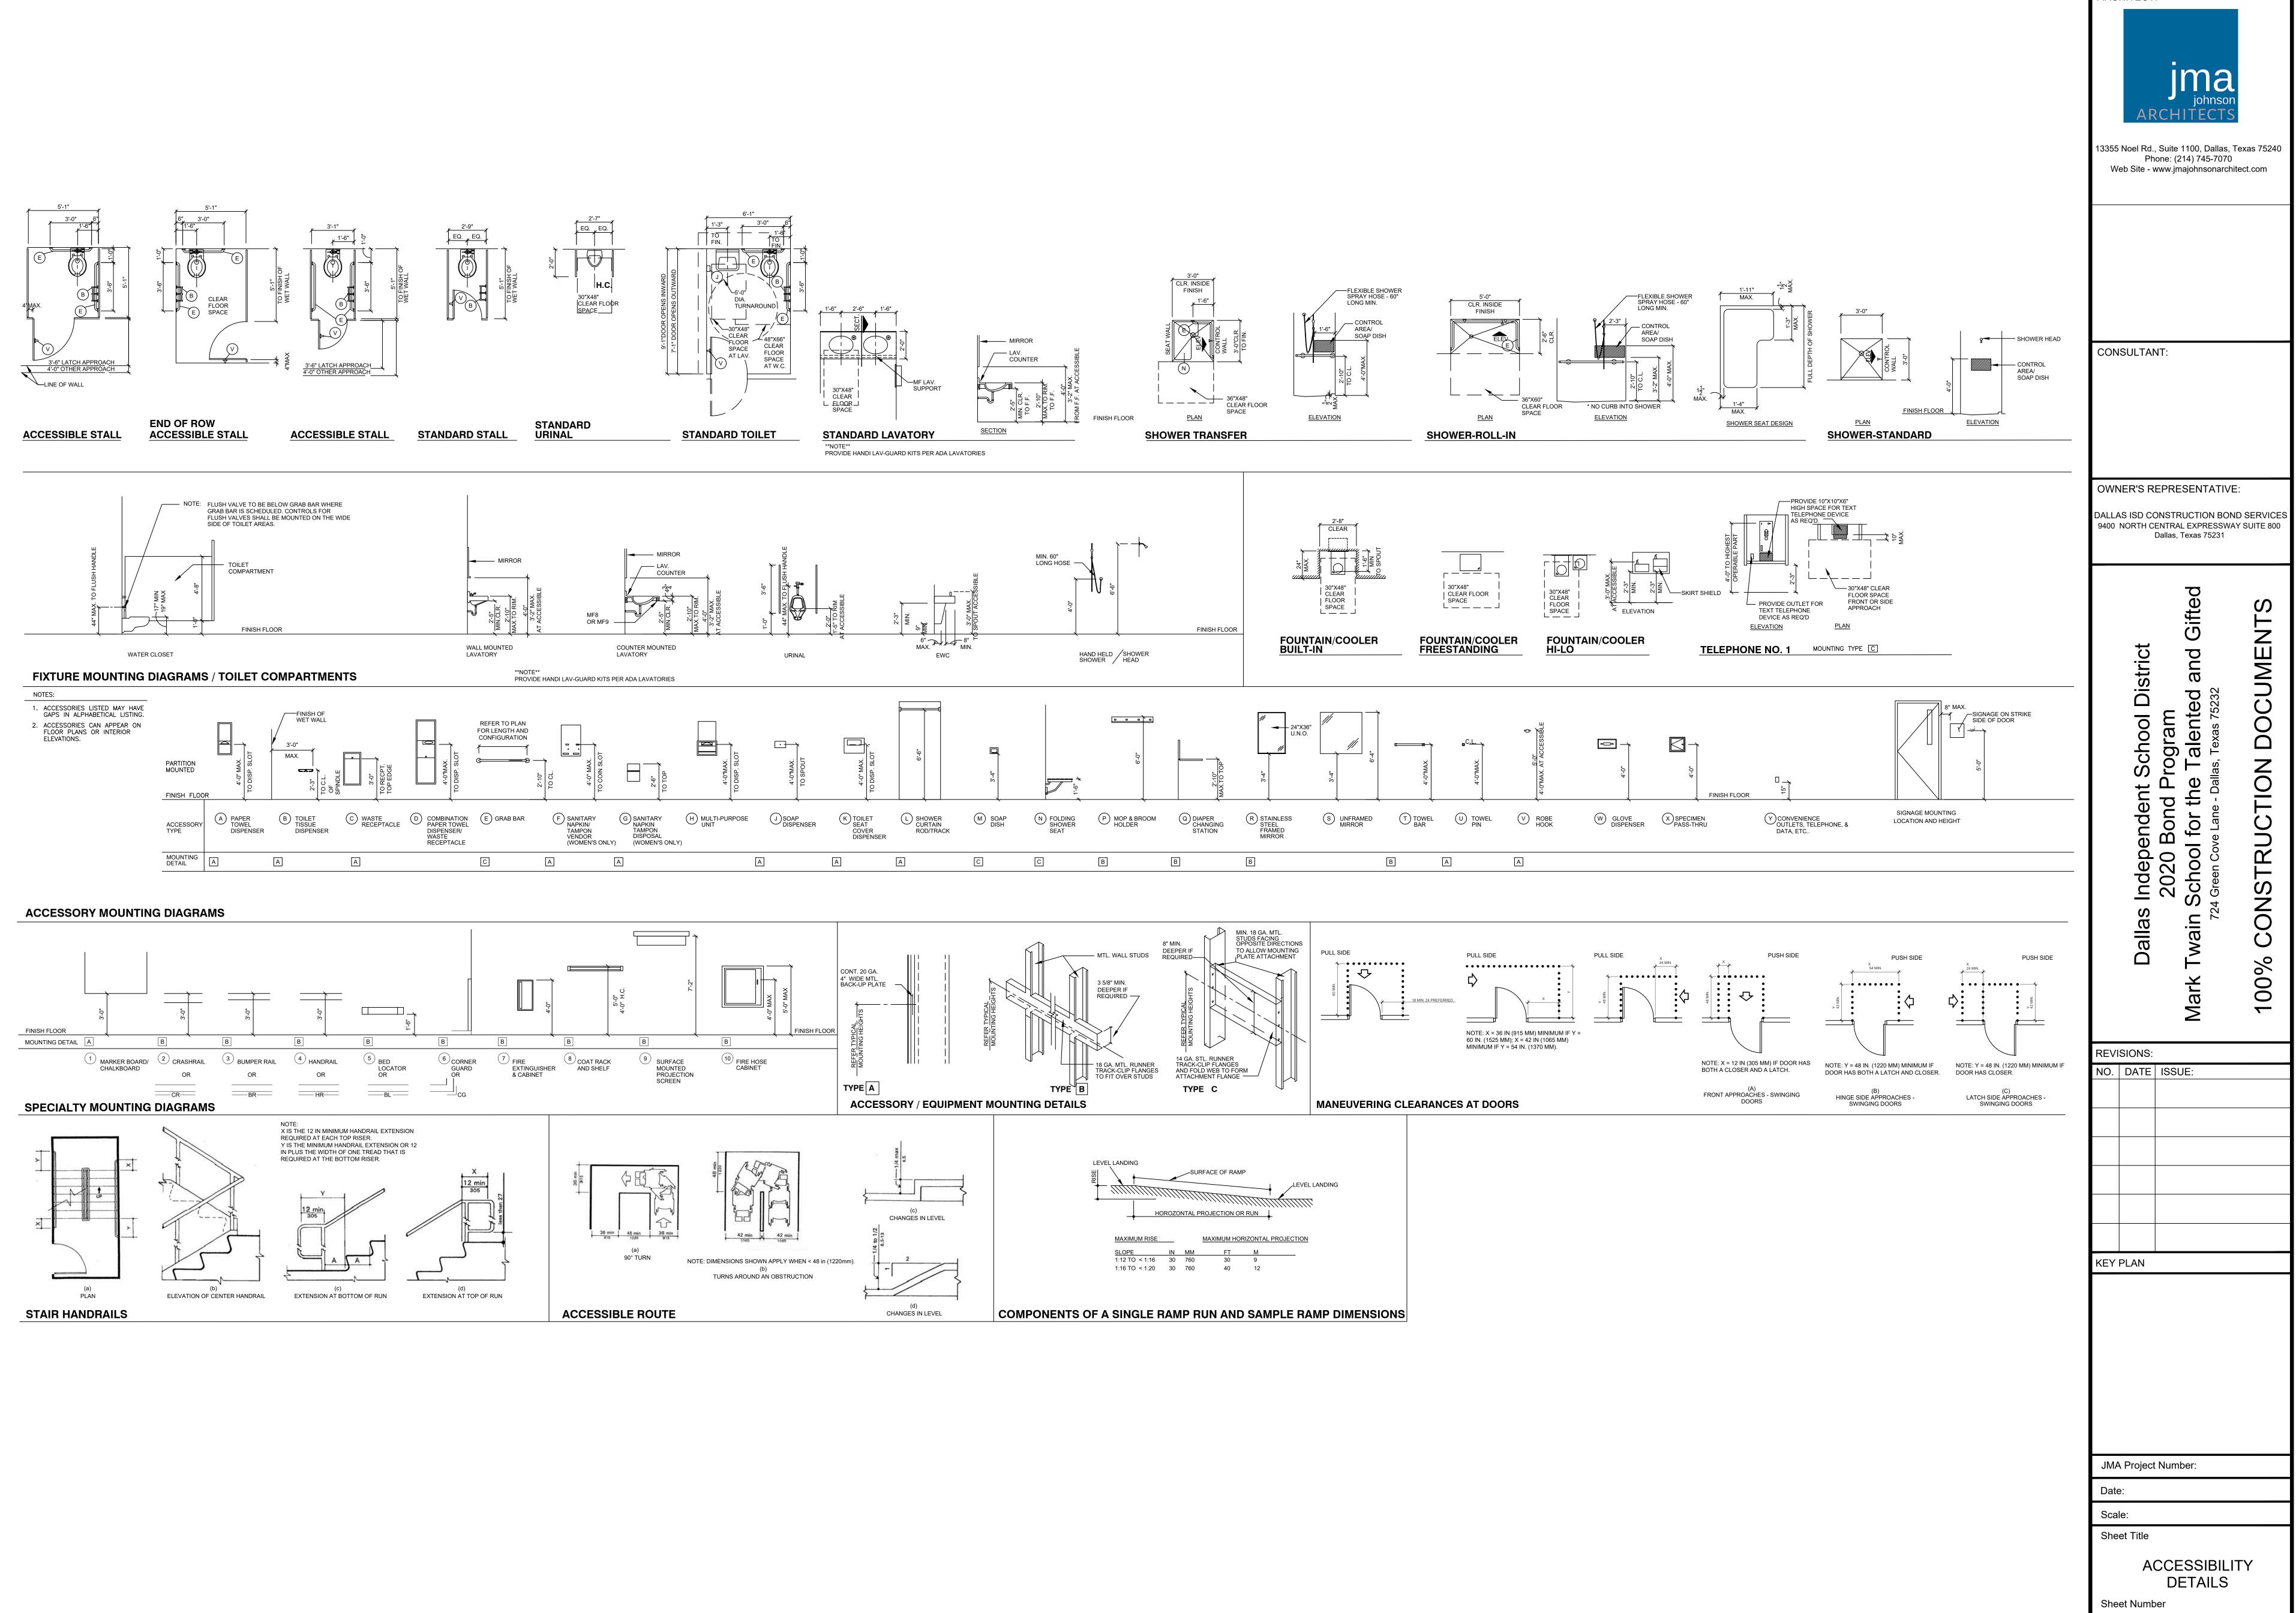



G0.02

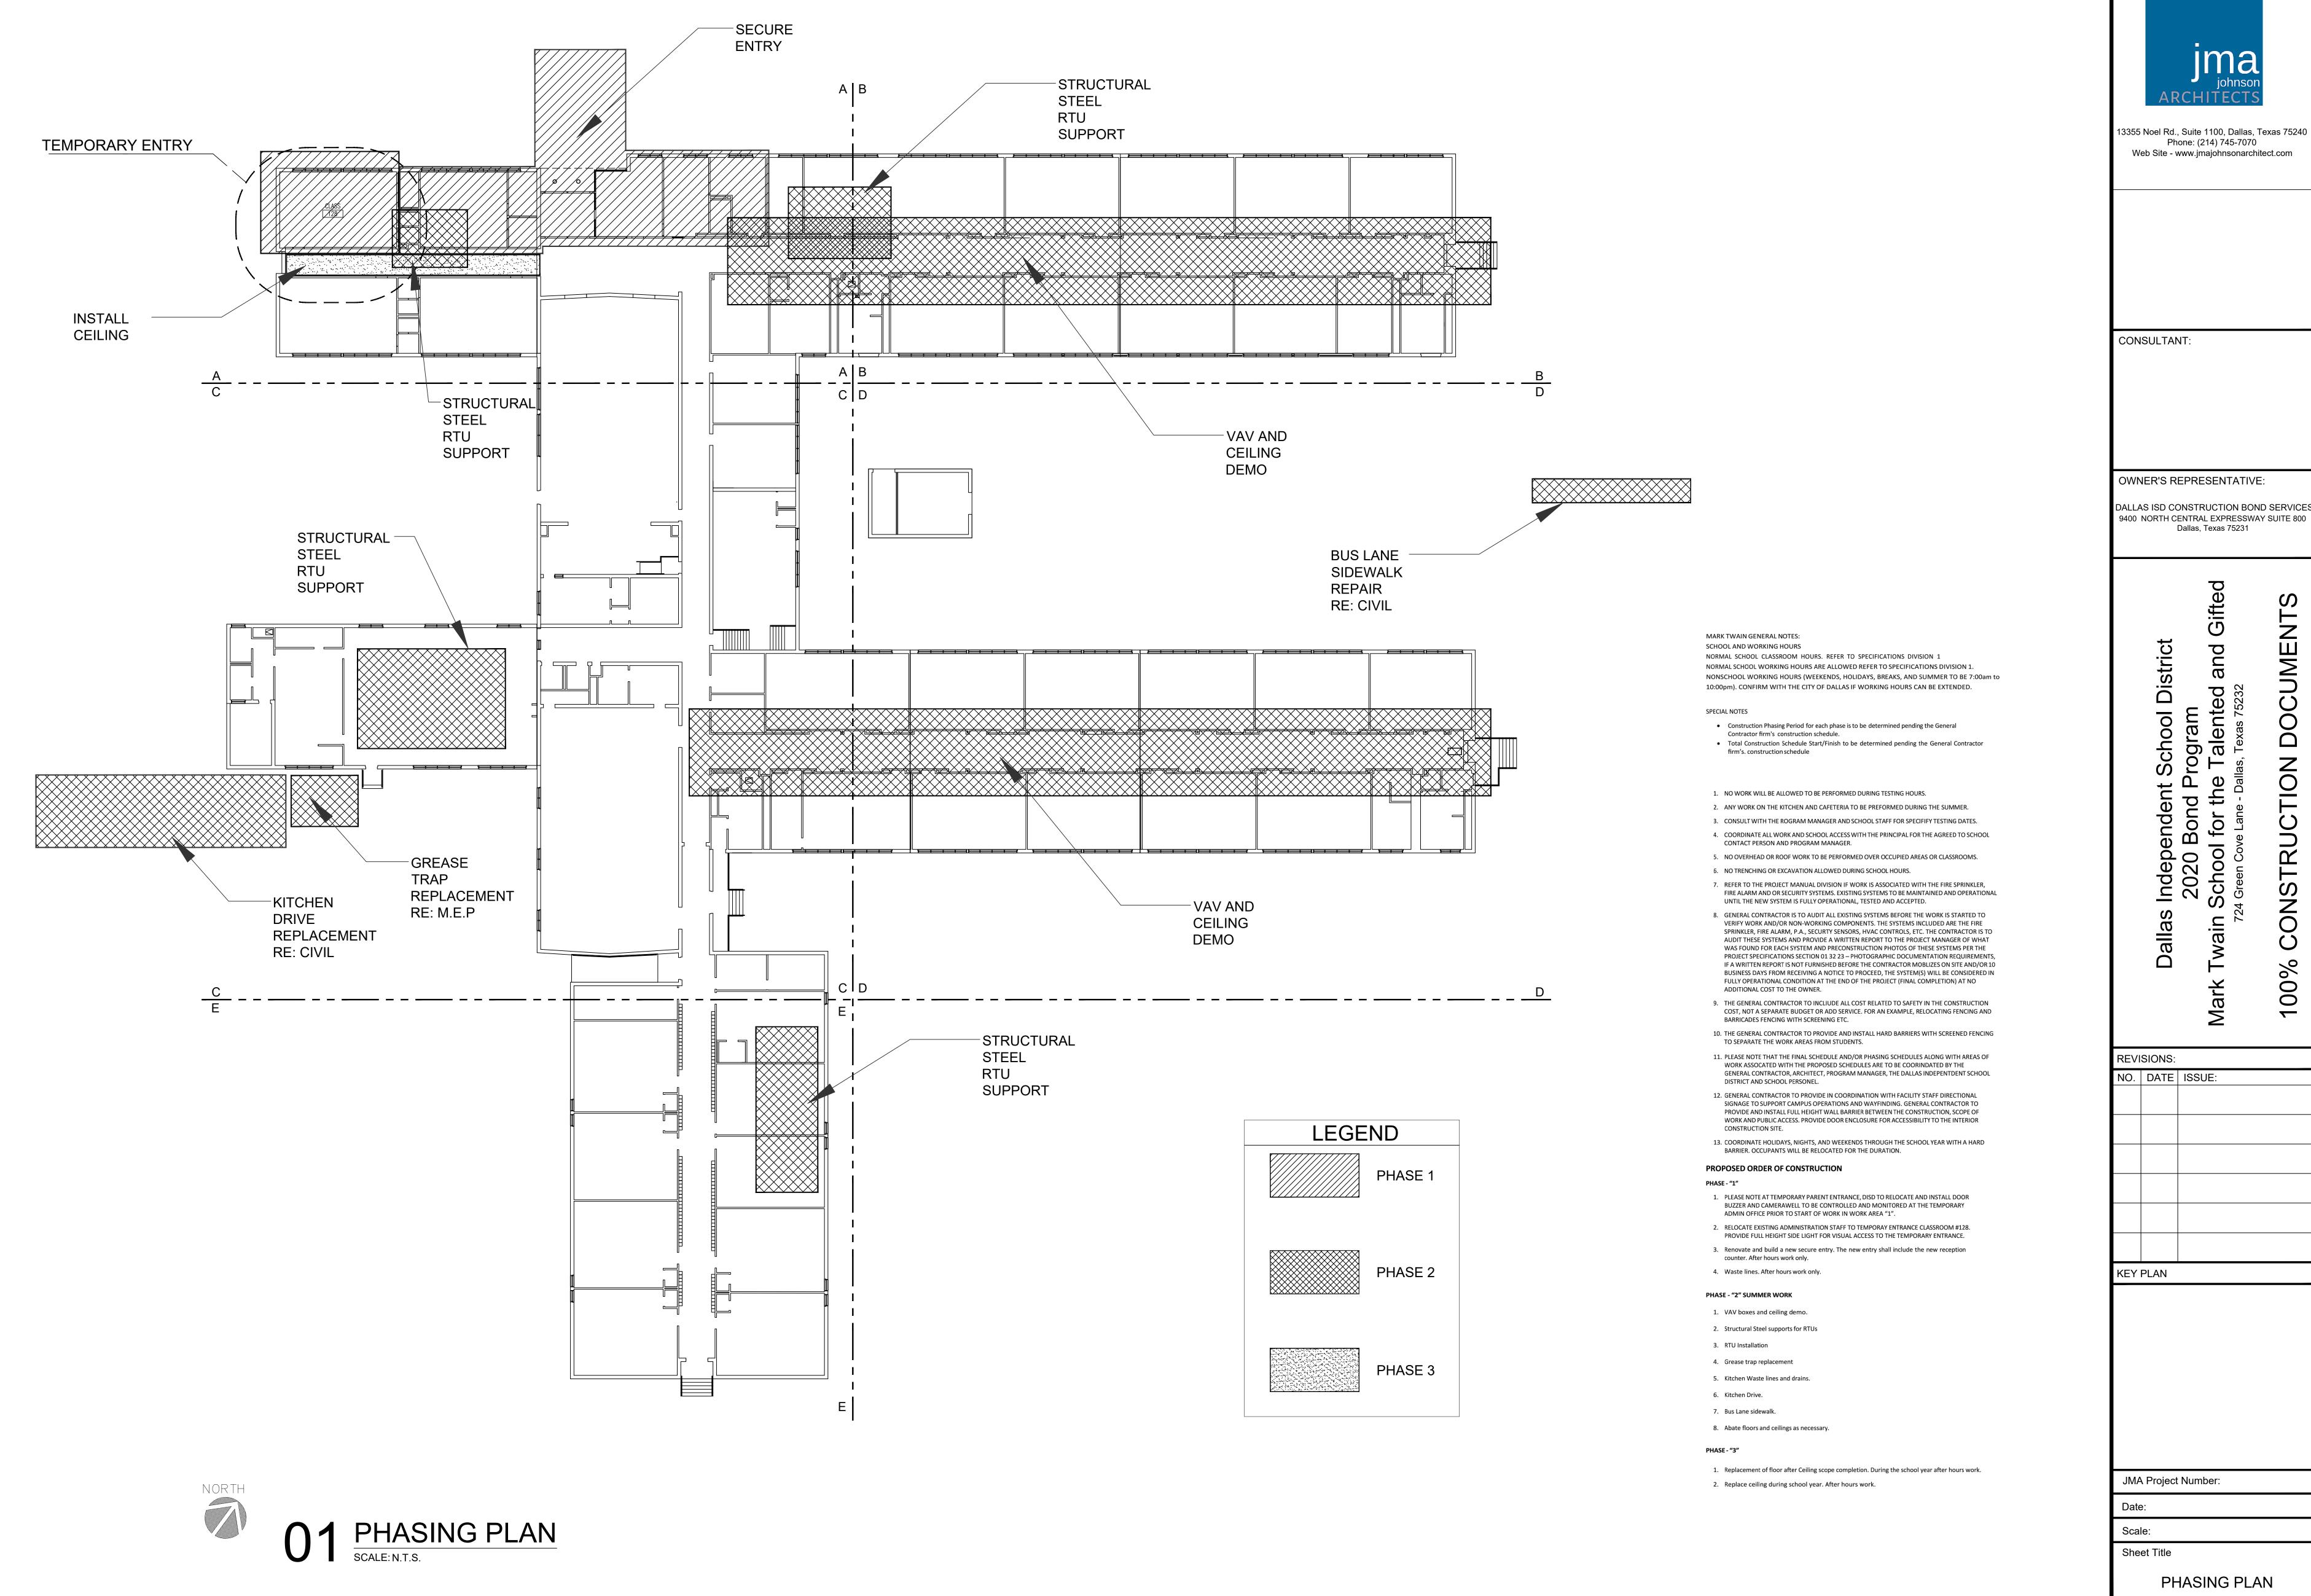

DALLAS ISD CONSTRUCTION BOND SERVICES

Sheet Number

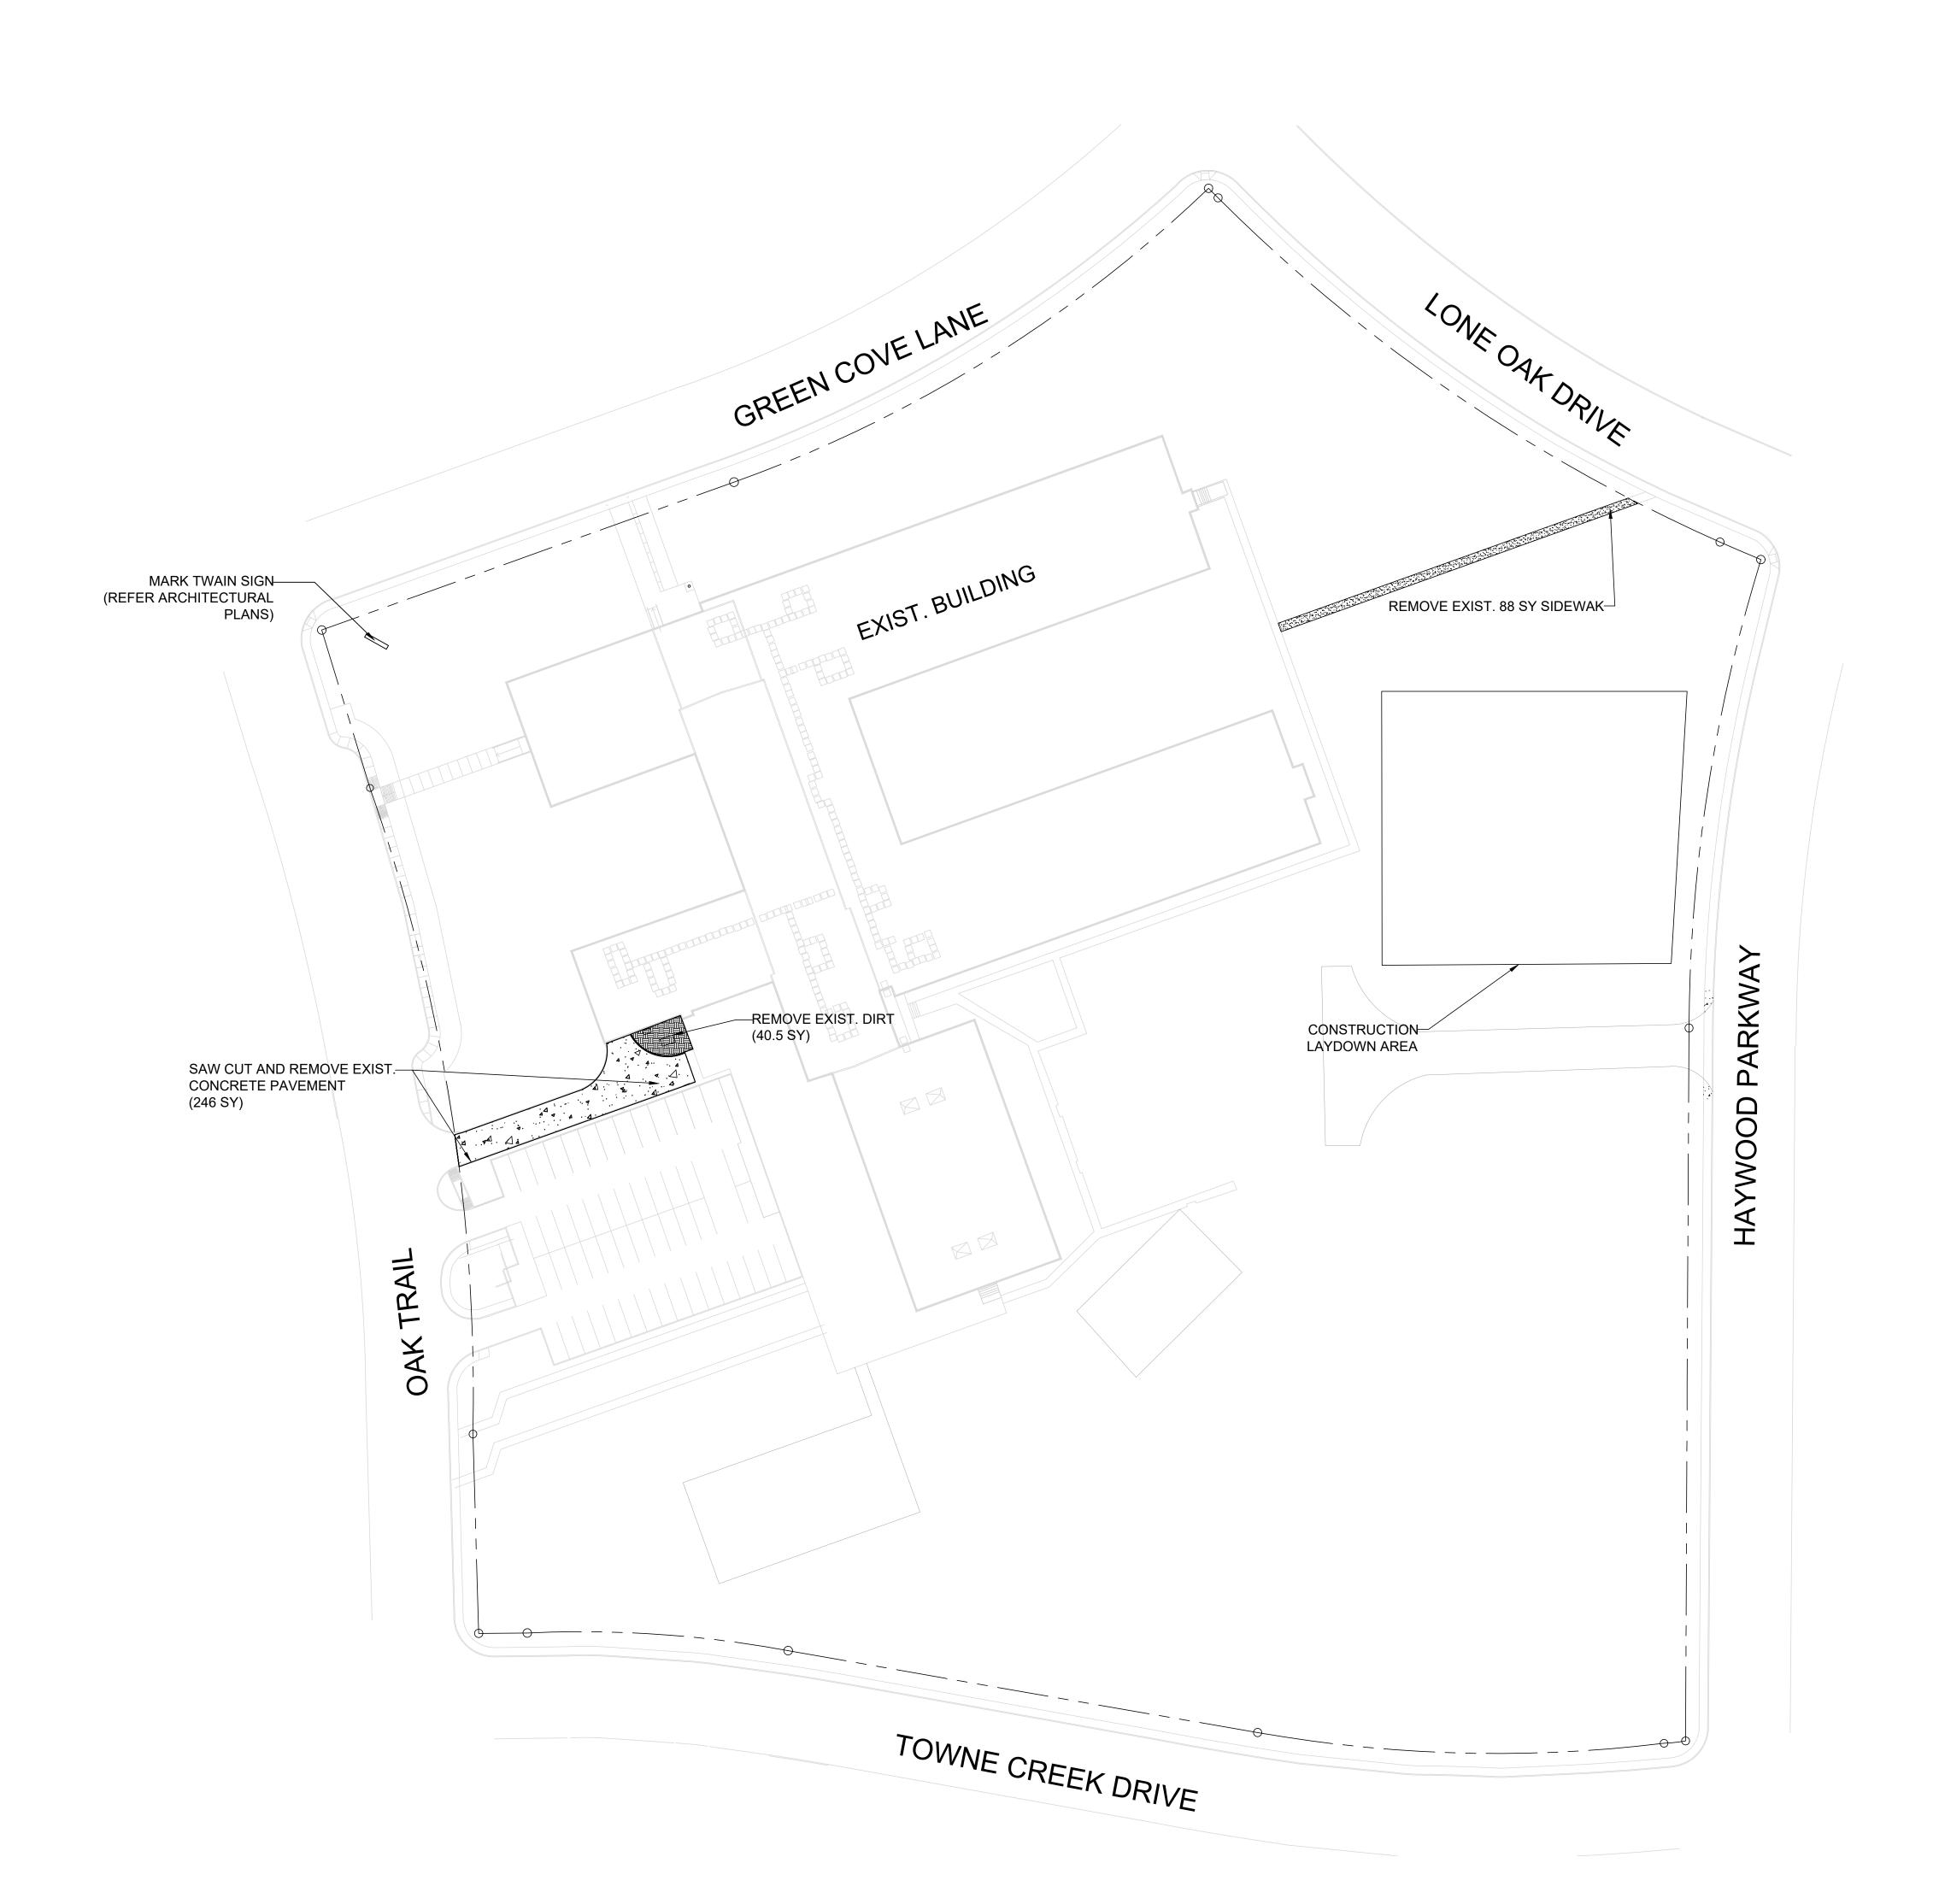

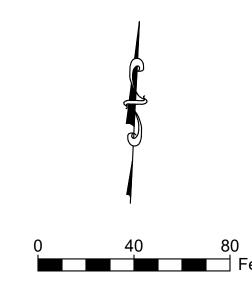

LEGEND

REMOVE DIRT REMOVE EX. SIDEWALK

REMOVE EX. PAVEMENT

_____ RIGHT-OF-WAY

Gohannes Okubay



08/14/2024

NOT	<u>E:</u>

1. SAW CUT AND REMOVE EXISTING SIDEWALK AND CONCRETE PAVEMENT

ARCHITECT:

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INTERIM REVIEW DOCUMENT

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and Gifted **MENTS**

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KEY PLAN

JMA Project Number:


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Sheet Title

DEMO PLAN

Sheet Number

C04.01

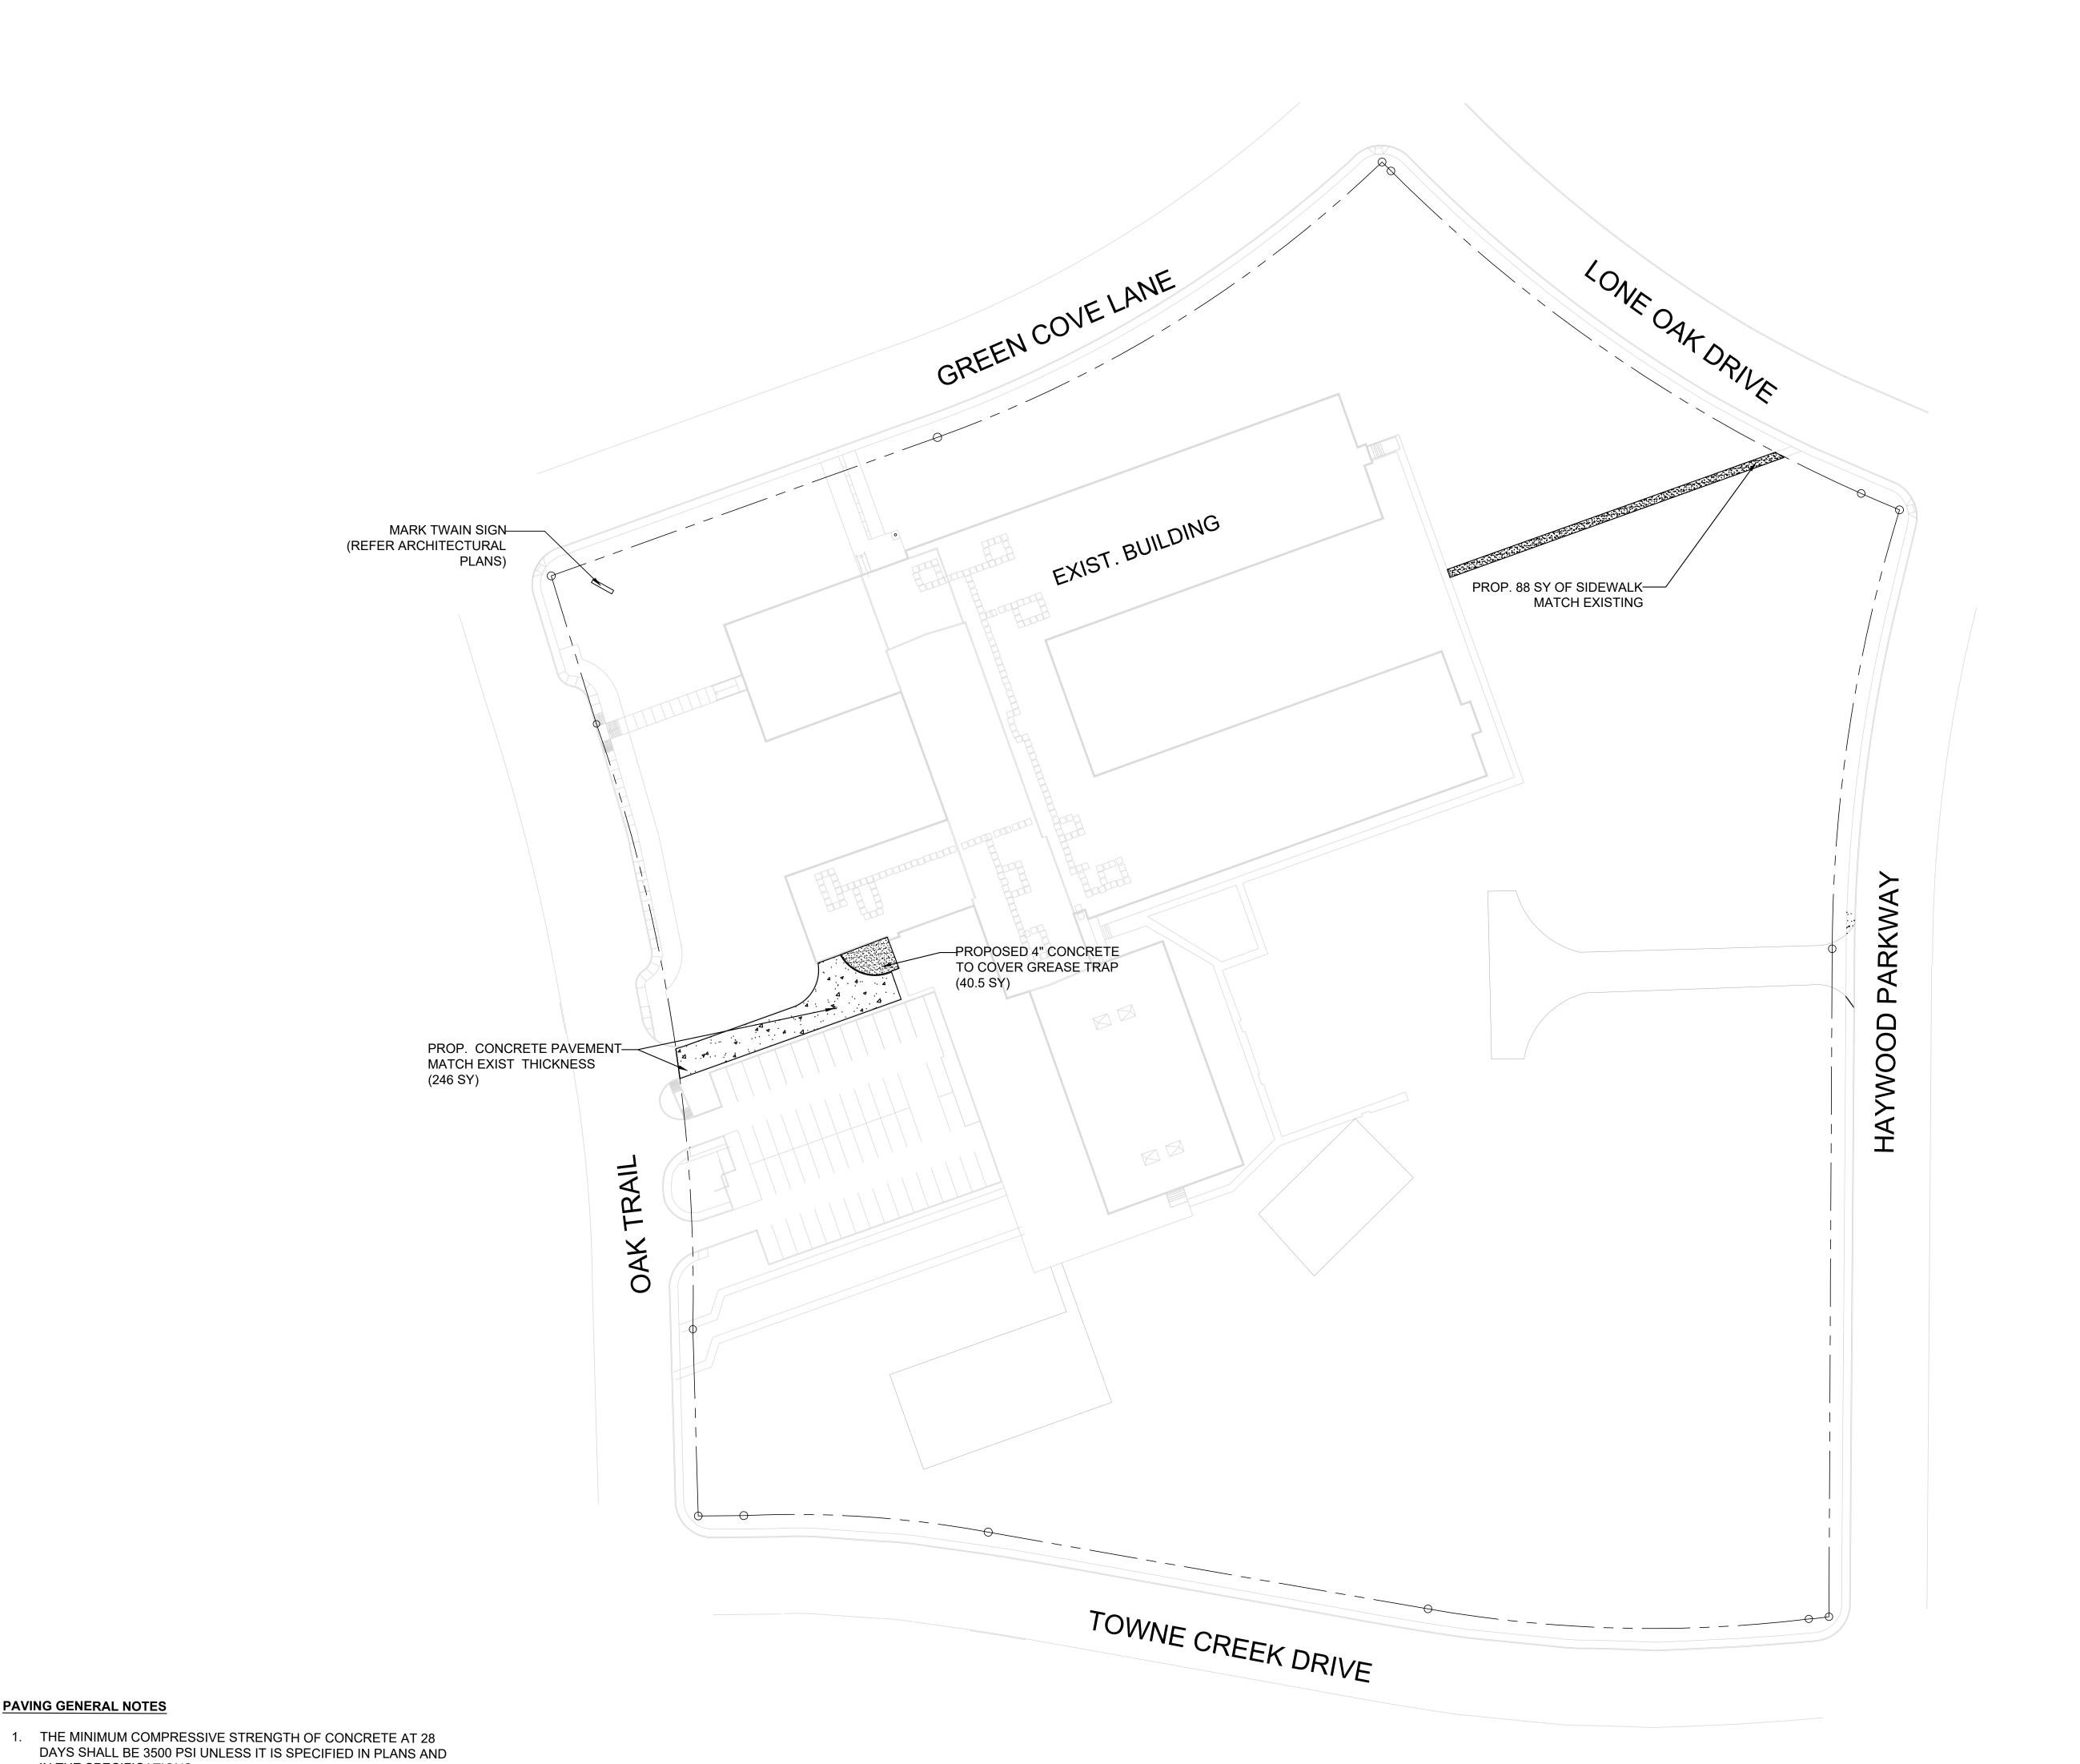

PAVING GENERAL NOTES

ARE MAX 2%.


IN THE SPECIFICATIONS.

INTERVALS AND SPACES.

2. MATCH EXISTING PAVEMENT EXPANSION JOINTS AND

THICKNESS, CONSTRUCTION JOINT AND SAWCUTTING

3. RUNNING SLOPES ON ACCESSIBLE ROUTES MAY NOT EXCEED 5 PERCENT UNLESS DESIGNED AS A RAMP AND CROSS SLOPES

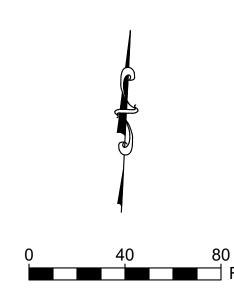


LEGEND

PROP. 4" CONC. SIDEWALK

PROP. CONCRETE PAVEMENT

_____ RIGHT-OF-WAY

Gohannes Okubay

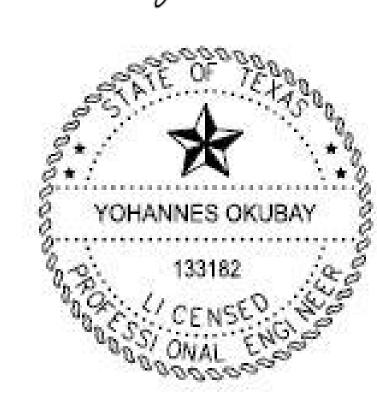

08/14/2024



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INTERIM REVIEW DOCUMENT

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REVISIONS: NO. DATE ISSUE:

KEY PLAN

JMA Project Number:

Scale:

Sheet Title

PAVING PLAN

Sheet Number C05.01

DESIGN LOADS

= 200 LB.

1. GRAVITY LOADS

- A. DESIGN UNIFORM LIVE LOADS ARE AS LISTED BELOW. LIVE LOAD REDUCTIONS ARE CALCULATED IN ACCORDANCE WITH THE IBC 2021 BUILDING CODE.
- B. DESIGN UNIFORM SUPERIMPOSED DEAD LOADS ARE IN ADDITION TO THE WEIGHT OF THE BUILDING STRUCTURE.
- C. DESIGN CONCENTRATED LIVE LOADS ARE NOT COMBINED WITH UNIFORM LIVE LOADS
- FLOOR = 100 PSF
- ROOF = 20 PSF E. UNIFORM SUPERIMPOSED DEAD LOADS
- F. CONCENTRATED LIVE LOADS

D. UNIFORM LIVE LOADS

- = 2000 LB.ROOF
- G. CONCENTRATED FLOOR LOAD APPLIED OVER AREA OF 2'-6" x 2'-6" CONCENTRATED ROOF LOAD APPLIED OVER AREA OF 1'-0" x 1'-0"
- 2. SNOW LOAD
- A. GROUND SNOW LOAD CITY OF DALLAS = 5 PSF
- 3. WIND LOADS

A. IN ACCORDANCE WITH THE INTERNATIONAL BUILDING CODE (IBC 2021)

- B. MAIN WIND FORCE RESISTING SYSTEM DESIGN PARAMETERS (ULTIMATE) CITY OF DALLAS
- BASIC WIND SPEED 3 SEC GUST 120 MPH EXPOSURE CLASS B RISK CATEGORY NOMINAL WIND SPEED SERVICE 93 MPH TOPOGRAPHIC FACTOR, K 1.0 DIRECTIONALITY FACTOR, Kd 1.0

INTERNAL PRESSURE COEFFICIENT 0.00

C. ROOF DESIGN UPLIFT PRESSURES: (ULTIMATE)

GUST FACTOR, G

- = 24 PSF TYPICAL
 - = 35 PSF WITHIN 5'-0" OF EDGE OR STEP IN ROOF = 46 PSF IN CORNER ZONES AS DEFINED IN BUILDING CODE = 27 PSF (AT FASCIA, WINDWARD AND LEEWARD)
- D. EXTERIOR WALL DESIGN PRESSURES: (ULTIMATE
 - = 23 PSF(+), ALL ZONES = 35 PSF(-). INTERIOR ZONES

= 48 PSF(-), EDGE ZONES

- E. ESTIMATED ROOF DEAD LOAD: (NOT INCLUDING STRUCTURE) ROOF DEAD LOAD = 10 PSF
- 4. SEISMIC LOADS
 - A. IN ACCORDANCE WITH INTERNATIONAL BUILDING CODE (IBC 2021)
- B. SEISMIC COEFFICIENTS AND CATEGORIES CITY OF DALLAS
- SEISMIC IMPORTANCE FACTOR 1.25 MAPPED SPECTRAL RESPONSE ACCELERATIONS: 0.2 SEC RESPONSE Ss 0.098 g 1.0 SEC RESPONSE S1 0.053 g SITE CLASS C DESIGN SPECTRAL ACCELERATION PARAMETERS: 0.2 SEC RESPONSE SDS 0.065 g 1.0 SEC RESPONSE SD1 0.035 g SEISMIC DESIGN CATEGORY A
- BASIC SEISMIC FORCE RESISTING SYSTEM CANTILEVERED STEEL COLUMNS
- DESIGN BASE SHEAR..... V = 0.023WSEISMIC RESPONSE COEFFICIENT..... 0.02
- RESPONSE MODIFICATION FACTOR... R = 3.5ANALYSIS PROCEDURE......EQUIVALENT LATERAL FORCE

<u>FOUNDATION</u>

- 1. THESE NOTES APPLY TO ALL FOUNDATIONS AND SLABS ON GRADE DETAILED ON THE STRUCTURAL DRAWINGS, UNLESS NOTED OTHERWISE.
- 2. FOUNDATION DESIGN IS BASED ON THE SOILS REPORT PREPARED BY ALPHA, TESTING, REPORT NO. G231071, DATED JULY 17, 2023.

3. DESIGN END BEARING PRESSURE IS 30 KSF FOR DRILLED STRAIGHT-SHAFT

- PIERS WITH AT LEAST 3'-0" PENETRATION INTO TAN SHALY LIMESTONE AND 50 KSF FOR PIERS WITH AT LEAST 2'-0" PENETRATION INTO THE DARK GRAY LIMESTONE.
- SKIN FRICTION IS 4.5 KSF FOR THE PORTION OF THE SHAFT EMBEDDED MORE THAN 3 FEET INTO TAN SHALEY LIMESTONE AND 7.5 KSF FOR PIERS EMBEDED AT LEAST 2'-0" INTO DARK GRAY LIMESTONE.
- ALLOWABLE UPLIFT SKIN FRICTION IS 3.6 KSF FOR THE PORTION OF THE SHAFT EMBEDDED MORE THAN 3 FEET INTO TAN SHALEY LIMESTONE AND 6.0 KSF FOR PIERS EMBEDED AT LEAST 2'-0" INTO DARK GRAY LIMESTONE. DESIGN UPLIFT PRESSURE IS 2.0 KSF ACTING ON THE SURFACE OF PIER
- 4. CAST CONCRETE WITHIN 8 HOURS OF DRILLING PIER SHAFT INTO BEARING STRATUM, AND IN NO CASE SHALL THE PIER EXCAVATION REMAIN OPEN

SHAFTS FOR A DEPTH OF 12 FEET BELOW EXISTING GROUND SURFACE.

- 6. UNLESS SPECIFIED OTHERWISE, VAPOR BARRIER SHALL CONSIST OF 8 MIL POLYETHYLENE SHEET. TURN DOWN AT GRADE BEAMS AND PIERS. LAP AND SEAL AT ALL JOINTS AND AROUND ALL COLUMNS AND STUB-OUTS. PATCH ALL TEARS PRIOR TO PLACING CONCRETE.
- 7. PROVIDE 10" CARTON FORMS UNDER ALL GRADE BEAMS AND SLABS.
- 8. ALL GRADE BEAMS SHALL BE FORMED ON BOTH SIDES. EARTH-FORMING IS NOT ALLOWED.
- 9. IT MAY BE NECESSARY TO USE TEMPORARY CASING WHILE DRILLING THE PIERS IF UNDERGROUND WATER IS ENCOUNTERED.
- 10. IF TEMPORARY CASINGS ARE NECESSARY, EXTRACTION OF THE CASINGS SHALL BE DONE IN A MANNER THAT MAINTAINS A POSITIVE HEAD OF PLASTIC CONCRETE SO AS TO MINIMIZE THE POTENTIAL FOR INFILTRATION OF WATER SEEPAGE OR SLOUGHING SOILS.

CAST IN PLACE REINFORCED CONCRETE

1. ALL STRUCTURAL CONCRETE SHALL BE OF NORMAL WEIGHT AGGREGATE WITH SPECIFIED PROPERTIES AS FOLLOWS:

GRADE BEAMS	28 DAY STRENGTH - 4000 P.S.I.	SLUMP 3"-5" 5"-7	MAX.AGGREGATE 1"
PIERS SLABS OTHER CONCRETE	- 3000 P.S.I. - 4000 P.S.I. - 3000 P.S.I.	5 -7 3"-5" 3"-5	3/4" 1"

- 2. REINFORCING STEEL SHALL CONFORM TO ASTM A-615, GRADE 60.
- 3. REINFORCING STEEL SPECIFICALLY NOTED TO BE SHOP OR FIELD WELDED REINFORCING STEEL IS NOT PERMITTED.
- 4. ALL REINFORCING SHALL LAP 48 BAR DIAMETERS AT SPLICES UNLESS NOTED OTHERWISE. HOOK CONTINUOUS BARS AT DISCONTINUOUS ENDS.
- = 10 PSF CEILING & MECH'L. + 10 PSF ROOFING 5. WELDED WIRE FABRIC SHALL BE SUPPLIED IN FLAT SHEETS, NOT ROLLS.
 - DETAILING OF CONCRETE REINFORCING AND ACCESSORIES SHALL BE IN ACCORDANCE WITH THE LATEST EDITION OF ACI PUBLICATION 315.

3" TO VERTICAL STEEL

 $1\frac{1}{2}$ " TOP, $1\frac{1}{2}$ " BOTTOM

" SIDES AND TOP

2" BOTTOM TO MAIN STEEL

7. UNLESS NOTED OTHERWISE, CONCRETE PROTECTION FOR REINFORCING SHALL BE AS FOLLOWS:

PIERS SLABS ON CARTON FORM FORMED BEAMS AND WALLS

D. ALL OTHER SHAPES AND PLATES

- NO HORIZONTAL JOINTS WILL BE PERMITTED IN CONCRETE, EXCEPT WHERE VERTICAL JOINTS SHALL OCCUR AT OR NEAR THE CENTER OF SPANS. OR AS APPROVED BY THE STRUCTURAL ENGINEER.
- 9. PROVIDE 5% (+/- 1.5%) AIR ENTRAINMENT IN CONCRETE PERMANENTLY EXPOSED TO WEATHER. USE OF AIR ENTRAINMENT, & CORRESPONDING REDUCTION OF WATER/CEMENT, MUST BE NOTED ON MIX DESIGNS. DO NOT USE AIR ENTRAINMENT IN SLABS WHICH HAVE HARD TROWEL FINISH.
- 10. PLACE 6" P.V.C. WATERSTOPS IN ALL EXTERIOR CONSTRUCTION JOINTS BELOW GRADE AND ELSEWHERE AS CALLED FOR
- 11. SEE SPECIFICATIONS FOR FORMWORK AND RESHORING GUIDELINES

STRUCTURAL STEEL

STRUCTURAL SHAPES AND PLATES SHALL CONFORM TO THE FOLLOWING, UNLESS NOTED OTHERWISE ON THE DRAWINGS:

NOTED OTHERWISE ON THE BROWN	
A. ALL WIDE FLANGE & WT SECTIONS	- ASTM A992, GRADE 50
B. ALL HSS MEMBERS	ASTM A500, GRADE B,46 KSI FOR RECT. SHAPES42 KSI FOR ROUND SHAPES
C. ALL ANCHOR BOLTS	- ASTM F1554, GRADE 36

2. ALL CONNECTION BOLTS FOR STRUCTURAL STEEL MEMBERS SHALL BE 3/4 IN. DIA. CONFORMING TO ASTM A-325. ALL SHEAR CONNECTIONS SHALL BE DESIGNED AS BEARING-TYPE BASED ON THREADS INCLUDED IN THE SHEAR PLANE. UNLESS NOTED OTHERWISE, ALL BOLTS SHALL BE TIGHTENED TO A "SNUG TIGHT" CONDITION, DEFINED AS "A FEW IMPACTS OF AN IMPACT WRENCH OR THE FULL EFFORT OF A WORKER WITH AN ORDINARY SPUD WRENCH THAT BRINGS CONNECTED PLIES INTO FIRM CONTACT"

- ASTM A36

- 3. ALL WELDING SHALL BE DONE IN ACCORDANCE WITH A.W.S. CODE, BY CERTIFIED WELDERS. WELDING ELECTRODES SHALL BE E70 XX.
- 4. SEE SPECIFICATIONS FOR PRIMER SURFACE PREPARATION REQUIREMENTS. DO NOT APPLY PRIMER TO ANY STEEL PARTS THAT ARE TO BE ENCASED IN CONCRETE OR ARE TO BE FIREPROOFED USING BLOWN-UP FIREPROOFING MATERIALS.
- 5. ALL BEAM TO BEAM AND BEAM TO COLUMN CONNECTIONS SHALL BE DESIGNED AS "SIMPLE CONNECTIONS", AND SHALL BE SHOP WELDED AND FIELD BOLTED. SHEAR CONNECTIONS SHALL BE DESIGNED FOR THE REACTION SHOWN ON PLANS, WHICH ARE UNFACTORED, BASED ON WORKING LOADS. IF NO REACTION IS SHOWN, THE CONNECTION SHALL BE DESIGNED FOR 50% OF THE TOTAL LOAD CAPACITY LISTED ON THE TABLE: "MAXIMUM TOTAL UNIFORM LOAD" (Tbl. 3-6), OF THE AISC MANUAL OF STEEL CONSTRUCTION, LATEST EDITION. IN NO CASE, HOWEVER, SHOULD ANY CONNECTION BE DESIGNED FOR LESS THAN 7 KIPS, UNFACTORED
- 6. SHEAR CONNECTIONS NOT SPECIFICALLY DETAILED ON THE STRUCTURAL DRAWINGS SHALL BE DESIGNED AND DETAILED BY THE STRUCTURAL STEEL FABRICATOR UNDER THE DIRECT SUPERVISION OF A PROFESSIONAL ENGINEER, REGISTERED IN THE STATE OF TEXAS, USING THE DESIGN PARAMETERS INDICATED ON NOTE NO. 5 ABOVE
- 7. CONNECTIONS INDICATED AS MOMENT CONNECTIONS IN THE STRUCTURAL DRAWINGS SHALL BE DESIGNED TO RESIST THE FULL MOMENT CAPACITY OF THE SUPPORTED SHEAR CONNECTIONS IN MOMENT CONNECTIONS MAY BE EITHER WELDED OR BOLTED, AT STEEL FABRICATOR'S OPTION.
- 8. PROVIDE STIFFENERS AT ALL LOCATIONS SHOWN ON DETAILS, WHETHER OR NOT THEY ARE REQUIRED BY CALCULATIONS.
- 9. ALL COLUMN BASE PLATES SHALL BE FULLY GROUTED, WITH NO VOIDS, IMMEDIATELY AFTER THE FRAME ERECTION IS COMPLETED AND PLUMBED, AND PRIOR TO POURING THE TOPPING SLABS FOR FLOORS OR APPLYING DECKING TO ROOF JOISTS.
- 10. SEE SPECIFICATIONS FOR EXPOSED STEEL REQUIREMENTS

METAL ROOF DECK

- 1. THE METAL ROOF DECK IS REQUIRED TO ACT AS A STRUCTURAL DIAPHRAGM AND SHALL BE FASTENED IN ACCORDANCE WITH THE MANUFACTURER'S SPECIFICATIONS TO DEVELOP A MINIMUM SHEAR LOAD OF 300 PLF (ASD)
- 2. THE METAL ROOF DECK SHALL BE FASTENED TO SUPPORTS AND PERIMETER USING 5/8" DIAMETER FULL FUSION PUDDLE WELDS AND AT SIDELAPS USING #12 "TEKS" SCREWS. ALL WELDS SHALL BE MADE WITH AWS E70 ELECTRODES AND THE METAL AROUND THE WELDS SHALL BE COMPLETELY INTACT AFTER WELDING.
- 3. MAXIMUM SPACING OF CONNECTIONS SHALL BE AS FOLLOWS:
- A. AT SUPPORTS: ALTERNATE FLUTES
- B. AT SIDELAPS: 18"
- C. PERIMETER: 12"
- 4. THE METAL ROOF DECK SHALL BE CONTINUOUS OVER THREE OR MORE SPANS

HOLLOW CONCRETE MASONRY

- 1. MASONRY WALL DESIGN IS BASED ON QUALITY ASSURANCE AS PRESCRIBED IN IBC 2021 SECTION 2105 BASED ON DESIGN FOR FULL STRESSES, AND AS PRESCRIBED IN ACI-530.1 SECTION 1.14.
- ALL HOLLOW CONCRETE BLOCK SHALL CONFORM WITH ASTM C90, TYPE N-I, AND SHALL HAVE A COMPRESSIVE STRENGTH, BASED ON THE NET AREA AND AN AVERAGE OF 3 UNITS, OF 1,900 PSI.
- MORTAR FOR REINFORCED HOLLOW CONCRETE MASONRY SHALL BE TYPE S WITH
- GROUT FOR REINFORCED HOLLOW CONCRETE MASONRY SHALL HAVE THE

A MINIMUM 28 DAY COMPRESSIVE STRENGTH OF 1800 PSI.

- FOLLOWING PROPERTIES: A. MINIMUM STRENGTH = 2500 PSI AT 28 DAYS
- MAXIMUM COARSE AGGREGATE SIZE = 3/8"
- C. SLUMP = 7" TO 11"

PLACE GROUT IN LIFTS OF 4'-0" OR LESS. GROUT ALL CELLS CONTAINING REINFORCING STEEL OR EMBEDDED METALS. DO NOT USE MORTAR AS GROUT

- PROVIDE HORIZONTAL JOINT REINFORCEMENT AT EVERY SECOND BLOCK COURSE UNLESS NOTED IN THE SPECIFICATION. PROVIDE HORIZONTAL BOND BEAMS IN LOAD-BEARING WALLS, LOCATED AT ROOF BEARING, TOP OF PARAPET AND AT 8'-0" O.C. MAXIMUM. REQUIRED INTERMEDIATE BOND BEAMS SHALL BE SPACED UNIFORMLY THROUGHOUT THE HEIGHT OF THE WALL
- 6. U.N.O. REINFORCE BOND BEAMS WITH 2-#5 CONTINUOUS, AND EXTEND BOND BEAM REINFORCING CONTINUOUS THROUGH CONTROL JOINTS.
- 7. U.N.O. ON PLANS PROVIDE VERTICAL REINFORCEMENT AS FOLLOWS
- 12" CONCRETE BLOCK = #6 AT 24" O.C.E.F.
- 1-#5 EACH END OF WALL 1-#5 EACH CORNER OR INTERSECTION IN WALL
- 1-#5 EACH SIDE OF OPENING IN WALL
- 1-#5 EACH OF THREE CELLS UNDER STEEL BEAM SUPPORT ON WALL F. 1-#5 EACH CELL IN COLUMN
 - ALL VERTICAL REINFORCING STEEL SHALL BE CENTERED IN CELLS UNLESS NOTED
- OTHERWISE. PROVIDE VERTICAL DOWELS TO MATCH SIZE AND LOCATIONS OF VERTICAL BAR LAP WITH VERTICAL REINFORCING AS NOTED BELOW. WHERE NO EMBEDMENT
- IS SHOWN, EMBED DOWELS 30 BAR DIAMETERS INTO FOUNDATION CONCRETE
- 9. LAP SPLICES IN MASONRY REINFORCEMENT
- A. #3 BARS LAP 15"
- #4 BARS LAP 24" #5 BARS LAP 30"
- D. #6 BARS LAP 36¢
- ALL HORIZONTAL REINFORCING BARS IN LINTEL BEAMS SHALL BE CONTINUOUS BARS WITH NO SPLICES. ALL OTHER MASONRY REINFORCEMENT SHALL LAP 40 BAR DIAMETERS AT SPLICES UNLESS NOTED OTHERWISE
- VERTICAL REINFORCEMENT SHALL BE MADE CONTINUOUS AT THE BASE OF ALL PARAPETS. SPLICING REINFORCEMENT AT THIS LOCATION IS NOT ALLOWED.
- HORIZONTAL REINFORCEMENT SHALL BE MADE CONTINUOUS AT THE FACE OF ALL CANTILEVERS. SPLICING REINFORCEMENT AT THIS LOCATION IS NOT ALLOWED.

<u>GENERAL</u>

CHAMFERS, ETC.

- 1. ALL MEMBERS AND MATERIALS COVERED UNDER THESE GENERAL NOTES AND THE CONSTRUCTION DOCUMENTS SHALL AS A MINIMUM BE INSPECTED IN ACCORDANCE WITH THE IBC 2015 CODE CHAPTER 17 : STRUCTURAL TESTS AND SPECIAL
- 2. SEE MECHANICAL DRAWINGS FOR EXACT LOCATION AND SIZES OF SMALL MECHANICAL OPENINGS, SLEEVES, ETC. NOT SHOWN ON THE STRUCTURAL DRAWINGS.
- REFER TO ARCHITECTURAL DRAWINGS FOR ALL FINISHES, DIMENSIONS OF SLAB DROPS,
- 4. THE USE OF REPRODUCTIONS OF THE DESIGN STRUCTURAL DRAWINGS FOR SHOP DRAWING PURPOSES IS NOT ACCEPTABLE.
- 5. THE CONTRACTOR SHALL VERIFY, PRIOR TO CONSTRUCTION, THAT THE NEW STRUCTURE WILL NOT CONFLICT WITH ANY EXISTING UTILITIES. IF CONFLICTS ARISE, THE CONTRACTOR SHALL NOTIFY THE STRUCTURAL ENGINEER, AND SHALL STOP THE WORK UNTIL AN APPROPRIATE SOLUTION TO THE CONFLICTS ARE FOUND, AND THE CONTRACTOR IS GIVEN WRITTEN AUTHORIZATION TO PROCEED WITH THE WORK
- 6. ALL MISCELLANEOUS ANGLES, CHANNELS, TUBES ETC. REQUIRED FOR THE PRIMARY STRUCTURE ARE AS SHOWN AND SIZED ON THE STRUCTURAL DRAWINGS. ANY ADDITIONAL MISCELLANEOUS MEMBERS REQUIRED FOR SECONDARY SYSTEMS SHALL BE FURNISHED AS REQUIRED AND SIZED AS SHOWN ON THE ARCHITECTURAL AND MECHANICAL DRAWINGS. IN THE EVENT THAT THE NUMBER AND SIZE OF SECONDARY BRACING MEMBERS SHOWN GRAPHICALLY ON ANY OTHER DRAWINGS ARE OMITTED, ASSUME L3x3x4 (LENGTH AS SCALED) SPACED AT 48" O.C. MAXIMUM FOR BIDDING PURPOSES. ALSO ASSUME ANY TUBES SHOWN BUT NOT SIZED TO BE HSS4x4x1/4 (LENGTH AS SCALED) FOR BIDDING PURPOSES.
- IN THIS BID, THE CONTRACTOR SHALL INCLUDE AN ALLOWANCE OF 1,000 LBS OF STRUCTURAL STEEL FOR SUPPLEMENTARY STRUCTURAL ELEMENTS, TO BE FURNISHED AND INSTALLED AS DIRECTED BY THE ARCHITECT OR THE STRUCTURAL ENGINEER.

EXISTING CONDITIONS

- 1. ALL EXISTING STRUCTURAL ELEMENTS (SLABS, BEAMS, COLUMNS, ETC.) SHALL REMAIN
- INFORMATION PROVIDED ON THESE DRAWINGS RELATED TO EXISTING CONDITIONS IS BASED ON AVAILABLE DESIGN DOCUMENTS AND LIMITED FIELD OBSERVATION.THE CONTRACTOR SHALL IMMEDIATELY REPORT TO AND AWAIT DIRECTION FROM THE A/E IF ANY DISCREPANCY BETWEEN THE CONTRACT DOCUMENTS AND THE EXISTING CONDITIONS IS DISCOVERED.
- CAUTION SHALL BE USED DURING THE EXISTING CLADDING REMOVING OPERATION DO NOT DAMAGE OR ALTER EXISTING CLADDING WITHIN CLOSE PROXIMITY TO THE AREAS UNDER CONSTRUCTION. DO NOT DAMAGE EXISTING METAL STUDS AND MISCELLANEOUS STRUCTURAL STEEL DURING DRILLING OR CORING OPERATIONS. DURING WELDING OPERATIONS PROTECT CLADDING. EXISTING METAL STUDS AND MISCELLANEOUS STRUCTURAL STEEL, EXTERIOR SHEATHING AND VAPOR RETARDER AT ALL TIMES. AFTER WORK IS COMPLETED, VERIFIED AND APPROVED BY THE TESTING LAB REPRESENTATIVE THE AREAS UNDER CONSTRUCTION SHALL BE RETURNED TO ITS ORIGINAL STATE OR BETTER.
- 4. THIS PROJECT REQUIRES A SIGNIFICANT AMOUNT OF DRILLING INTO THE EXISTING REINFORCED CONCRETE STRUCTURE. THE CONTRACTOR WILL NOT RECEIVE ADDITIONAL PAYMENT FOR DIFFICULTIES ENCOUNTERED IN DRILLING DUE TO HARDNESS OF MATERIALS, HITTING OF EXISTING REINFORCING, ETC. ALL COSTS ASSOCIATED WITH REDRILLING OF HOLES DUE TO HITTING EXISTING REINFORCING STEEL SHALL BE BORNE BY THE CONTRACTOR. THIS INCLUDES FILLING UNNECESSARY AND UNUSED HOLES WITH EPOXY GROUT. DO NOT CUT REINFORCING STEEL DURING CONCRETE DRILLING OR CORING OPERATIONS. LOCATE REINFORCING WITH A PACHOMETER OR OTHER NON-DESTRUCTIVE TESTING DEVICE PRIOR TO DRILLING OR CORING OPERATIONS.
- 5. CORE DRILLS REQUIRED BY MECHANICAL OR ELECTRICAL TRADES, BUT NOT SHOWN ON THE STRUCTURAL DRAWINGS SHALL BE DOCUMENTED IN SKETCH FORM SHOWING EXACT DIMENSIONS AND LOCATIONS. THE SKETCH SHALL BE SUBMITTED TO THE A/E FOR COMMENT PRIOR TO PROCEEDING WITH THE DRILLING OPERATION.
- 6. EXISTING CONCRETE SURFACE PREPARATION:

INTENTIONALLY ROUGHEN EXISTING CONCRETE SURFACES WHERE NEW CONCRETE IS BEING PLACED AGAINST THE EXISTING CONCRETE AND CONNECTED BY DRILLING AND EPOXY GROUTING. THE ENTIRE COMMON SURFACE WHERE THE EXISTING CONCRETE ABUTS THE NEW SHALL BE COATED WITH AN EPOXY BONDING AGENT. FOLLOW ALL ADDITIONAL REQUIREMENTS OF SURFACE PREPARATION AS REQUIRED BY THE BONDING AGENT MANUFACTURER.

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Date:

Scale: Sheet Title

STRUCTURAL ABBREVIATIONS AND **GENERAL NOTES**

Sheet Number

REQUIRED SPECIAL INSPECTIONS

NOTES

1. THE OWNER SHALL EMPLOY QUALIFIED SPECIAL INSPECTORS TO PERFORM INSPECTIONS IN ACCORDANCE WITH THE 2021 INTERNATIONAL BUILDING CODE. INSPECTORS SHALL PERFORM ALL DUTIES AND RESPONSIBILITIES AS REQUIRED BY THE BUILDING CODE. JOB SITE VISITS BY THE STRUCTURAL ENGINEER DO NOT CONSTITUTE AND ARE NOT A SUBSTITUTE FOR SPECIAL INSPECTIONS.

THE FOLLOWING SCHEDULE CONTAINS A LIST OF THE SPECIAL INSPECTION ACTIVITIES RELATED TO THE QUALITY ASSURANCE PLAN REQUIRED BY THE 2021 INTERNATIONAL BUILDING CODE (IBC CHAPTER 17) FOR THE FABRICATION, ERECTION AND CONSTRUCTION OF THE STRUCTURAL SYSTEMS AS DESCRIBED IN THE SPECIFICATION AND DRAWINGS FOR THE PROJECT. ALL INSPECTORS SHALL BE QUALIFIED BY TRAINING AND EXPERIENCE FOR THE REQUIRED INSPECTIONS AND TEST PROCEDURES. REFER TO IBC CHAPTER 17 "STRUCTURAL TESTS AND SPECIAL INSPECTIONS", AND SPECIFICATION SECTION 01 45 23 "TESTS AND INSPECTIONS", FOR SPECIFIC TEST PROCEDURES.

TESTING AND INSPECTION REPORTS SHALL BE PREPARED FOR EACH INSPECTION ITEM ON A DAILY BASIS WHENEVER INSPECTIONS ARE MADE ON THAT ITEM. REPORTS SHALL BE DISTRIBUTED TO THE OWNER, CONTRACTOR, ARCHITECT, STRUCTURAL ENGINEER, AND BUILDING OFFICIAL (IF REQUESTED), FOR THEIR REVIEW, COMMENT, AND ACTION, AS NEEDED.

4. ARCHITECTURAL, MECHANICAL AND ELECTRICAL COMPONENTS REQUIRING SPECIAL INSPECTIONS PER SECTION 1705 OF THE 2021 IBC HAVE NOT BEEN LISTED HERE. REFER TO ARCH/MEP FOR SPECIAL INSPECTION REQUIREMENTS FOR THESE COMPONENTS.

5. IT IS THE CONTRACTOR'S SOLE RESPONSIBILITY TO ENSURE THESE TESTS AND INSPECTIONS ARE PERFORMED.

STRUCTURAL STEEL REQUIRED VERIFICATION AND INSPECTION OF STRUCTURAL STEEL (REF TABLE 1705.3 OF IBC)					CONCRETE AND REINFORCING STEEL						
						GENERAL					
VERIFICATION AND INSPECTION	CONTINUOUS	PERIODIO	REFERENCED STANDARD	IBC REFERENCE	E	INSPECTION ITEM REQUIRED	CONTINUOUS	PERIODIC	REFERENCED STANDARD	IBC REFERENCE	
1. MATERIAL VERIFICATION OF HIGH-STRENGTH BOLTS, NUTS AND WASHERS						TAKE CONCRETE SPECIMENS FOR STRENGTH TESTS TO BE PERFORMED IN LAB. A MINIMUM OF FIVE (5) CYLINDERS SHALL BE MADE. TEST					
A. IDENTIFICATION MARKINGS TO CONFORM TO ASTM STANDARDS SPECIFIED IN THE APPROVED CONSTRUCTION DOCUMENTS.	-	X	APPLICABLE ASTM MATERIAL STANDARDS; AISC 360, SECTION A3.3	'	1.	TWO AT SEVEN DAYS, TWO AT 28 DAYS. THE FIFTH CYLINDER SHALL BE TESTED AT 28 DAYS IF ONE OR BOTH OF THE 28-DAY CYLINDER RESULTS ARE BELOW STRENGTH, IN ACCORDANCE WITH ACI 214.	×				
B. MANUFACTURER'S CERTIFICATE OF COMPLIANCE REQUIRED.		Х			2.	PERFORM CONCRETE STRENGTH TESTING IN LAB	х				
c. VERIFY CORRECT STURCTURAL STEEL MATERIAL DELIVERED TO JOBSITE.		х			3.	MAINTAIN A SPREADSHEET SHOWING THE DATE, SEQUENTIAL ORDER OF STRENGTH TEST RESULTS AND INDICATE THE RUNNING AVERAGE	х				
2. INSPECTION OF HIGH-STRENGTH BOLTING					4.	OBSERVE FOR PROPER CONCRETE PLACEMENT	X				
A. SNUG-TIGHT JOINTS.		Х			\vdash	REQUIRED VERIFICATION AND INSPECTION OF CONCRE	TE CONSTRUCT	ON (DEE :	[ADI E 1705 4 OF IDC 2	0021)	
B. PRETENSIONED AND SLIP-CRITICAL JOINTS USING TURN-OF-NUT WITH MATCHMARKING, TWIST-OFF BOLT OR DIRECT TENSION INDICATOR METHODS OF INSTALLATION.	-	Х	AISC 360, SECTION M2.5	1705.3.3	H	VERIFICATION AND INSPECTION VERIFICATION AND INSPECTION		1	REFERENCED STANDARD	<u> </u>	
c. PRETENSIONED AND SLIP-CRITICAL JOINTS USING TURN-OF-NUT WITHOUT MATCHMARKING OR CALIBRATED WRENCH METHODS OF INSTALLATION.	x	-			1.	INSPECT PLACEMENT OF REINFORCING STEEL, INCLUDING PRESTRESSING TENDONS PRIOR TO THE CLOSING OF THE FORMS AND ARRIVAL OF CONCRETE ONSITE.	1 11 15	х	ACI 318: 3.5, 7.1-7.7	1910.4	
D. VERIFY CORRECT MATERIAL USED FOR HIGH-STRENGTH BOLTS, NUTS AND WASHERS		х	27		2.	INSPECTION OF REINFORCING STEEL WELDING IN ACCORDANCE WITH TABLE 1704.3, ITEM 5b.	х	-	AWS D1.4	-	
3. MATERIAL VERIFICATION OF STRUCTURAL STEEL AND COLD-FORMED STEEL DECK:					a)	VERIFY CORRECT MATERIALS USED INCLUDING THE USE OF A706 IN		х	ACI 318: 3.5.2		
A. FOR STRUCTURAL STEEL, IDENTIFICATION MARKINGS TO CONFORM TO AISC 360.	-	х	AISC 360 SECT. M5.5			WELDED SPLICES, IF ANY INSPECT BOLTS AND RODS TO BE INSTALLED IN CONCRETE PRIOR TO			ACI 318:		
B. FOR OTHER STEEL, IDENTIFICATION MARKINGS TO CONFORM TO ASTM STANDARDS SPECIFIED IN THE APPROVED CONSTRUCTION DOCUMENTS.	12	Х	APPLICABLE ASTM STANDARDS		3.	AND DURING PLACEMENT OF CONCRETE	X	-	8.1.3, 21.2.8 ACI 318:	1908.5, 1909.	
C. MANUFACTURER'S CERTIFIED TEST REPORTS.	-	Х			4.	INSPECTION OF ANCHORS INSTALLED IN HARDENED CONCRETE.		X	3.8.6, 8.1.3, 21.2.8	1909.1	
4. MATERIAL VERIFICATION OF WELD FILLER MATERIALS:					5.	VERIFYING USE OF REQUIRED DESIGN MIX.	×	-	ACI 318: CH. 4, 5.2-5.4	1904.2.2, 1910.2, 1910.3	
A. IDENTIFICATION MARKINGS TO CONFORM TO AWS SPECIFICATION IN THE APPROVED CONSTRUCTION DOCUMENTS.	-	X	AISC 360, SECTION A3.5 AND APPLICABLE AWS A5 DOCUMENTS		6.	AT TIME FRESH CONCRETE IS SAMPLED TO FABRICATE SPECIMENS FOR STRENGTH TESTS, PERFORM SLUMP AND AIR CONTENT TESTS AND DETERMINE THE TEMPERATURE OF THE CONCRETE.	х	-	ASTM C 172 ASTM C 31 ACI 318: 5.6, 5.8	1910.10	
B. MANUFACTURER'S CERTIFICATE OF COMPLIANCE REQUIRED.	-	Х	-		7.	INSPECTION OF CONCRETE AND SHOTCRETE PLACEMENT FOR PROPER APPLICATION TECHNIQUES.	x	2-,	ACI 318: 5.9, 5.10	1910.6, 1910.7, 1910.8	
C. VERIFY CORRECT FILLER MATERIAL USED IN WELDS		Х			8.	INSPECTION FOR MAINTENANCE OF SPECIFIED CURING TEMPERATURE		x	ACI 318: 5.11-5.13	1910.9	
5. INSPECTION OF WELDING:			T	1	-	AND TECHNIQUES.				-	
A. STRUCTURAL STEEL AND COLD-FORMED STEEL DECK:					9.	ERECTION OF PRECAST CONCRETE MEMBERS.		Х	ACI 318: CH. 16		
1) ULTRASONIC OR MAGNETIC PARTICLE TESTING ON ALL FULL PENETRATION WELDS	х	-			10	VERIFICATION OF IN-SITU CONCRETE STRENGTH, PRIOR TO STRESSING		X	ACI 318: 6.2	-	
2) PARTIAL JOINT PENETRATION GROOVE WELDS	X				10.	OF TENDONS IN POST TENSIONED CONCRETE AND PRIOR TO REMOVAL OF SHORES AND FORMS FROM BEAMS AND STRUCTURAL SLABS.		^	ACI 516. 6.2		
a) PERFORM LIQUID DYE PENETRATION TESTING ON 20% OF PARTIAL PENETRATION GROOVE WELDS		Х			11.	INSPECT FORMWORK FOR SHAPE, LOCATION AND DIMENSIONS OF THE CONCRETE MEMBER BEING FORMED.	-	x	ACI 318: 6.1.1	-	
3) MULTIPASS FILLET WELDS.	х	-	- AWS D1 1	AWS D1.1	1705.3.1		REQUIRED VERIFICATION AND INSPECTION	OF SOILS (REI	F TABLE 1	705.7 OF IBC 2021)	
a) PERFORM LIQUID DYE PENETRATION TESTING ON 20% OF MULTIPASS FILLET WELDS		X	1,110			VERIFICATION AND INSPECTION	CONTINUOUS	PERIODIC	REFERENCED STANDARD	IBC REFERENC	
4) SINGLE-PASS FILLET WELDS > 5/16"	х	TeV I			1.	VERIFY MATERIALS BELOW SHALLOW FOOTINGS ARE ADEQUATE TO	-	x	-		
5) PLUG AND SLOT WELDS.	х	1 -4			<u> </u>	ACHIEVE THE DESIGN BEARING CAPACITY. VERIFY EXCAVATIONS ARE EXTENDED TO PROPER DEPTH AND HAVE		X		1	
6) SINGLE-PASS FILLET WELDS < = 5/16"		Х			<u> </u> -	REACHED PROPER MATERIAL.	27	^	-		
7) FLOOR AND ROOF DECK WELDS.	-	Х	AWS D1.3		3.	PERFORM CLASSIFICATIONS AND TESTING OF CONTROLLED FILL MATERIA		X	•	1705.7	
B. REINFORCING STEEL: VERIFICATION OF WELDABILITY OF REINFORCING STEEL					4.	VERIFY USE OF PROPER MATERIALS, DENSITIES AND LIFT THICKNESSES DURING PLACEMENT OF COMPACTION OF CONTROLLED FILL.	×	-	-		
') OTHER THAN ASTM A 706.	X		AWS D1.4 ACI		5.	PRIOR TO PLACEMENT OF CONTROLLED FILL, OBSERVE SUBGRADE AND VERIFY THAT SITE HAS BEEN PREPARED PROPERLY.	1 64	х			
2) SHEAR REINFORCEMENT. 3) OTHER REINFORCING STEEL	X	- X	318; 3.5.2								
C. VISUALLY INSPECT ALL WELDS	-	X				REQUIRED VERIFICATION AND INSPECTION	OF SPRAY FIRE	E PROTECT	TON MATERIAL		
D. VERIFY JOINT WELD PROCEDURES IN ACCORDANCE WITH AWS		X	AWS D1.1			VERIFICATION AND INSPECTION	CONTINUOUS DUR	ING TASK L	STED PERIODICALLY DURIN	IG TASK LISTED	
E. VERIFY CONTRACTOR'S RECEIPT OF WELDER CERTIFICATES		Х			1.	INSPECT SURFACE PREPARATION OF MEMBERS		<			
6. INSPECTION OF STEEL FRAME JOINT DETAILS FOR COMPLIANCE:					2.	INSPECT APPLICATION CONDITIONS AND APPLIED THICKNESS)	·	-		
A. DETAILS SUCH AS BRACING AND STIFFENING.	-	Х			7	TEST DENSITY AND BONDING STRENGTH & THICKNESS AT 10% OF			Y		
B. MEMBER LOCATIONS.	-	Х	-	1705.3.2	-	ALL BEAMS, COLUMNS & BRACES			^	X	
C. APPLICATION OF JOINT DETAILS AT EACH LOCATION.		X	N. THE DREWGES OF A EARL	NOATOR'S	┺						
7. WHERE FABRICATION OF STRUCTURAL LOAD-BEARING MEMBERS AND ASSEMBLIES SHOP, SPECIAL INSPECTION OF THE FABRICATED ITEMS SHALL CONFORM TO THE AS SUMMARIZED ABOVE, UNLESS THE FABRICATOR HAS BEEN APPROVED IN ACC	SPECIAL INSPEC	CTION REI	QUIREMENTS OF IBC SECTION			REQUIRED VERIFICATION AND DEEP FOUNDATION ELEMENTS (
8. OBSERVE AND TEST FIELD APPLIED HEADED STUDS		Х				VERIFICATION AND INSPECTION	CONTINUOUS DUR	ING TASK LI	STED PERIODICALLY DURIN	NG TASK LISTED	
9. VERIFY FABRICATOR CERTIFICATION		Х			1.	OBSERVE DRILLING OPERATIONS AND MAINTAIN COMPLETE AND ACCURATE RECORDS FOR EACH ELEMENT.)	<	-		
					2.	VERIFY PLACEMENT LOCATIONS AND PLUMBNESS, CONFIRM ELEMENT DIAMETERS, BELL DIAMETERS (IF APPLICABLE), LENGTHS, EMBEDMENT INTO BEDROCK (IF APPLICABLE) AND ADEQUATE END-BEARINGS STRATA CAPACITY. RECORD CONCRETE OR GROUT VOLUMES.	>	<	32		

ARCHITECT:



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CONSULTANT:

MASONRY CONSTRUCTION (REF TABLE 1.18.3 ACI 530)

VERIFICATION AND INSPECTION

COMPLIANCE OF TYPE SIZE, AND LOCATION OF ANCHORS INCLUDING OTHER DETAILS OF ANCHORAGE OF MASONRY TO

STRUCTURAL MEMBERS, FRAMES, OR OTHER CONSTRUCTION.

(TEMPERATURE BELOW 40 DEGREES F.) OR HOT WEATHER

GRADE AND SIZE OF REINFORCEMENT AND ANCHOR BOLTS,

PLACEMENT OF MASONRY UNITS AND CONSTRUCTION OF

PLACEMENT OF GROUT AND PRE-STRESSING GROUT FOR

PLACEMENT OF REINFORCEMENT, CONNECTORS, AND

PRE-STRESSING TENDONS AND ANCHORS

OBSERVE PREPARATION OF GROUT SPECIMENS,

SUBMITTALS FOR MATERIALS USED IN MASONRY CONSTRUCTION INDICATING COMPLIANCE WITH THE

VERIFICATION OF F'M AND F'AAC IN ACCORDANCE WITH ARTICLE 1.4B PRIOR TO CONSTRUCTION FOR EVERY

| VERIFICATION OF PROPORTIONS OF MATERIALS IN PRE-MIXED

OR PRE-BLENDED MORTAR & GROUT, AS DELIVERED TO THE

MORTAR SPECIMENS, AND/OR PRISMS

8. GROUT SPACE PRIOR TO GROUTING

PROPORTIONS OF SITE MIXED MORTAR & GROUT

ELEMENTS

MORTAR JOINTS

BONDED TENDONS

CONTRACT DOCUMENTS

5000 SF OF CONSTRUCTION

COMPLIANCE OF SIZE AND LOCATION OF STRUCTURAL

COMPLIANCE OF PREPARATION, CONSTRUCTION, AND PROTECTION OF MASONRY DURING COLD WEATHER

(TEMPERATURE ABOVE 90 DEGREE F.)

PRE-STRESSING TENDONS AND ANCHORAGES

CONTINUOUS PERIODIC

REFERENCED IBC STANDARD REFERENCE

ACI 530: 1.18 | 1705.4

ACI 530: 1.18 | 1705.4

ACI 530: 1.18 1705.4

ACI 530: 1.18 1705.4

ACI 530: 1.18 | 1705.4

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ACI 530: 1.18 1705.4

1705.4

ACI 530: 1.18



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Dallas Independent 2020 Bond I Mark Twain School for the

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KEY PLAN


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REQUIRED SPECIAL INSPECTIONS

Sheet Number

S-101



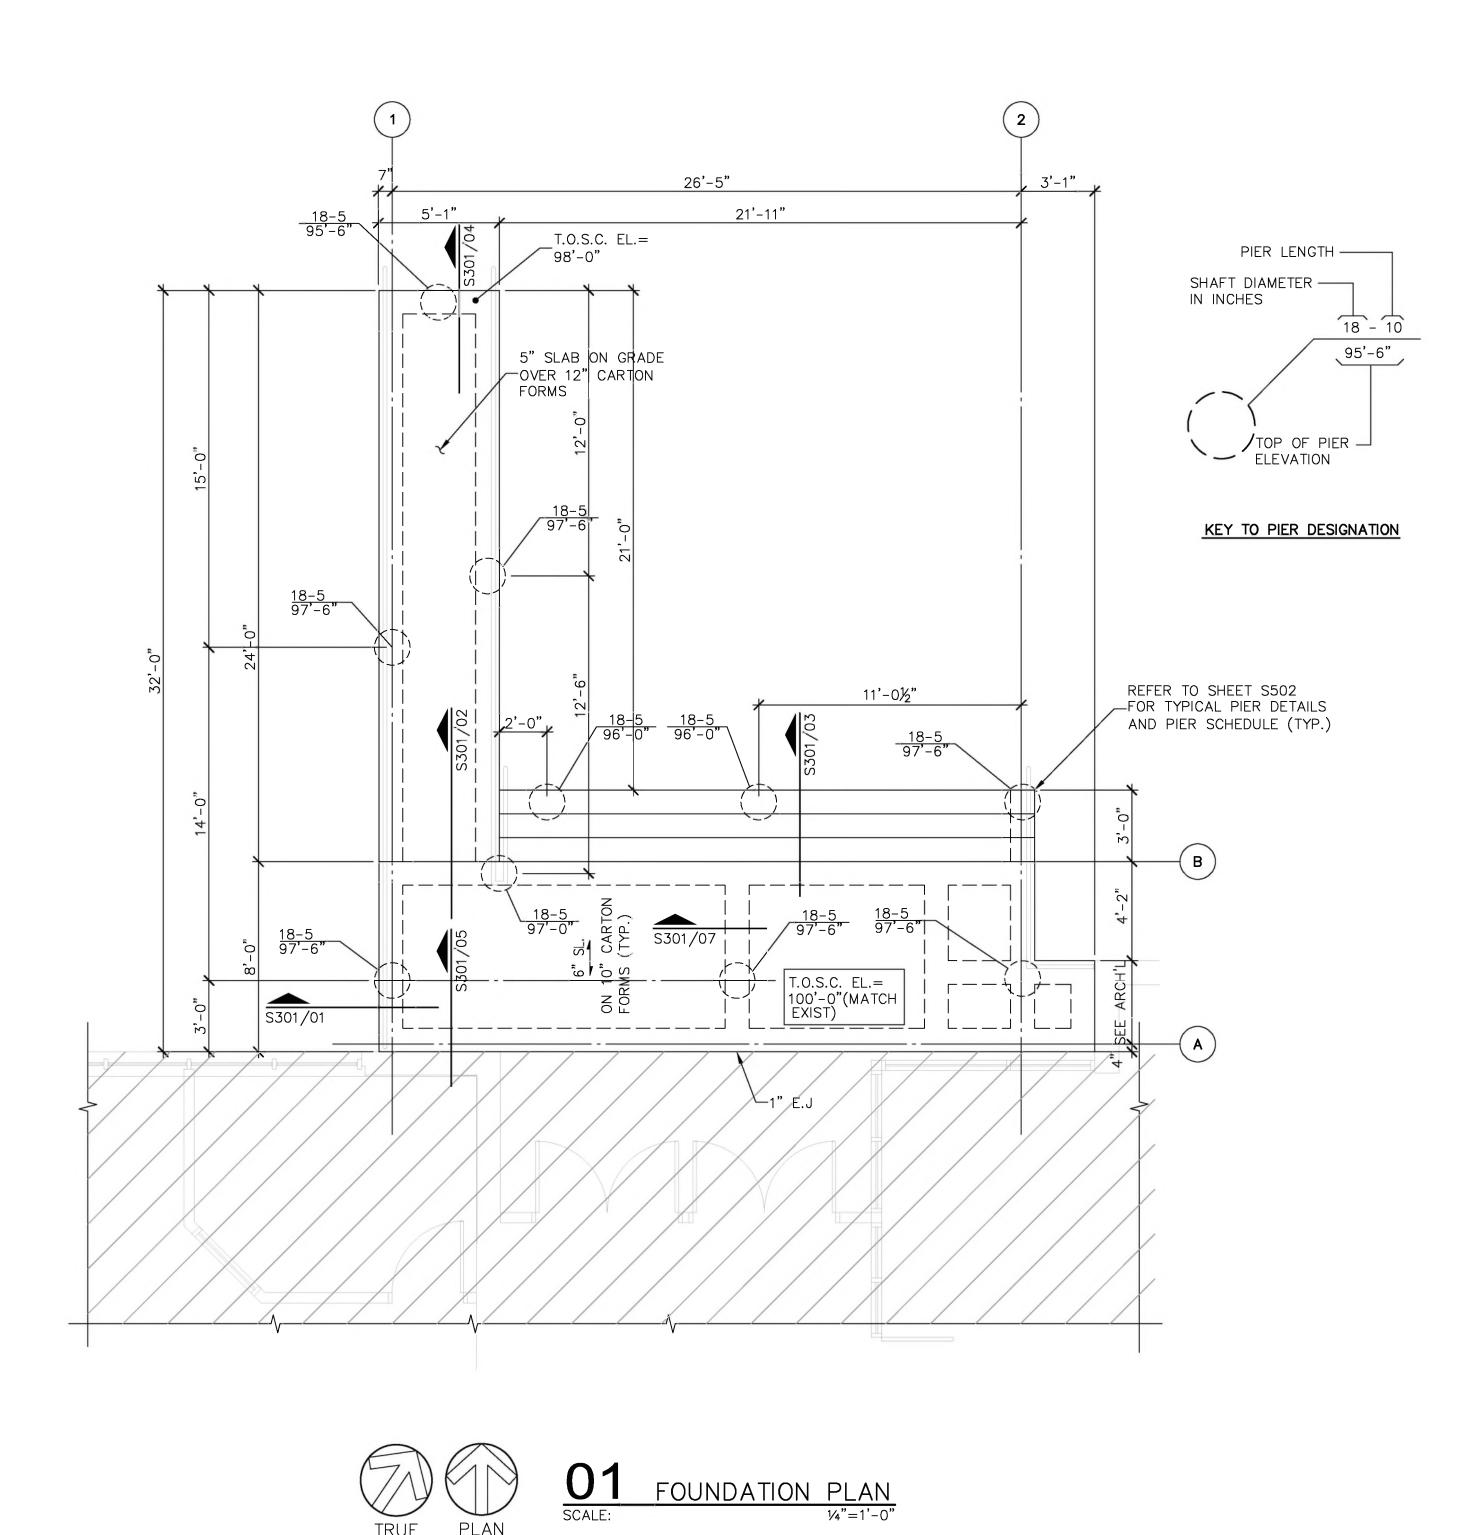

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NSTRUCTION DOCUMENTS

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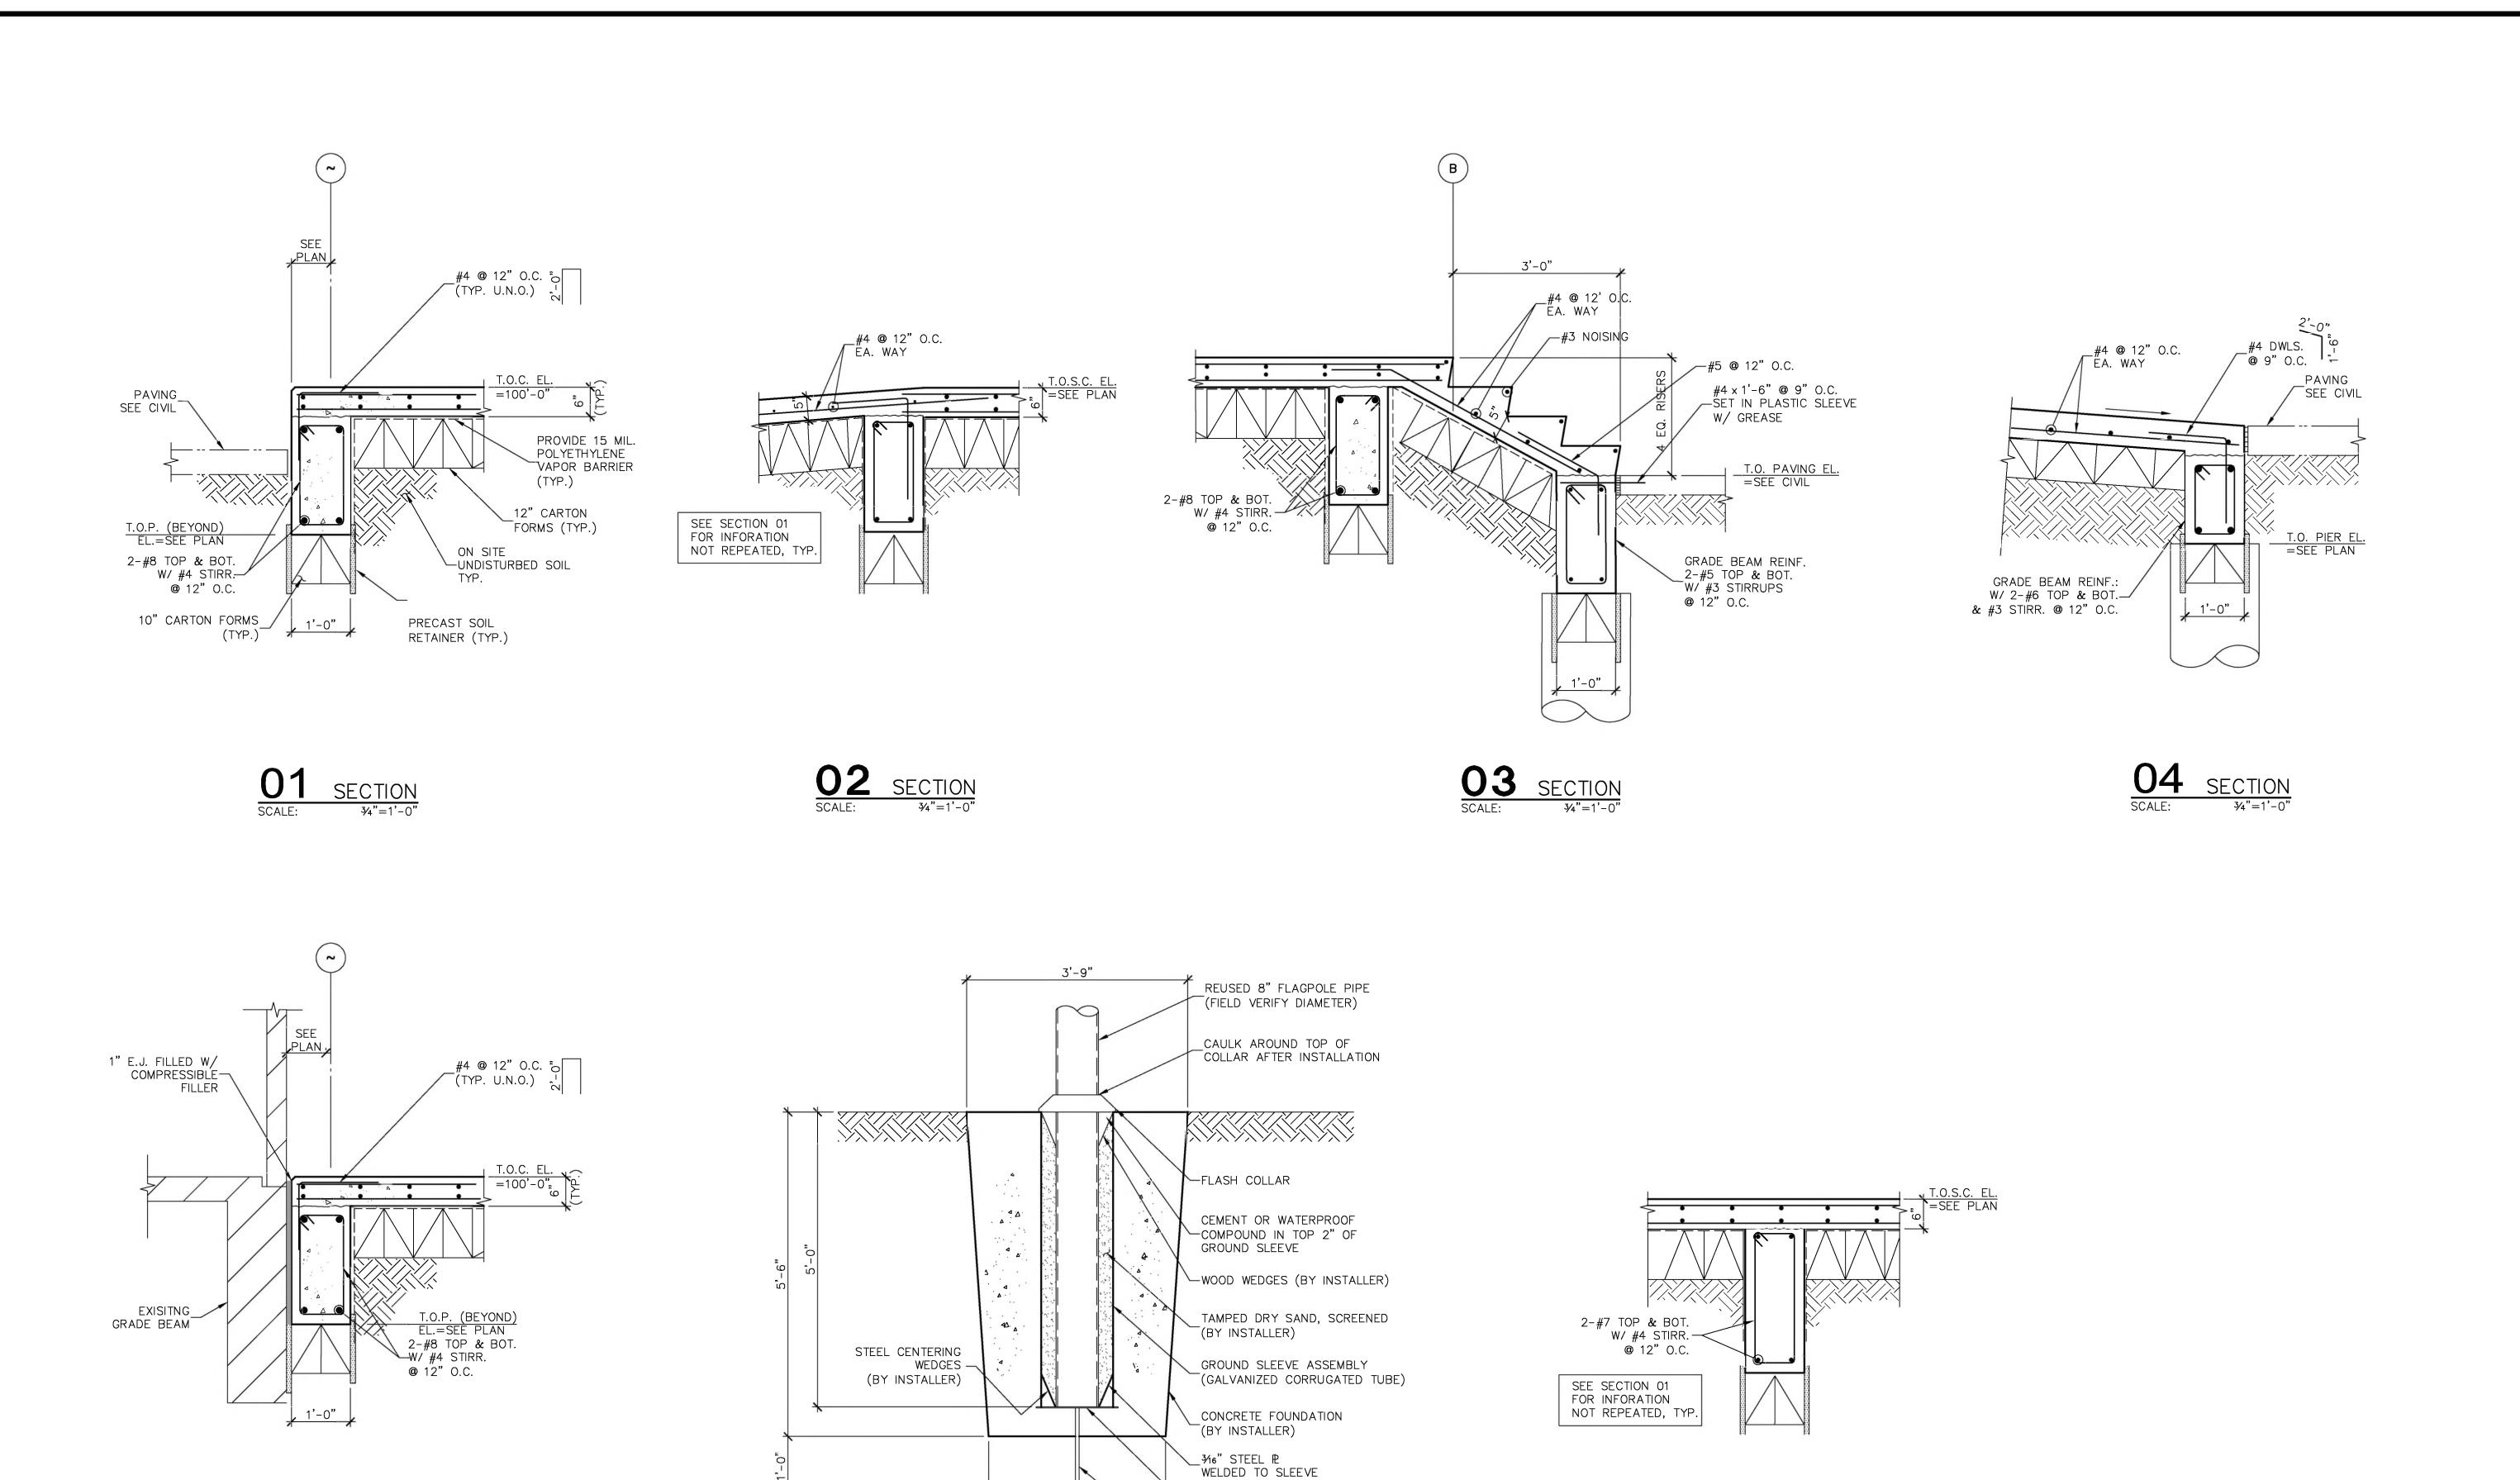
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FOUNDATION PLAN ROOF FRAMING PLAN

Sheet Number

S-201



__346" STEEL ₽ WELDED TO SPIKE

O7 SECTION SCALE: 3/4"=1'-0"

34" STEEL LIGHTNING SPIKE

6 FLAG POLE FOUNDATION SCALE: 34"=1'-0"

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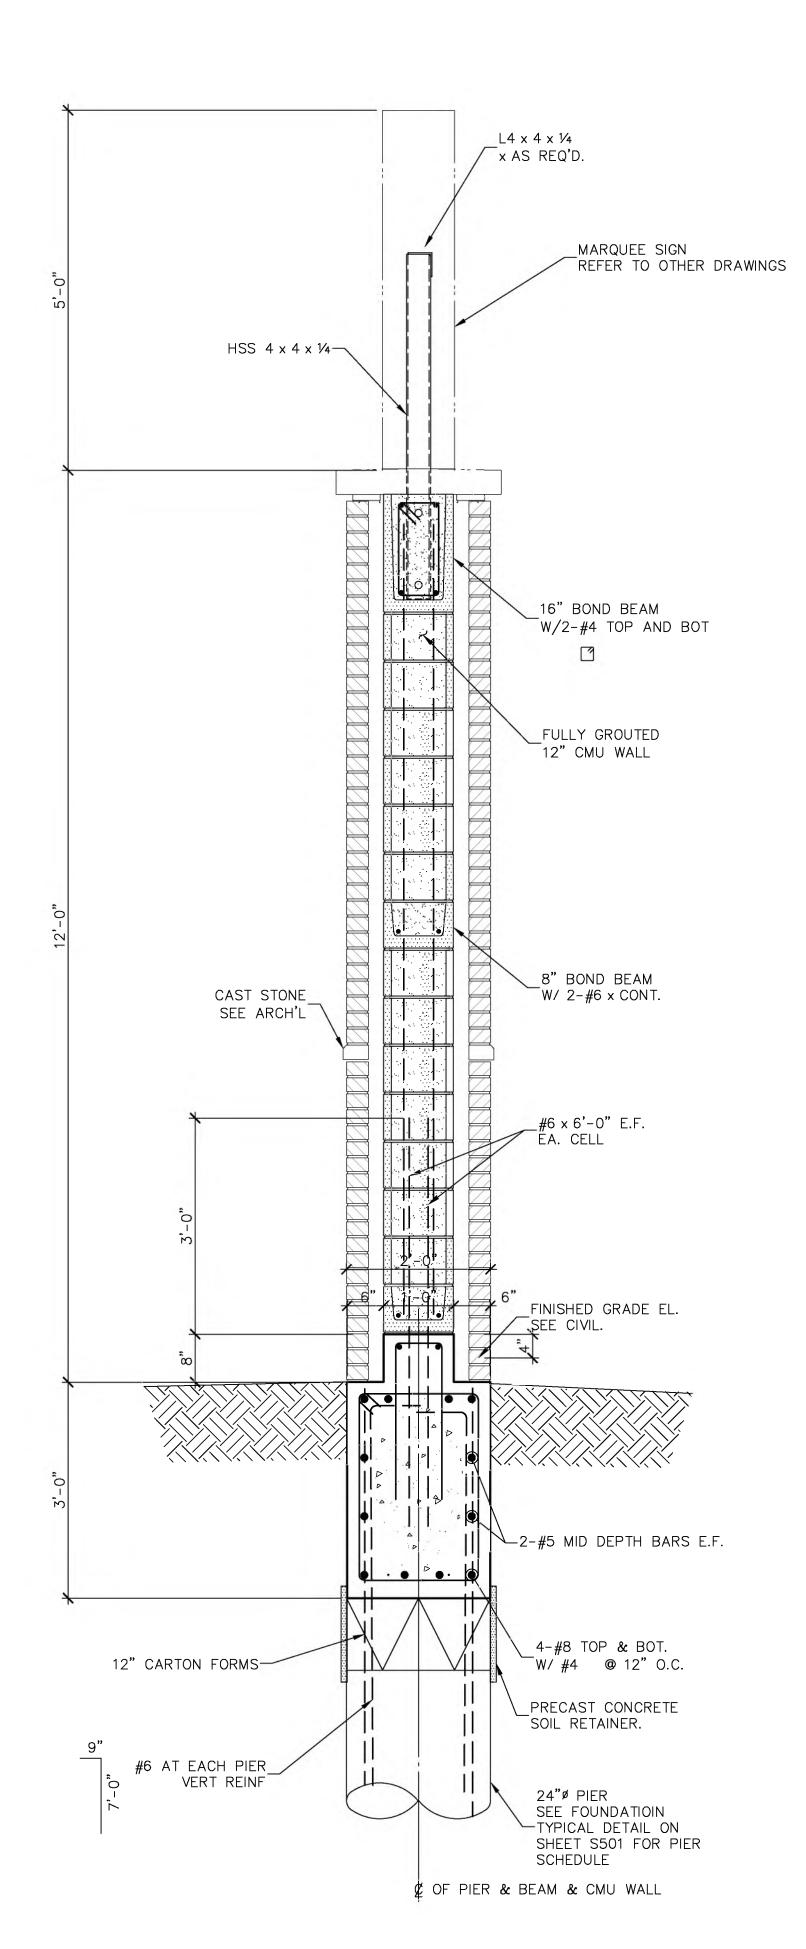
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Sheet Title **NEW MARQUEE SIGN SECTIONS AND DETAILS**


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S301

05 SECTION SCALE: 3/4"=1'-0"





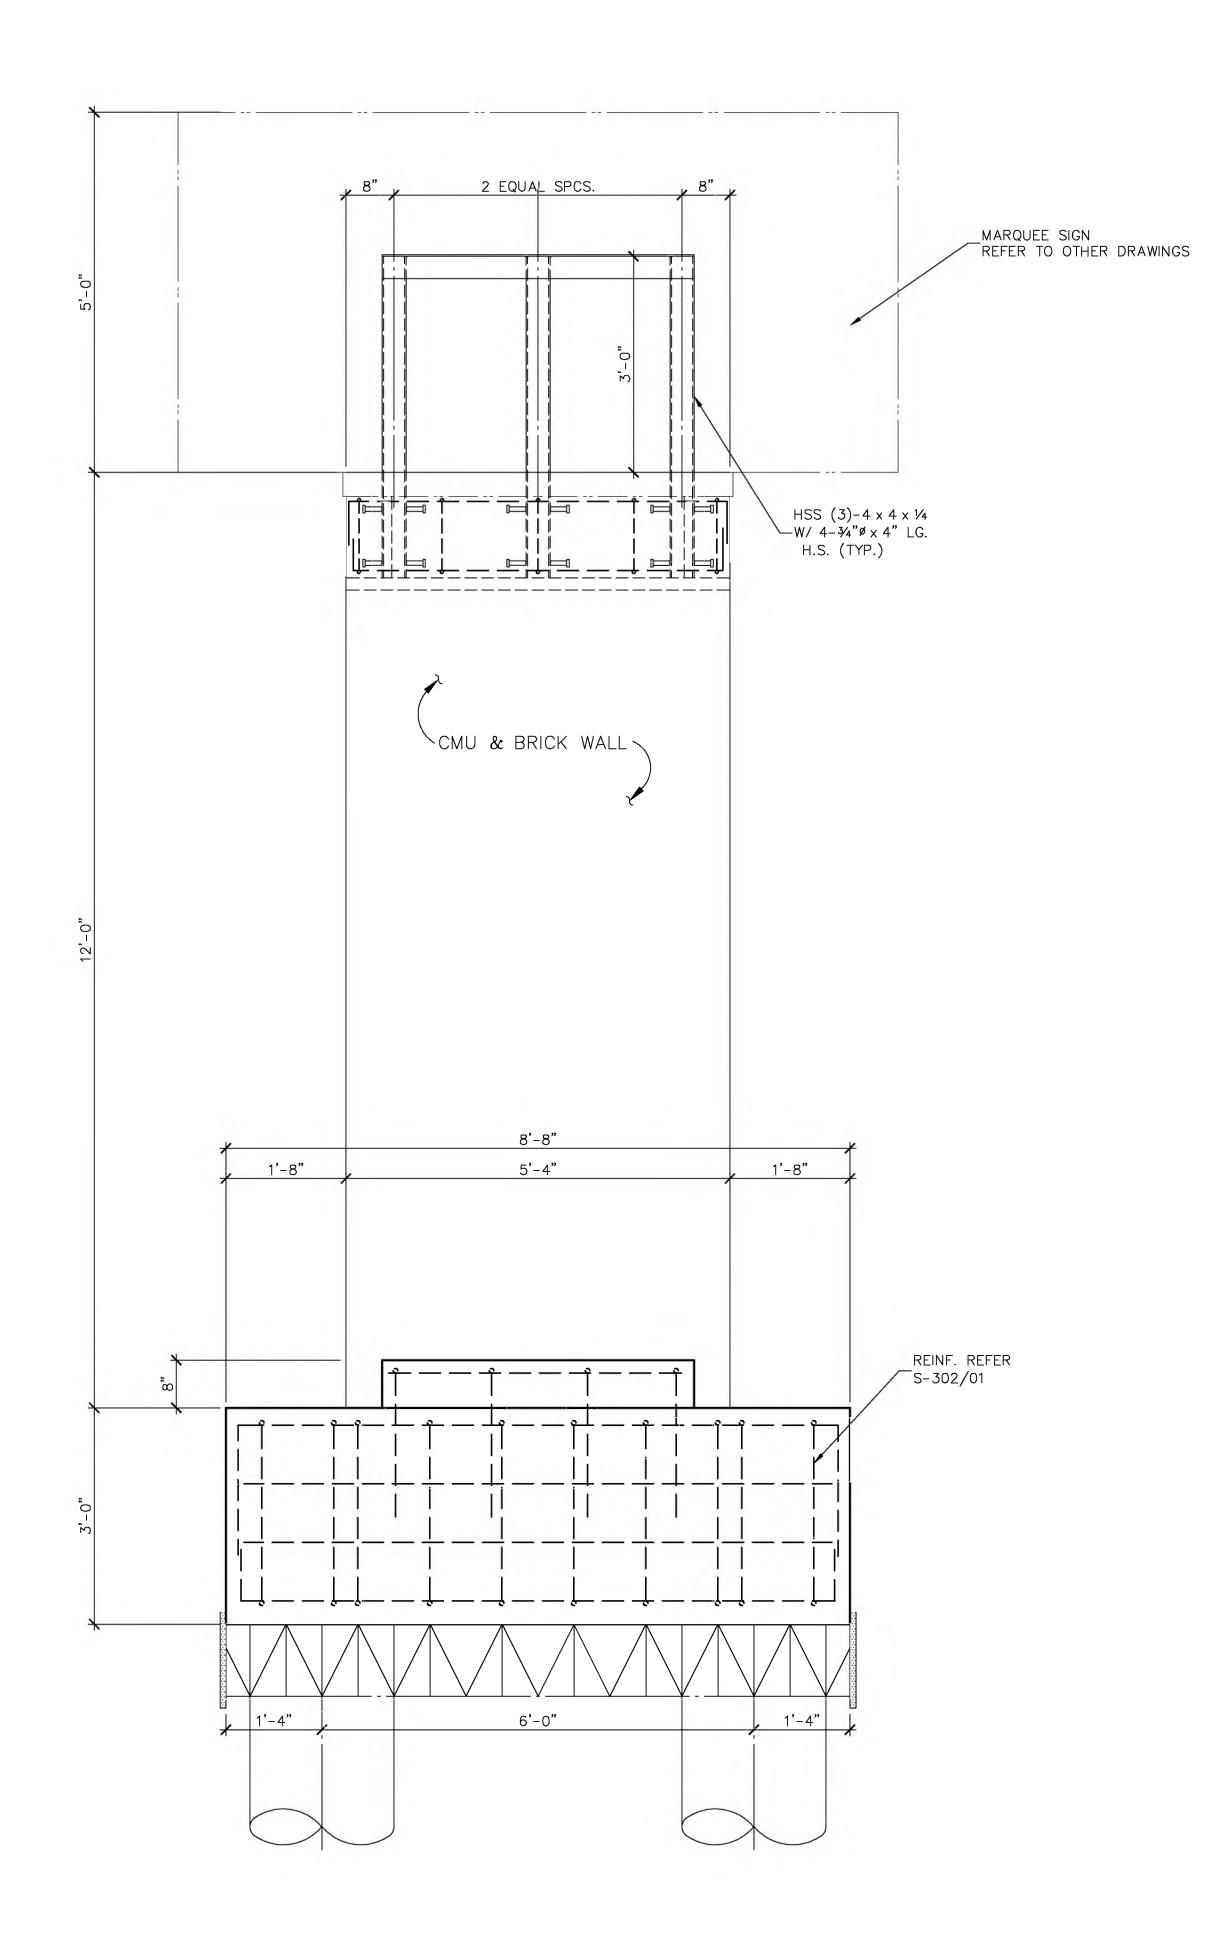

MARQUEE SIGN ELEVATION
SCALE: 3/4"=1'-0"



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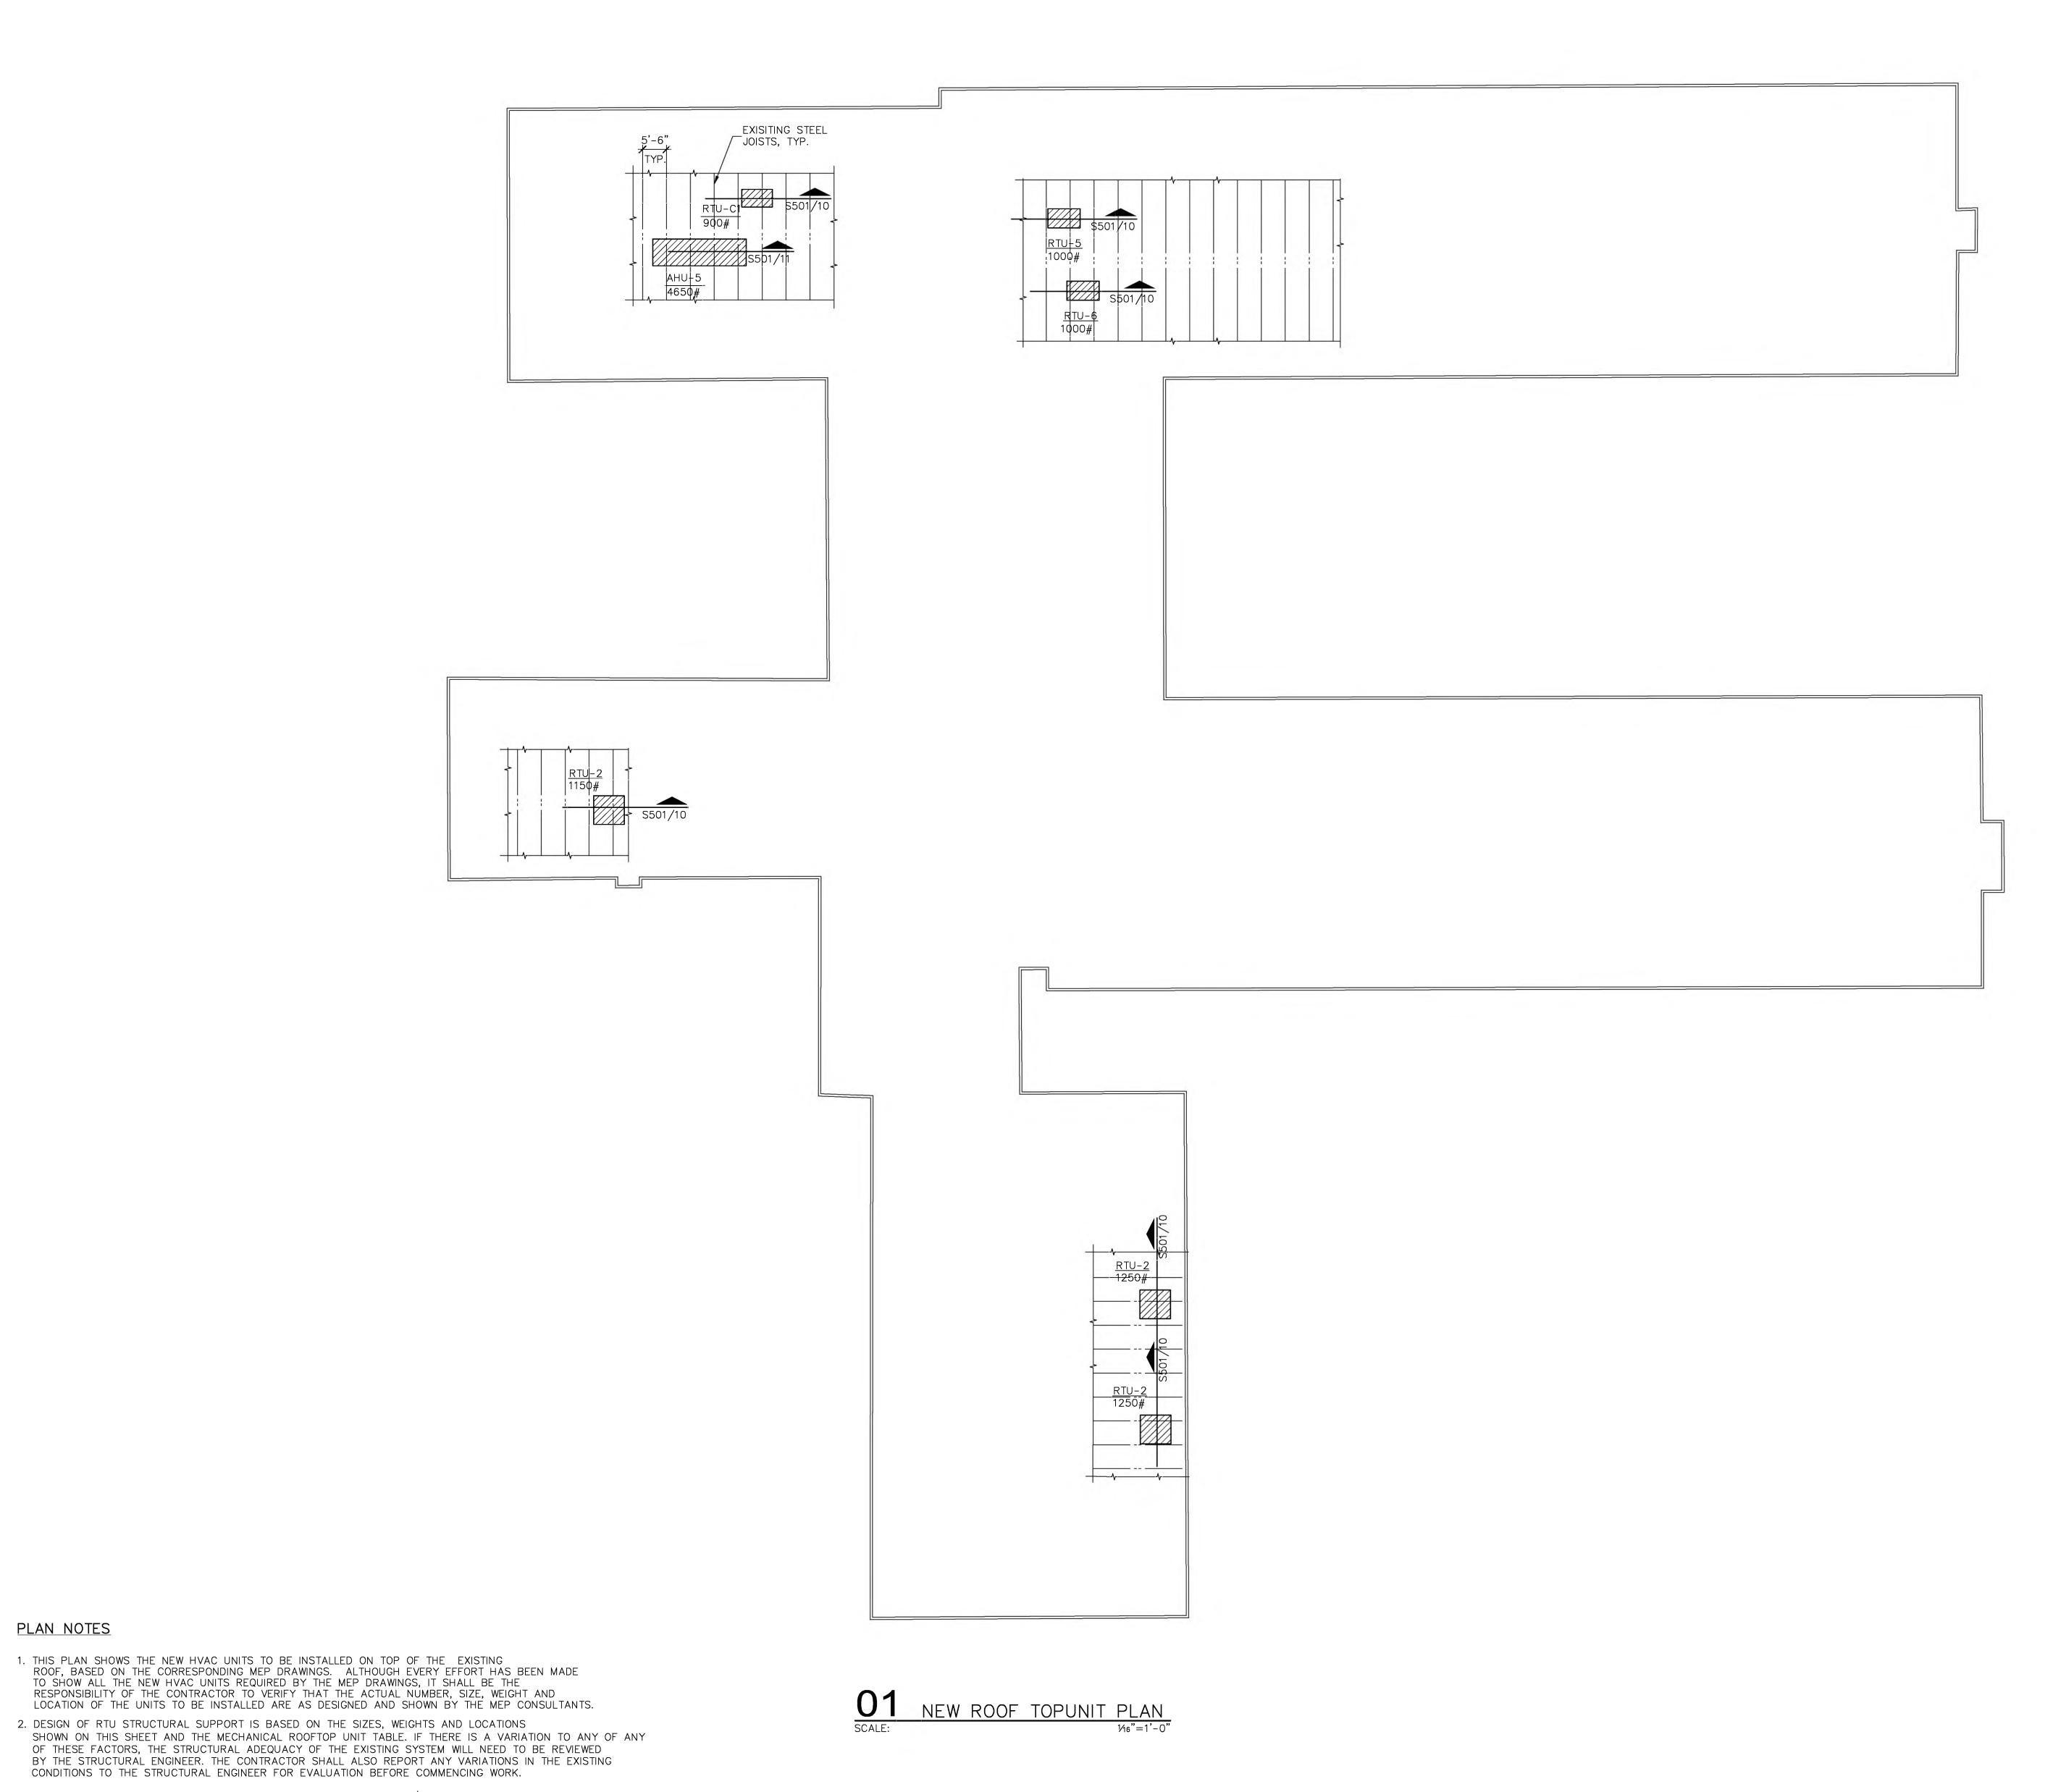
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Sheet Title

NEW MARQUEE SIGN
SECTIONS AND
DETAILS

Sheet Number

S-302





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Sheet Title

EXISTING ROOF AND NEW ROOF TOP UNITS

Sheet Number


S401

STRUCT\S41_HVACPLAN.DWG / 1/16=1'-0" / AUG 16, 2024 / 4:09

3. ROOF OPENINGS ARE TO OCCUR BETWEEN STEEL OR CONCRETE JOIST/BEAMS AT NO POINT IS A JOIST OR BEAM TO BE CUT TO ACCOMODATE OPENINGS.

4. RTU UNITS ARE TO BE DISTRIBUTED OVER AT LEAST THREE JOISTS. (AS SHOWN)

5. ALL RTU WEIGHTS SHOWN ARE TOTAL OPERATING WEIGHTS INCLUDING THE WEIGHTS OF ACCESSORIES AND CURBS.

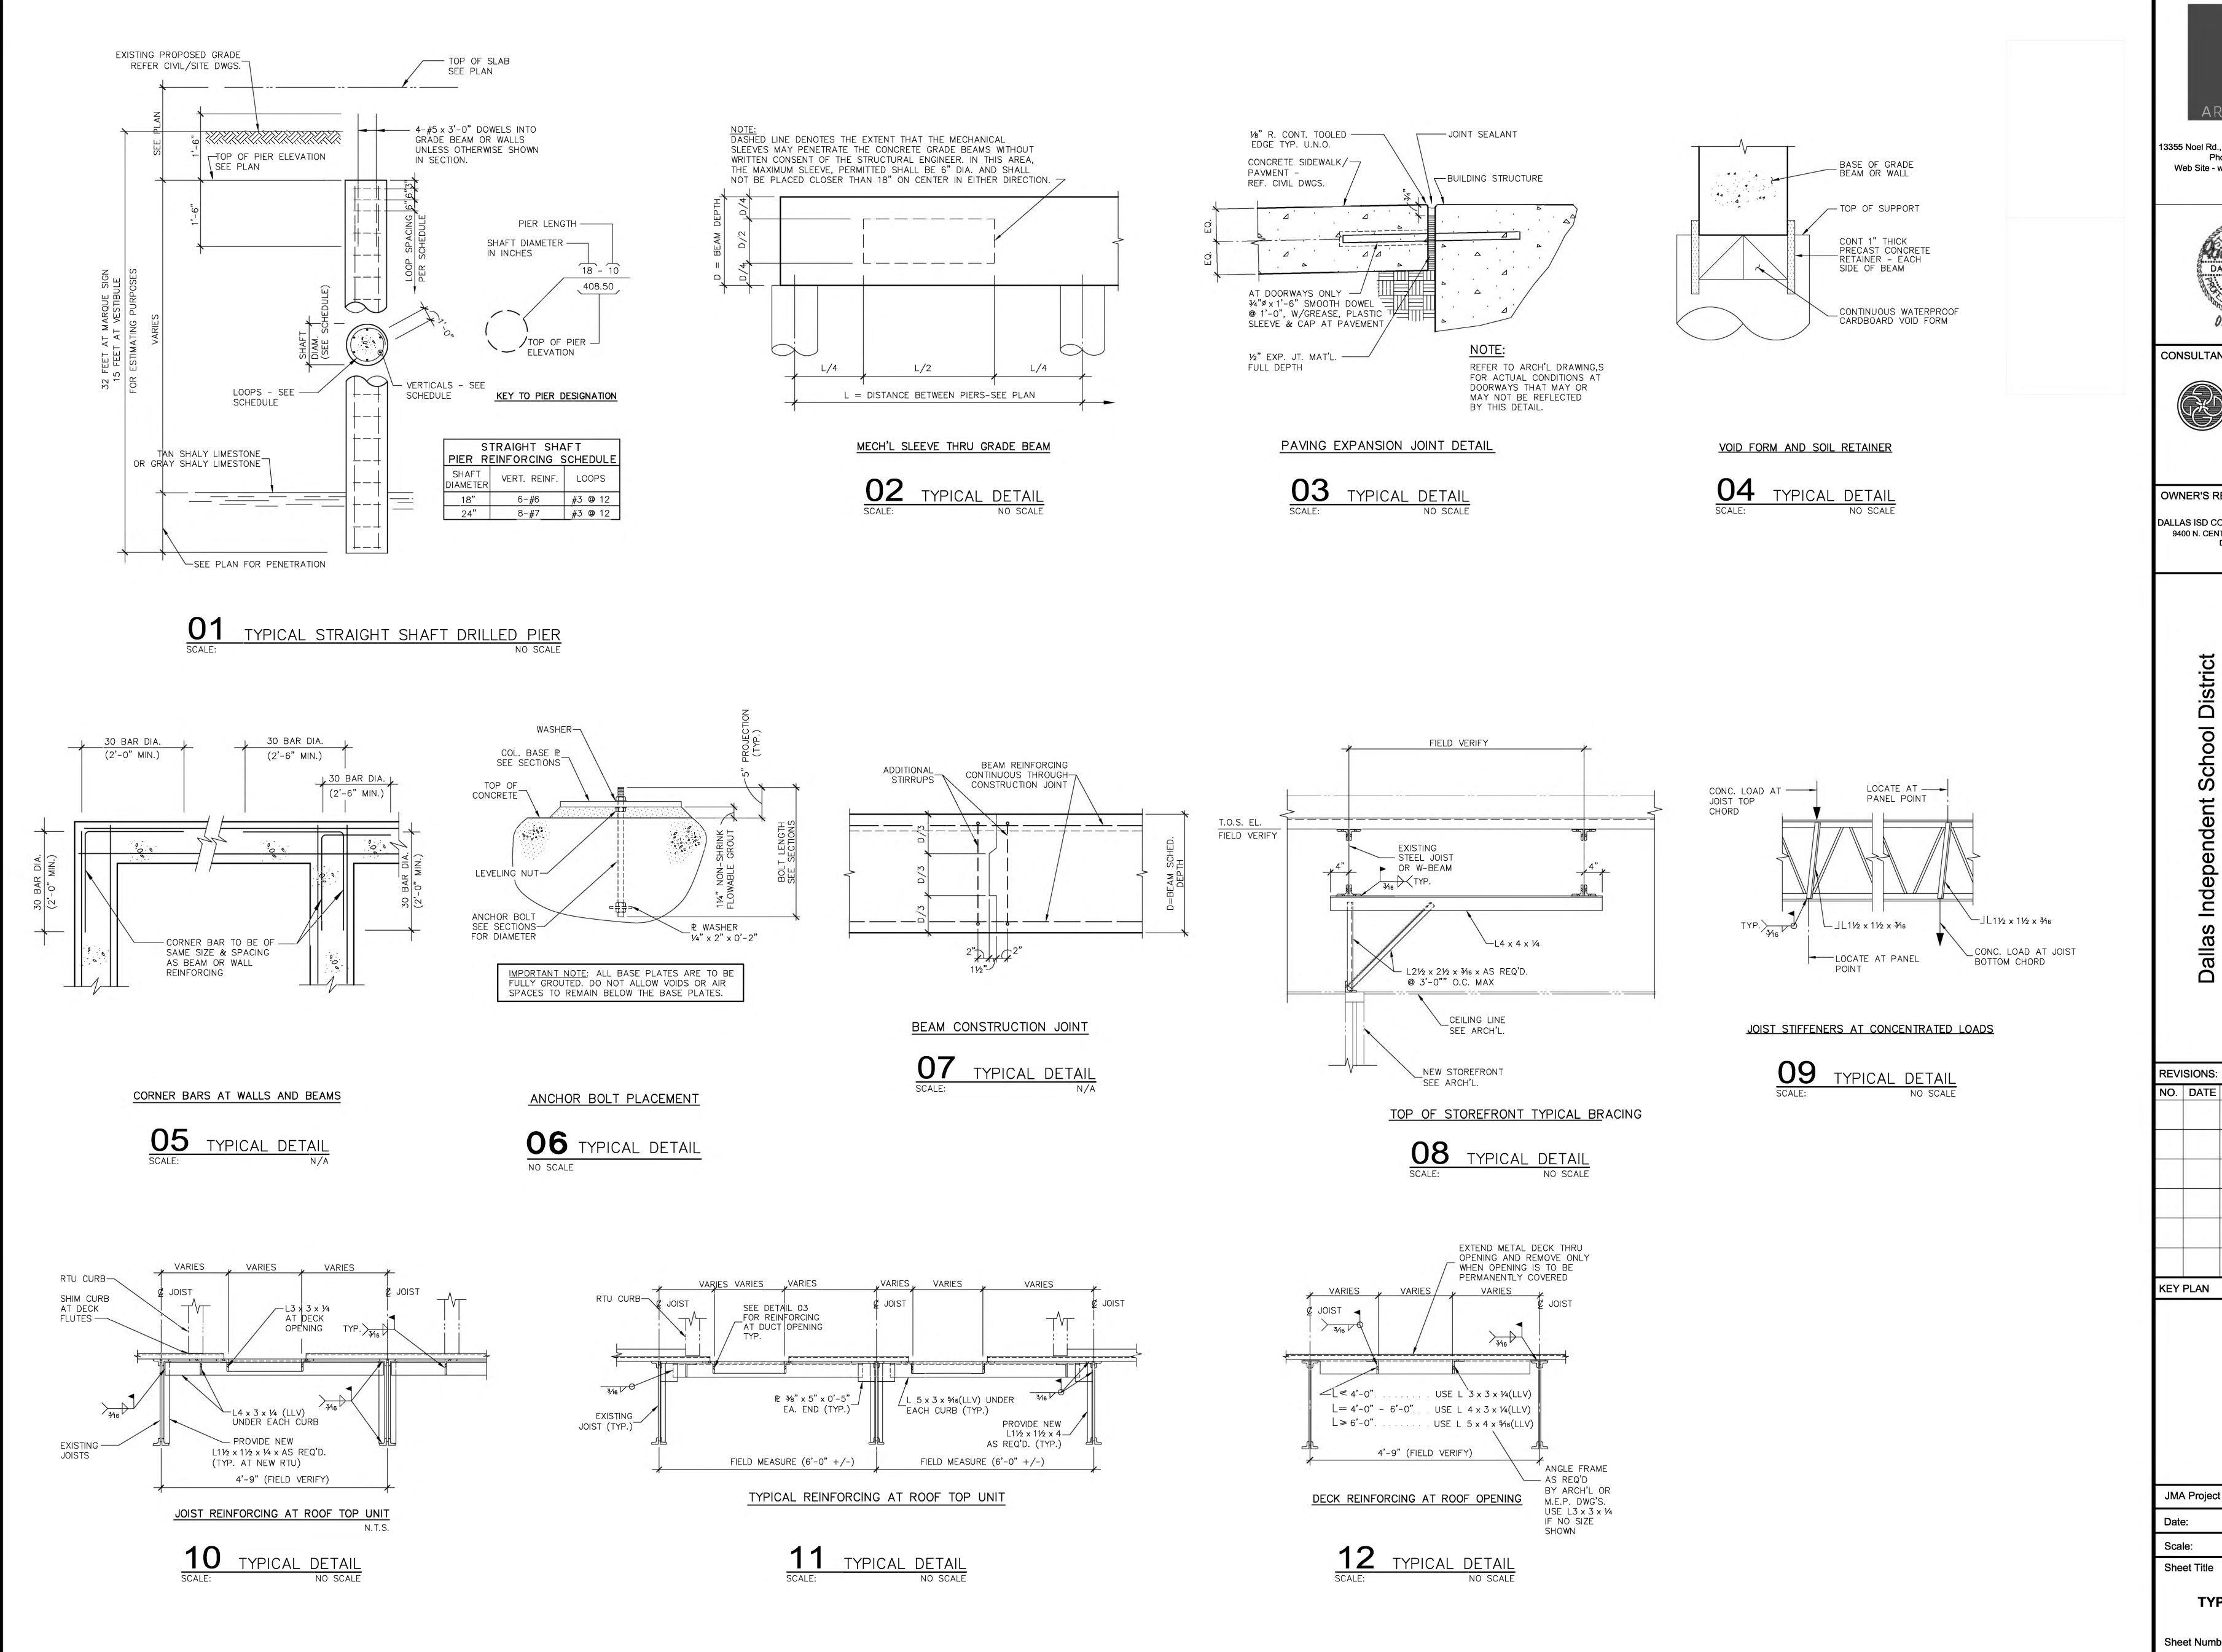

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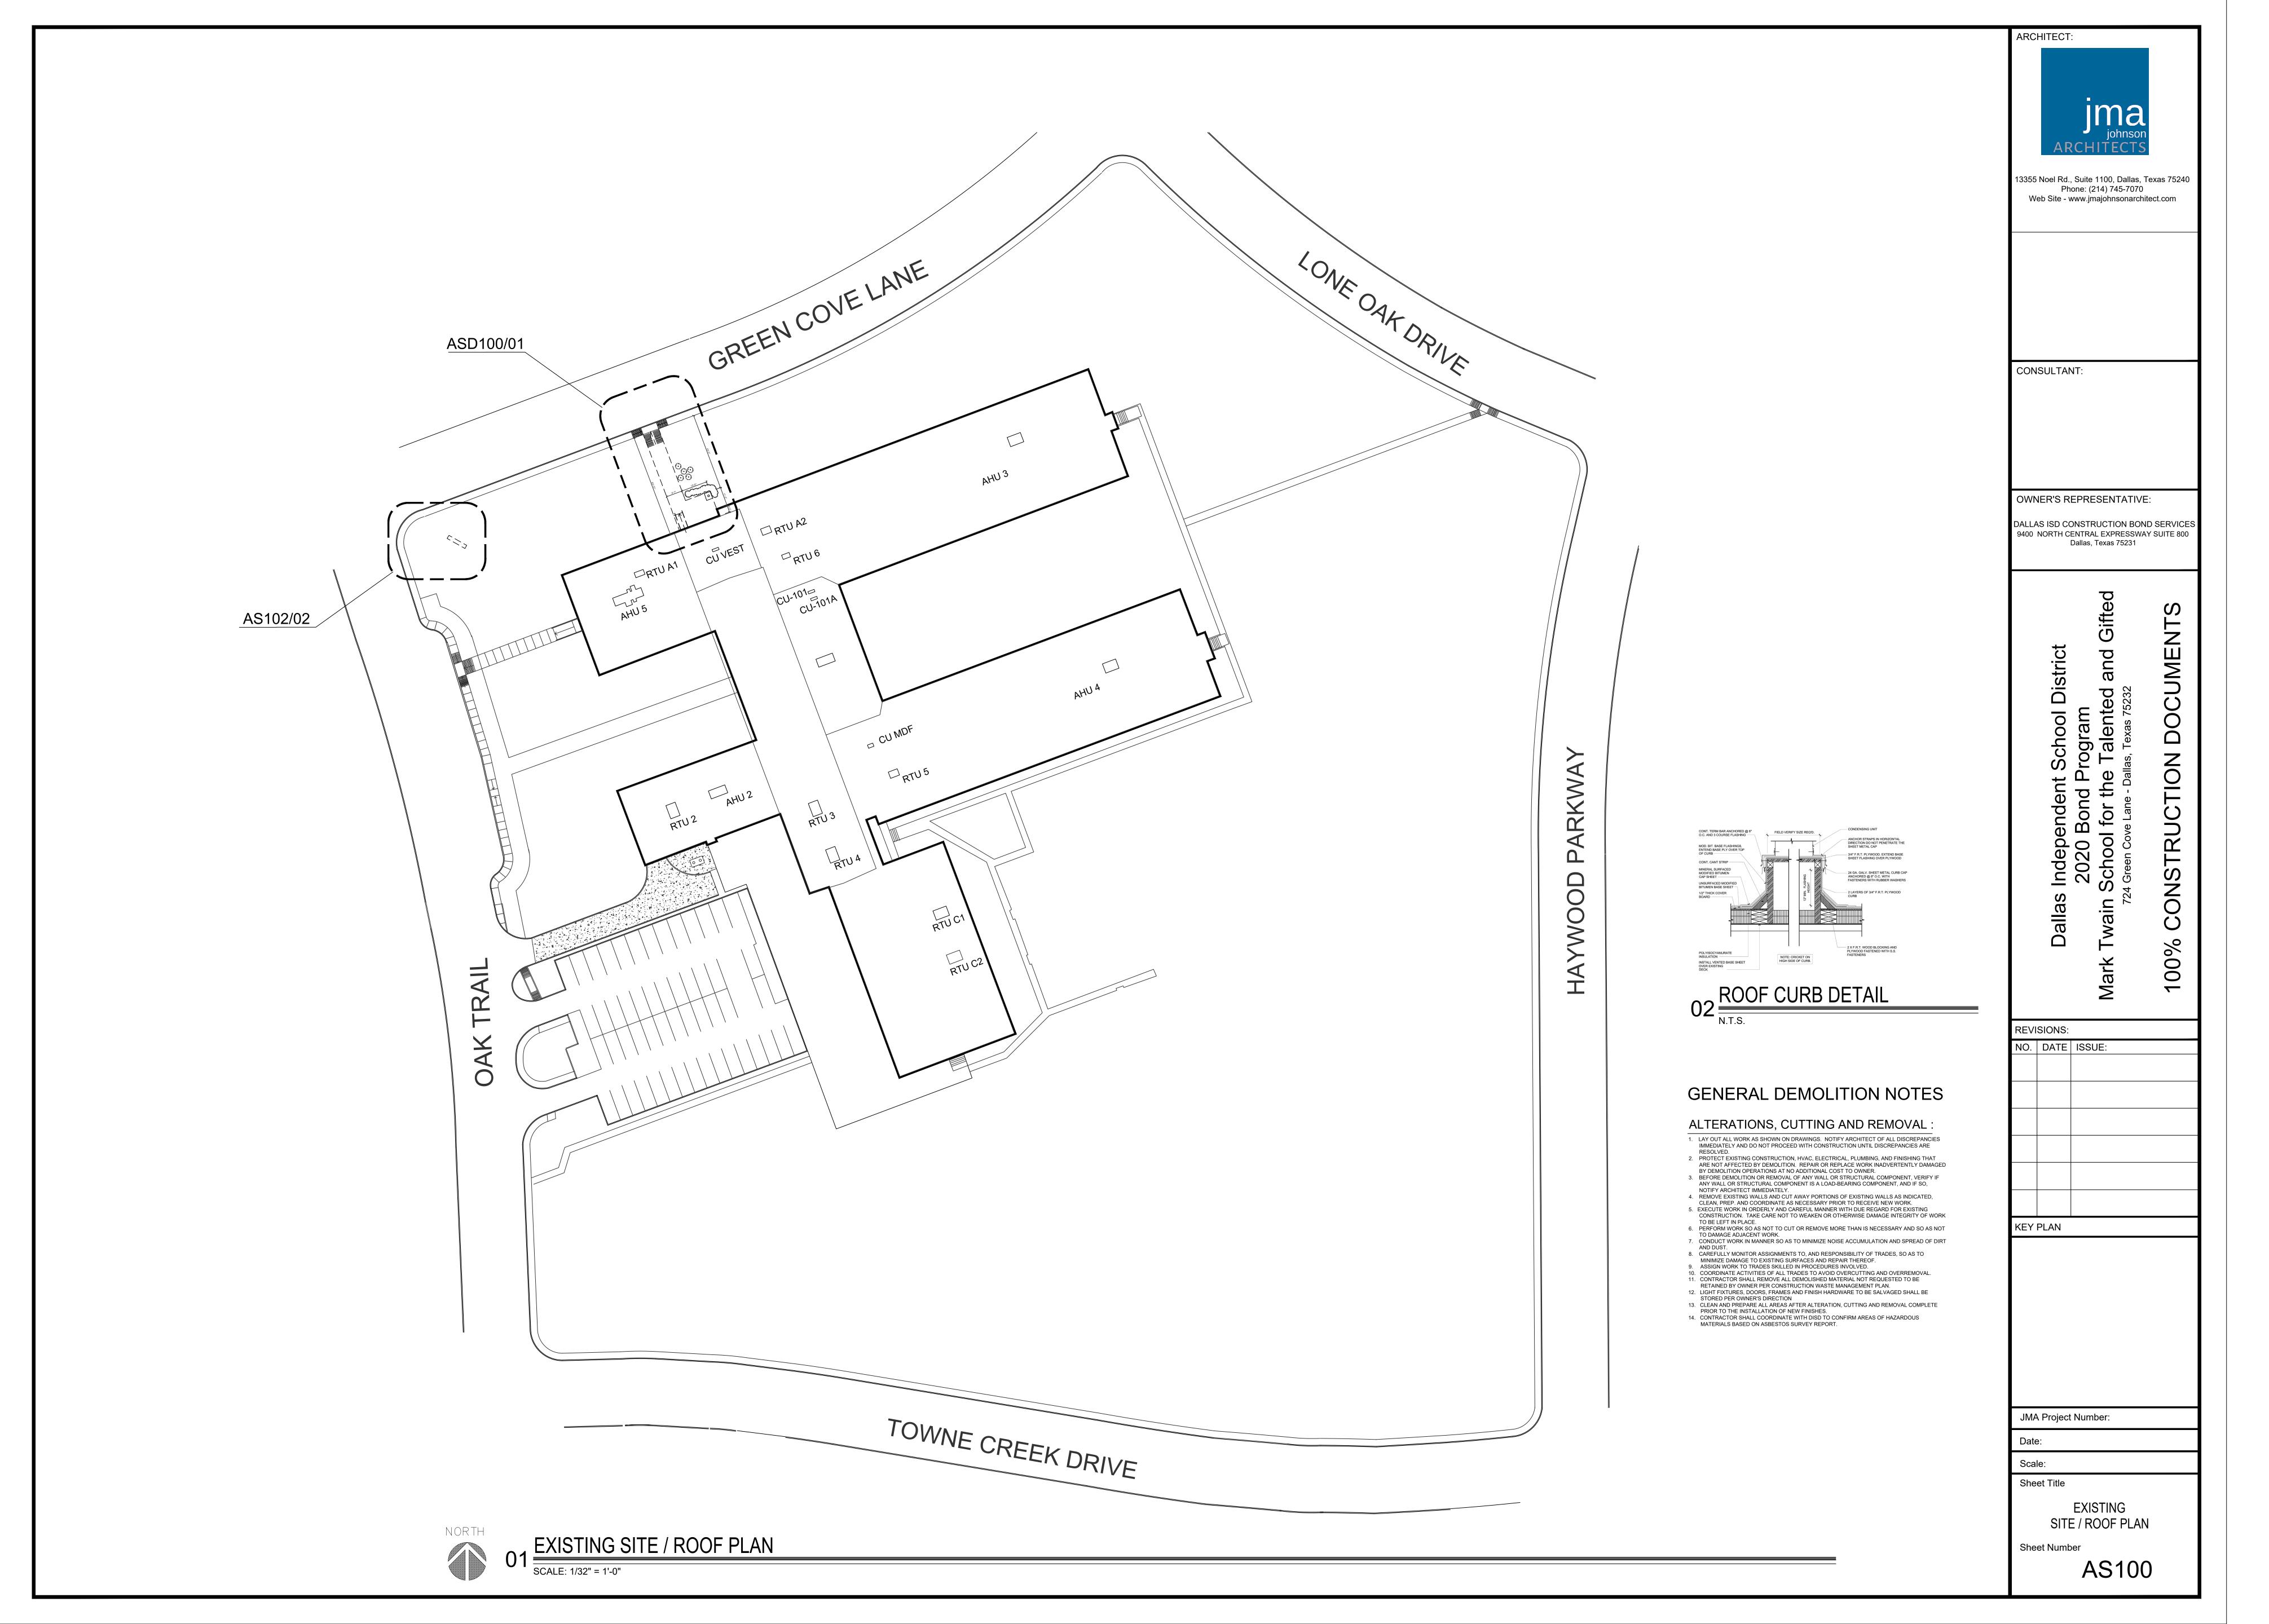
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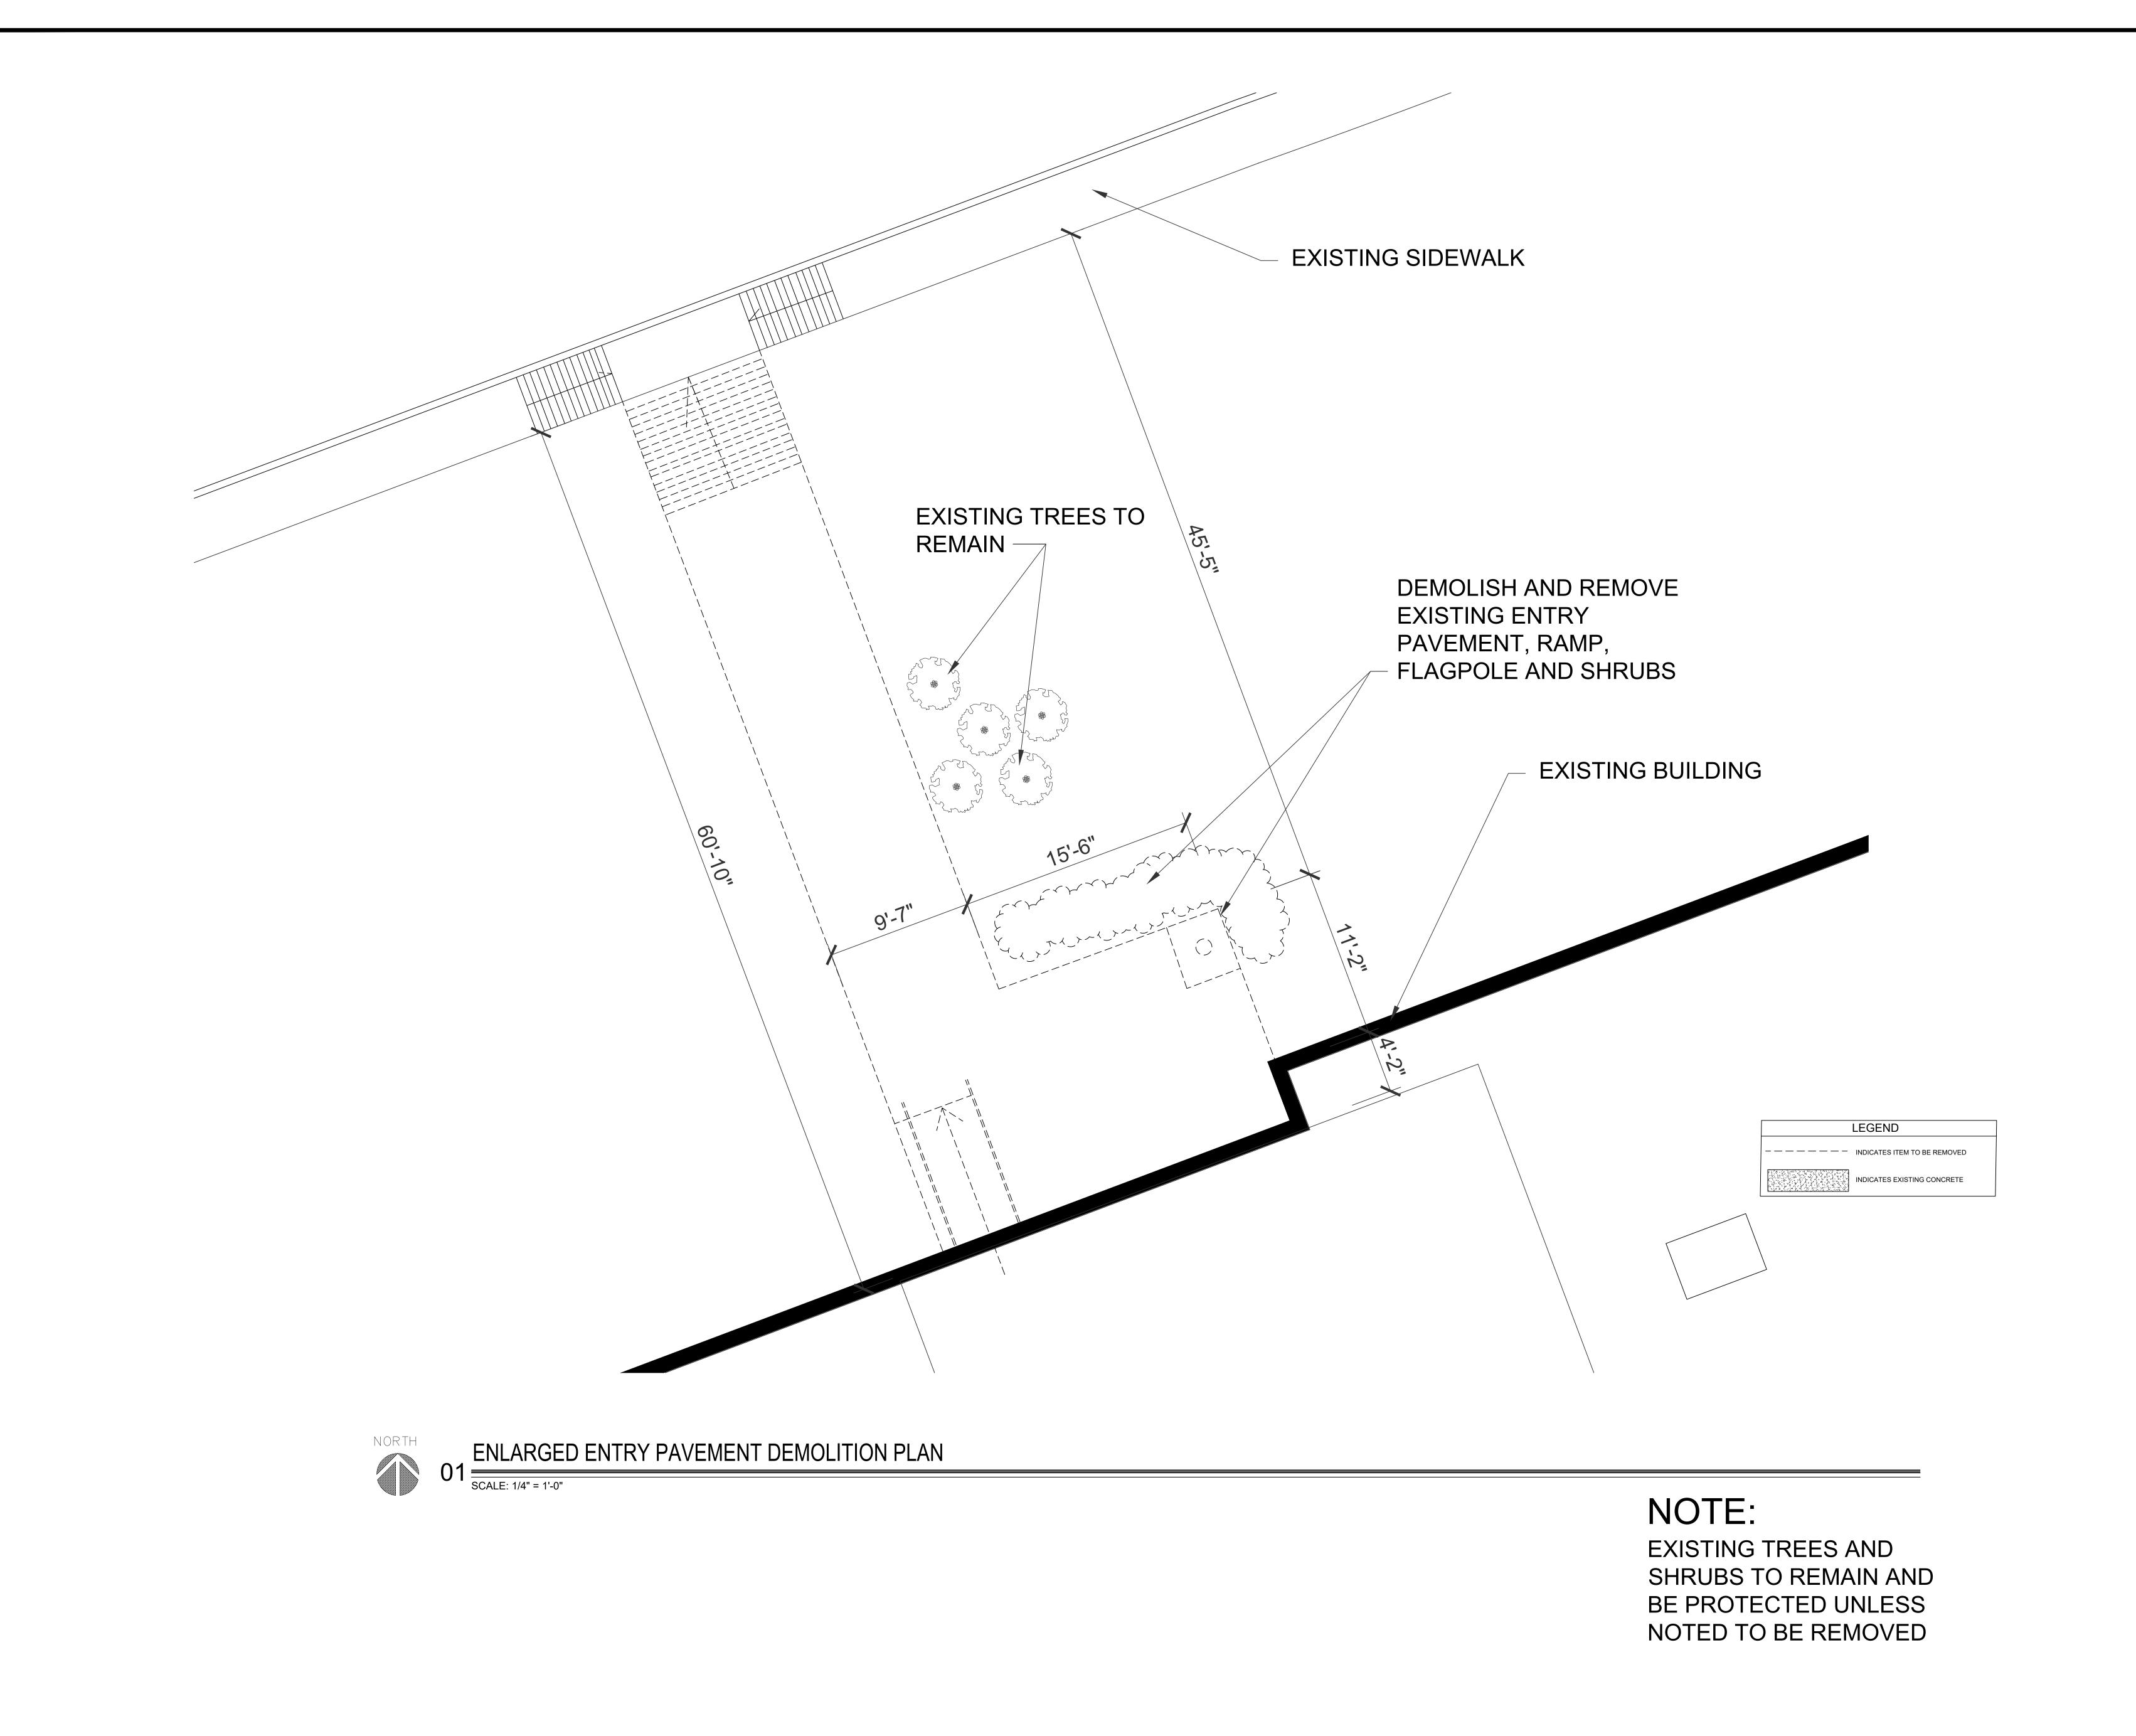
KEY PLAN

JMA Project Number:

TYPICAL DETAILS

S-501





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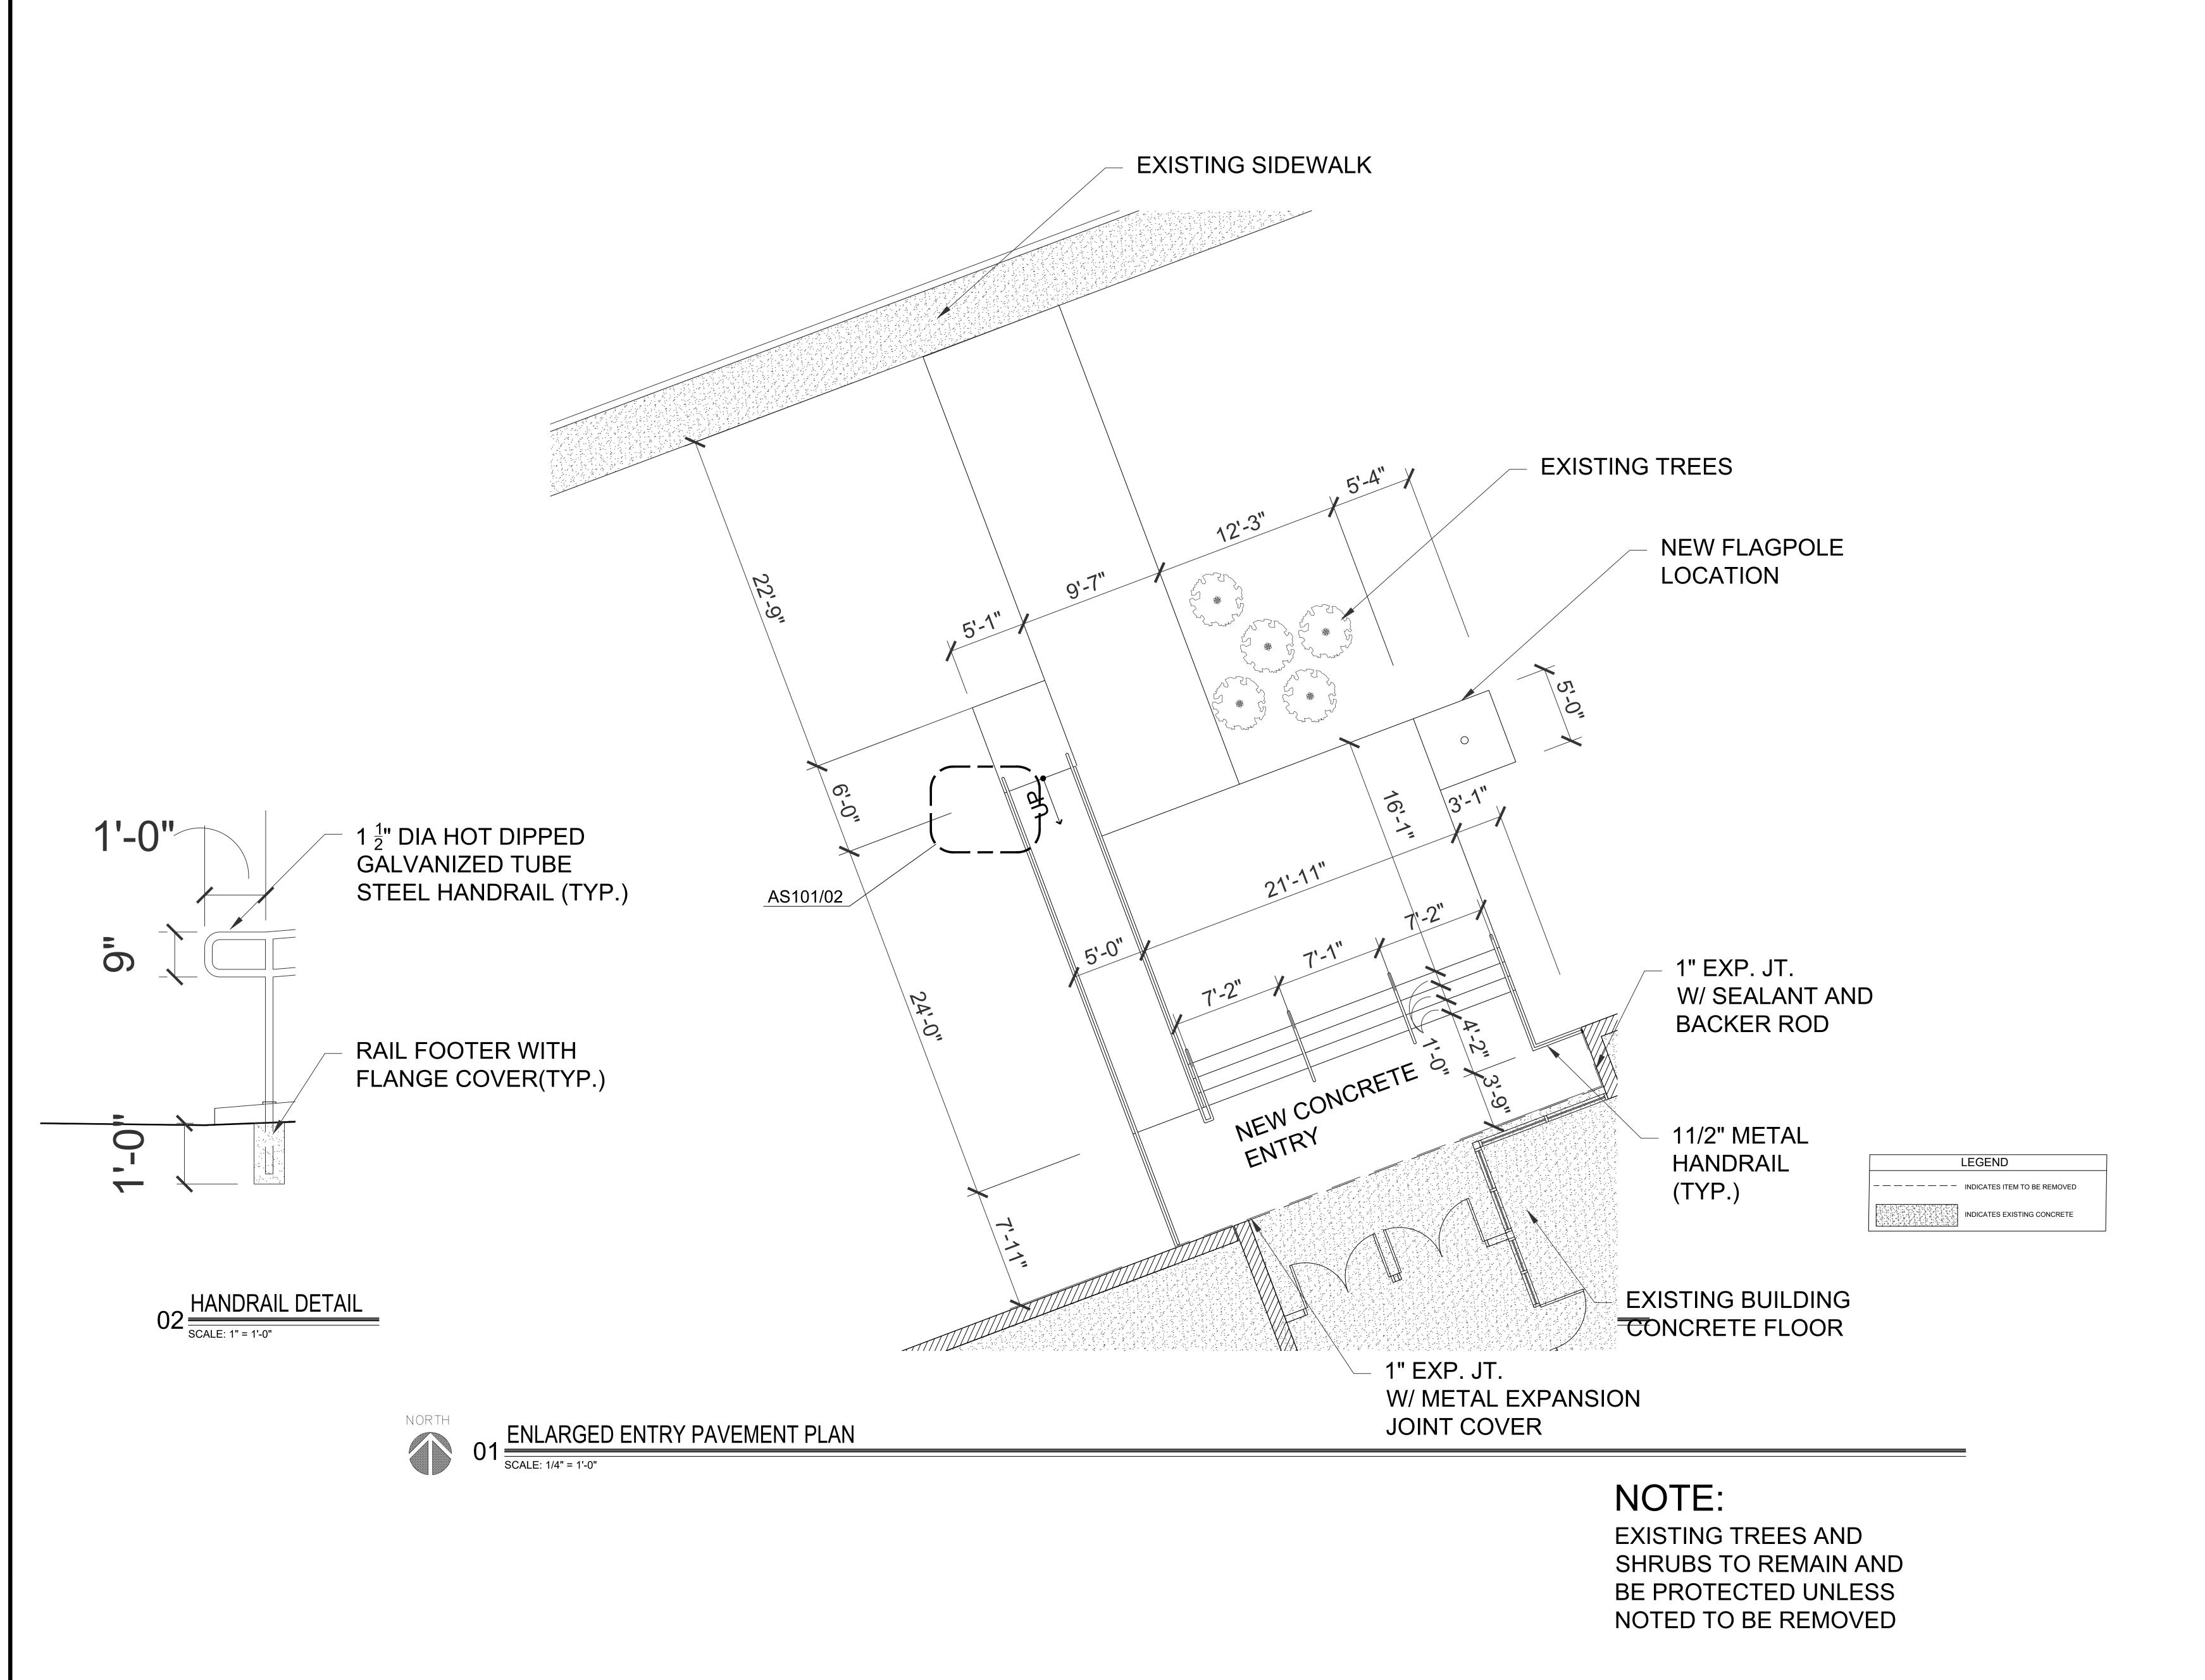
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PLAN

ASD100

Sheet Title

Sheet Number



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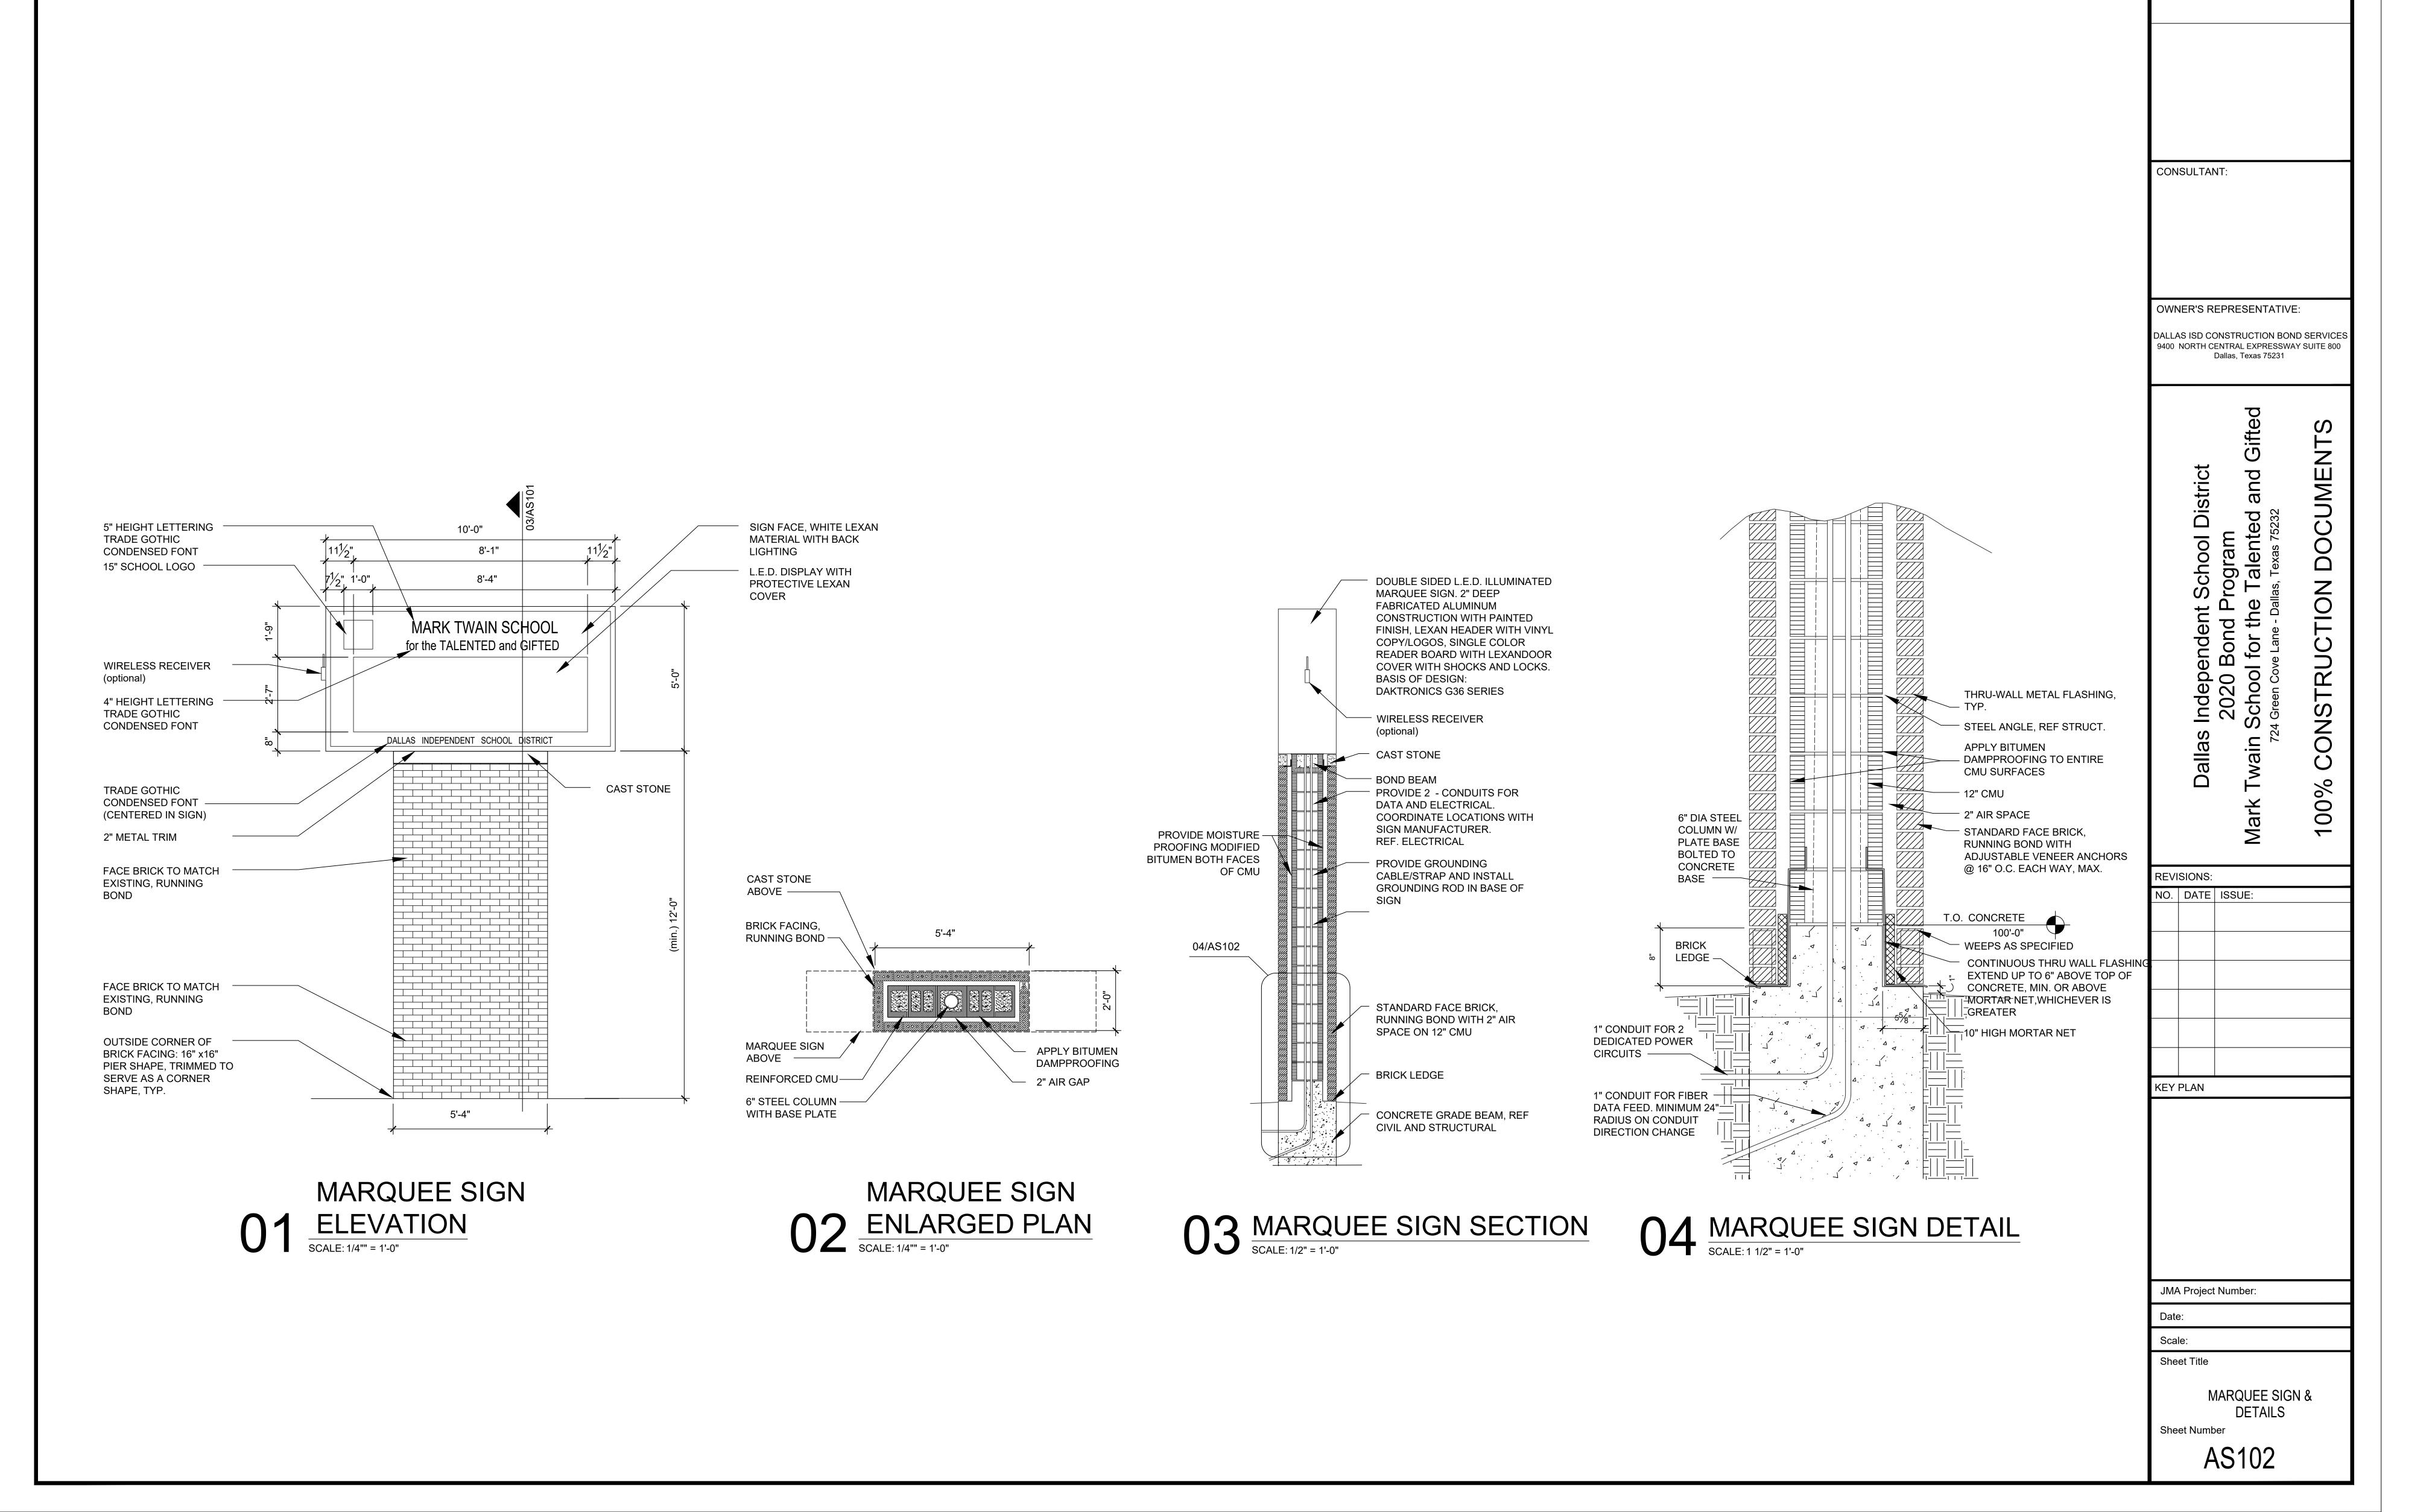
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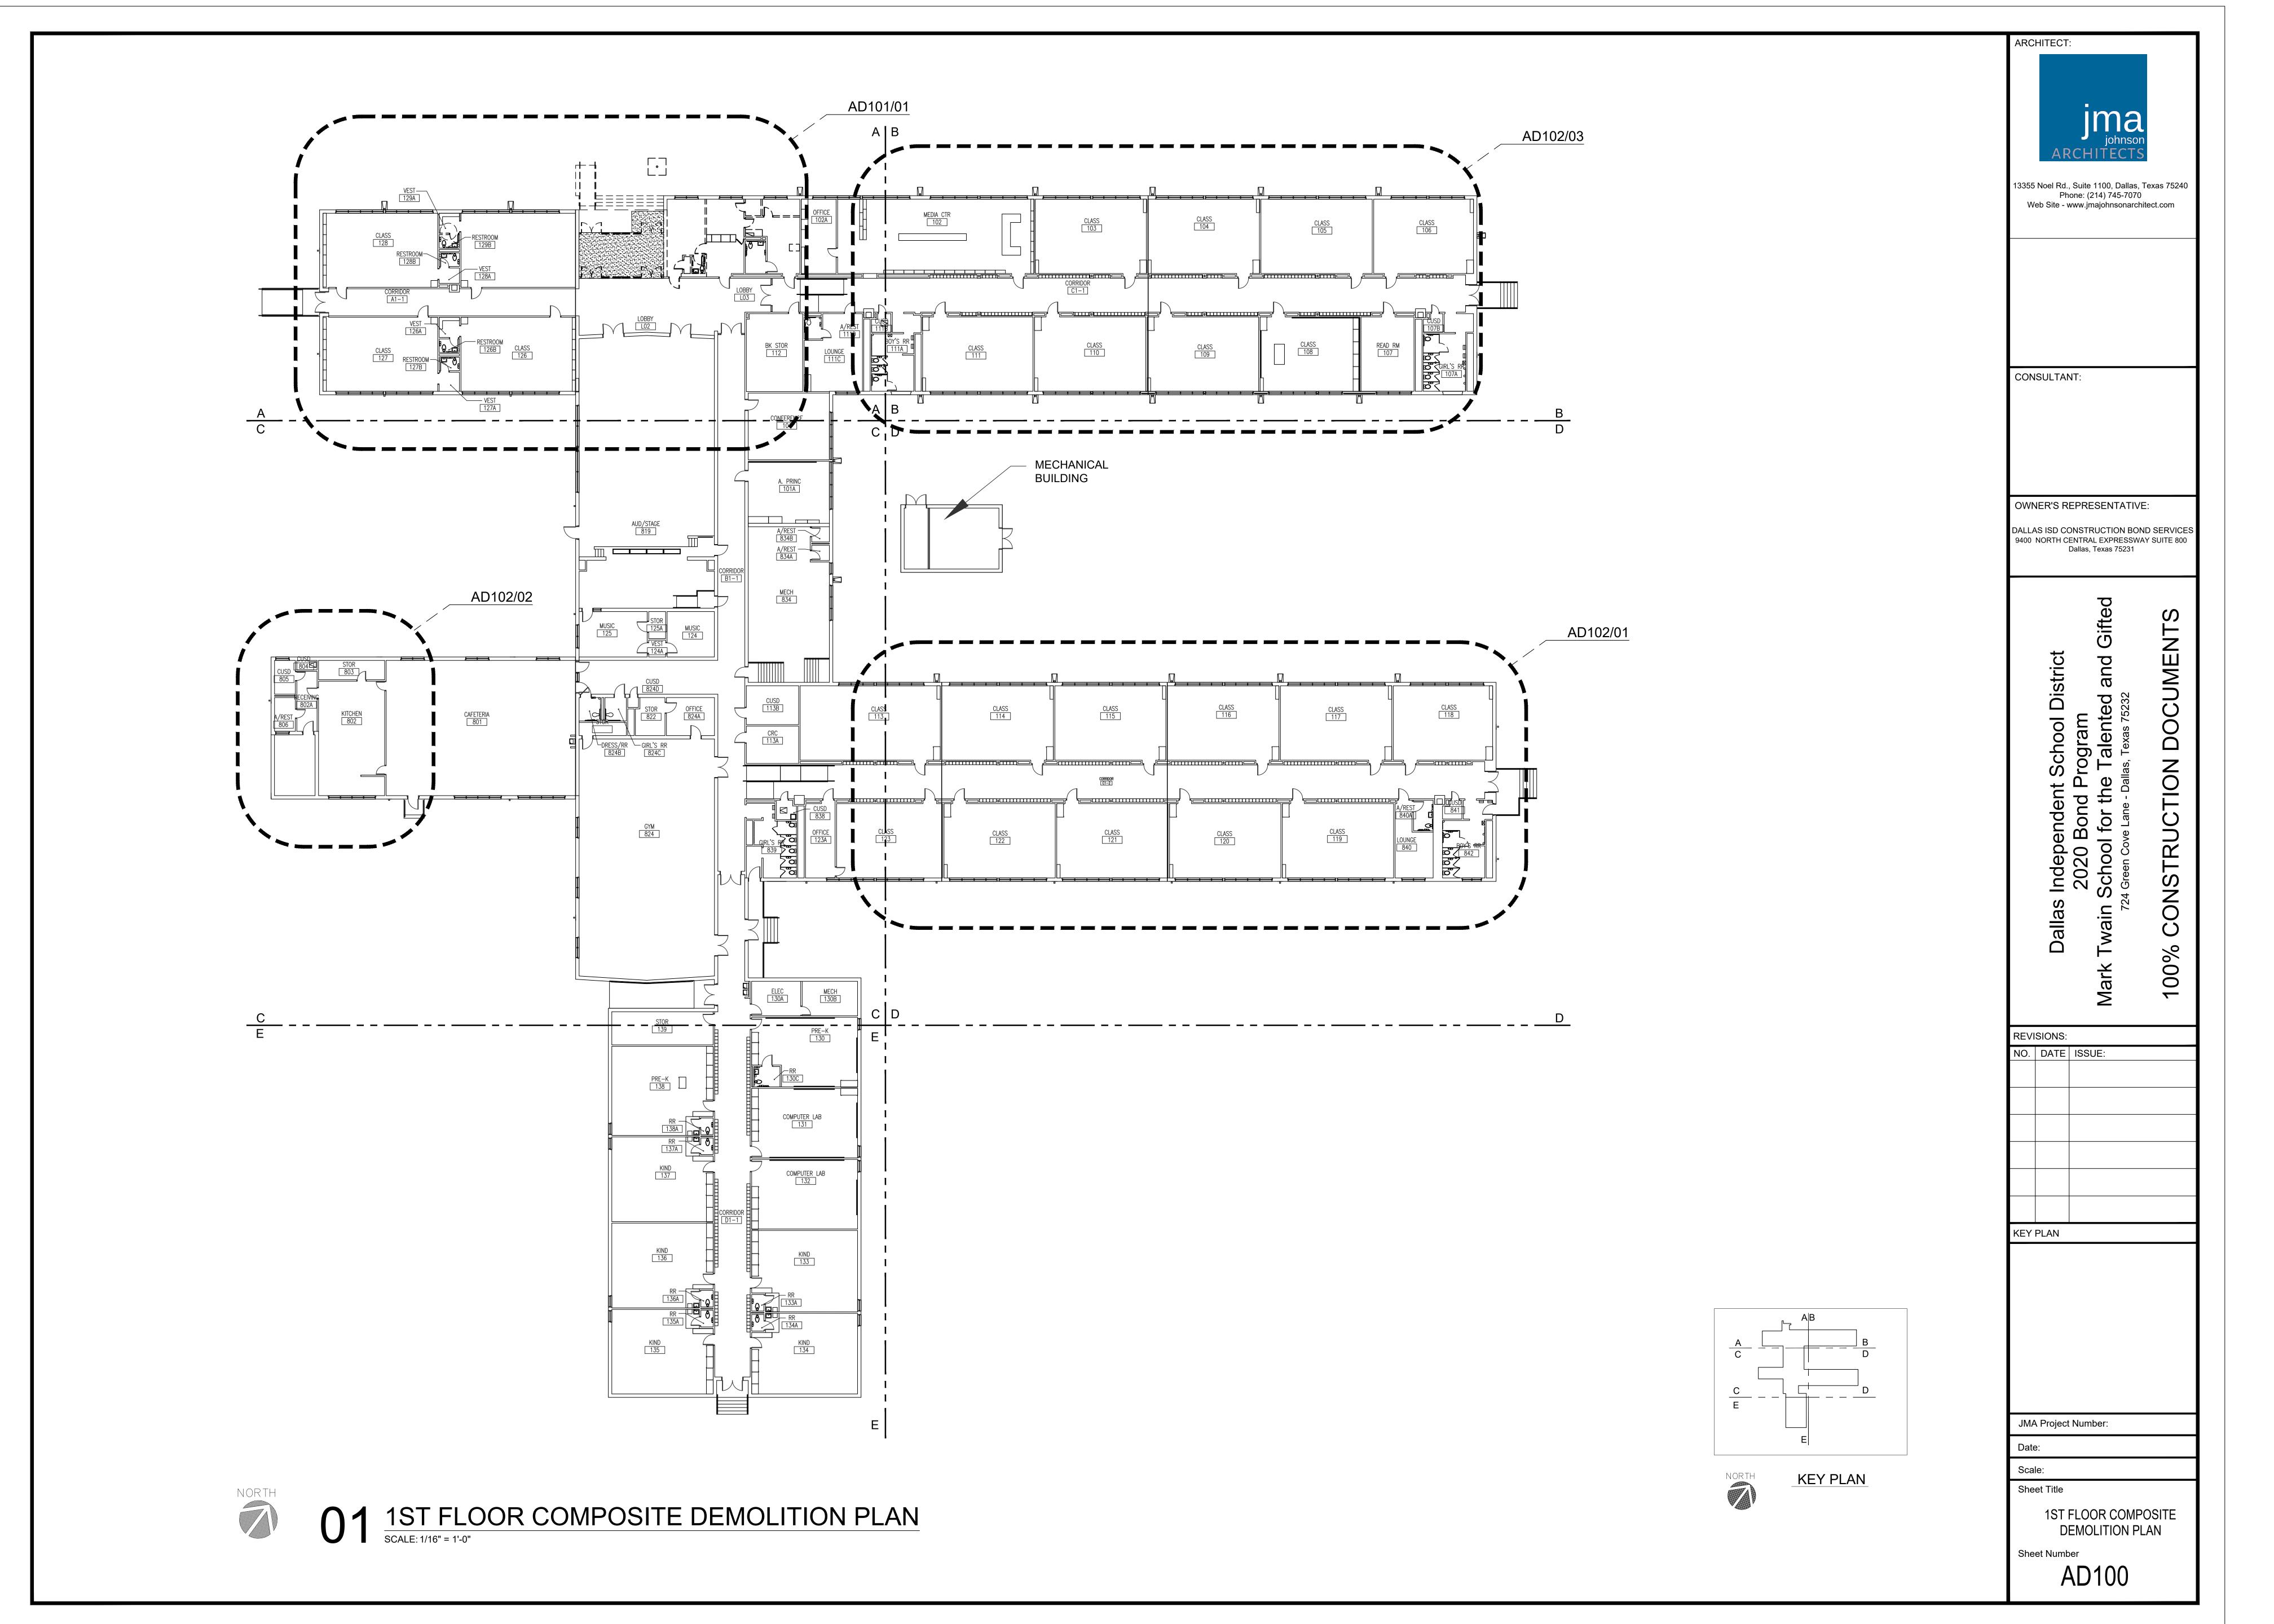
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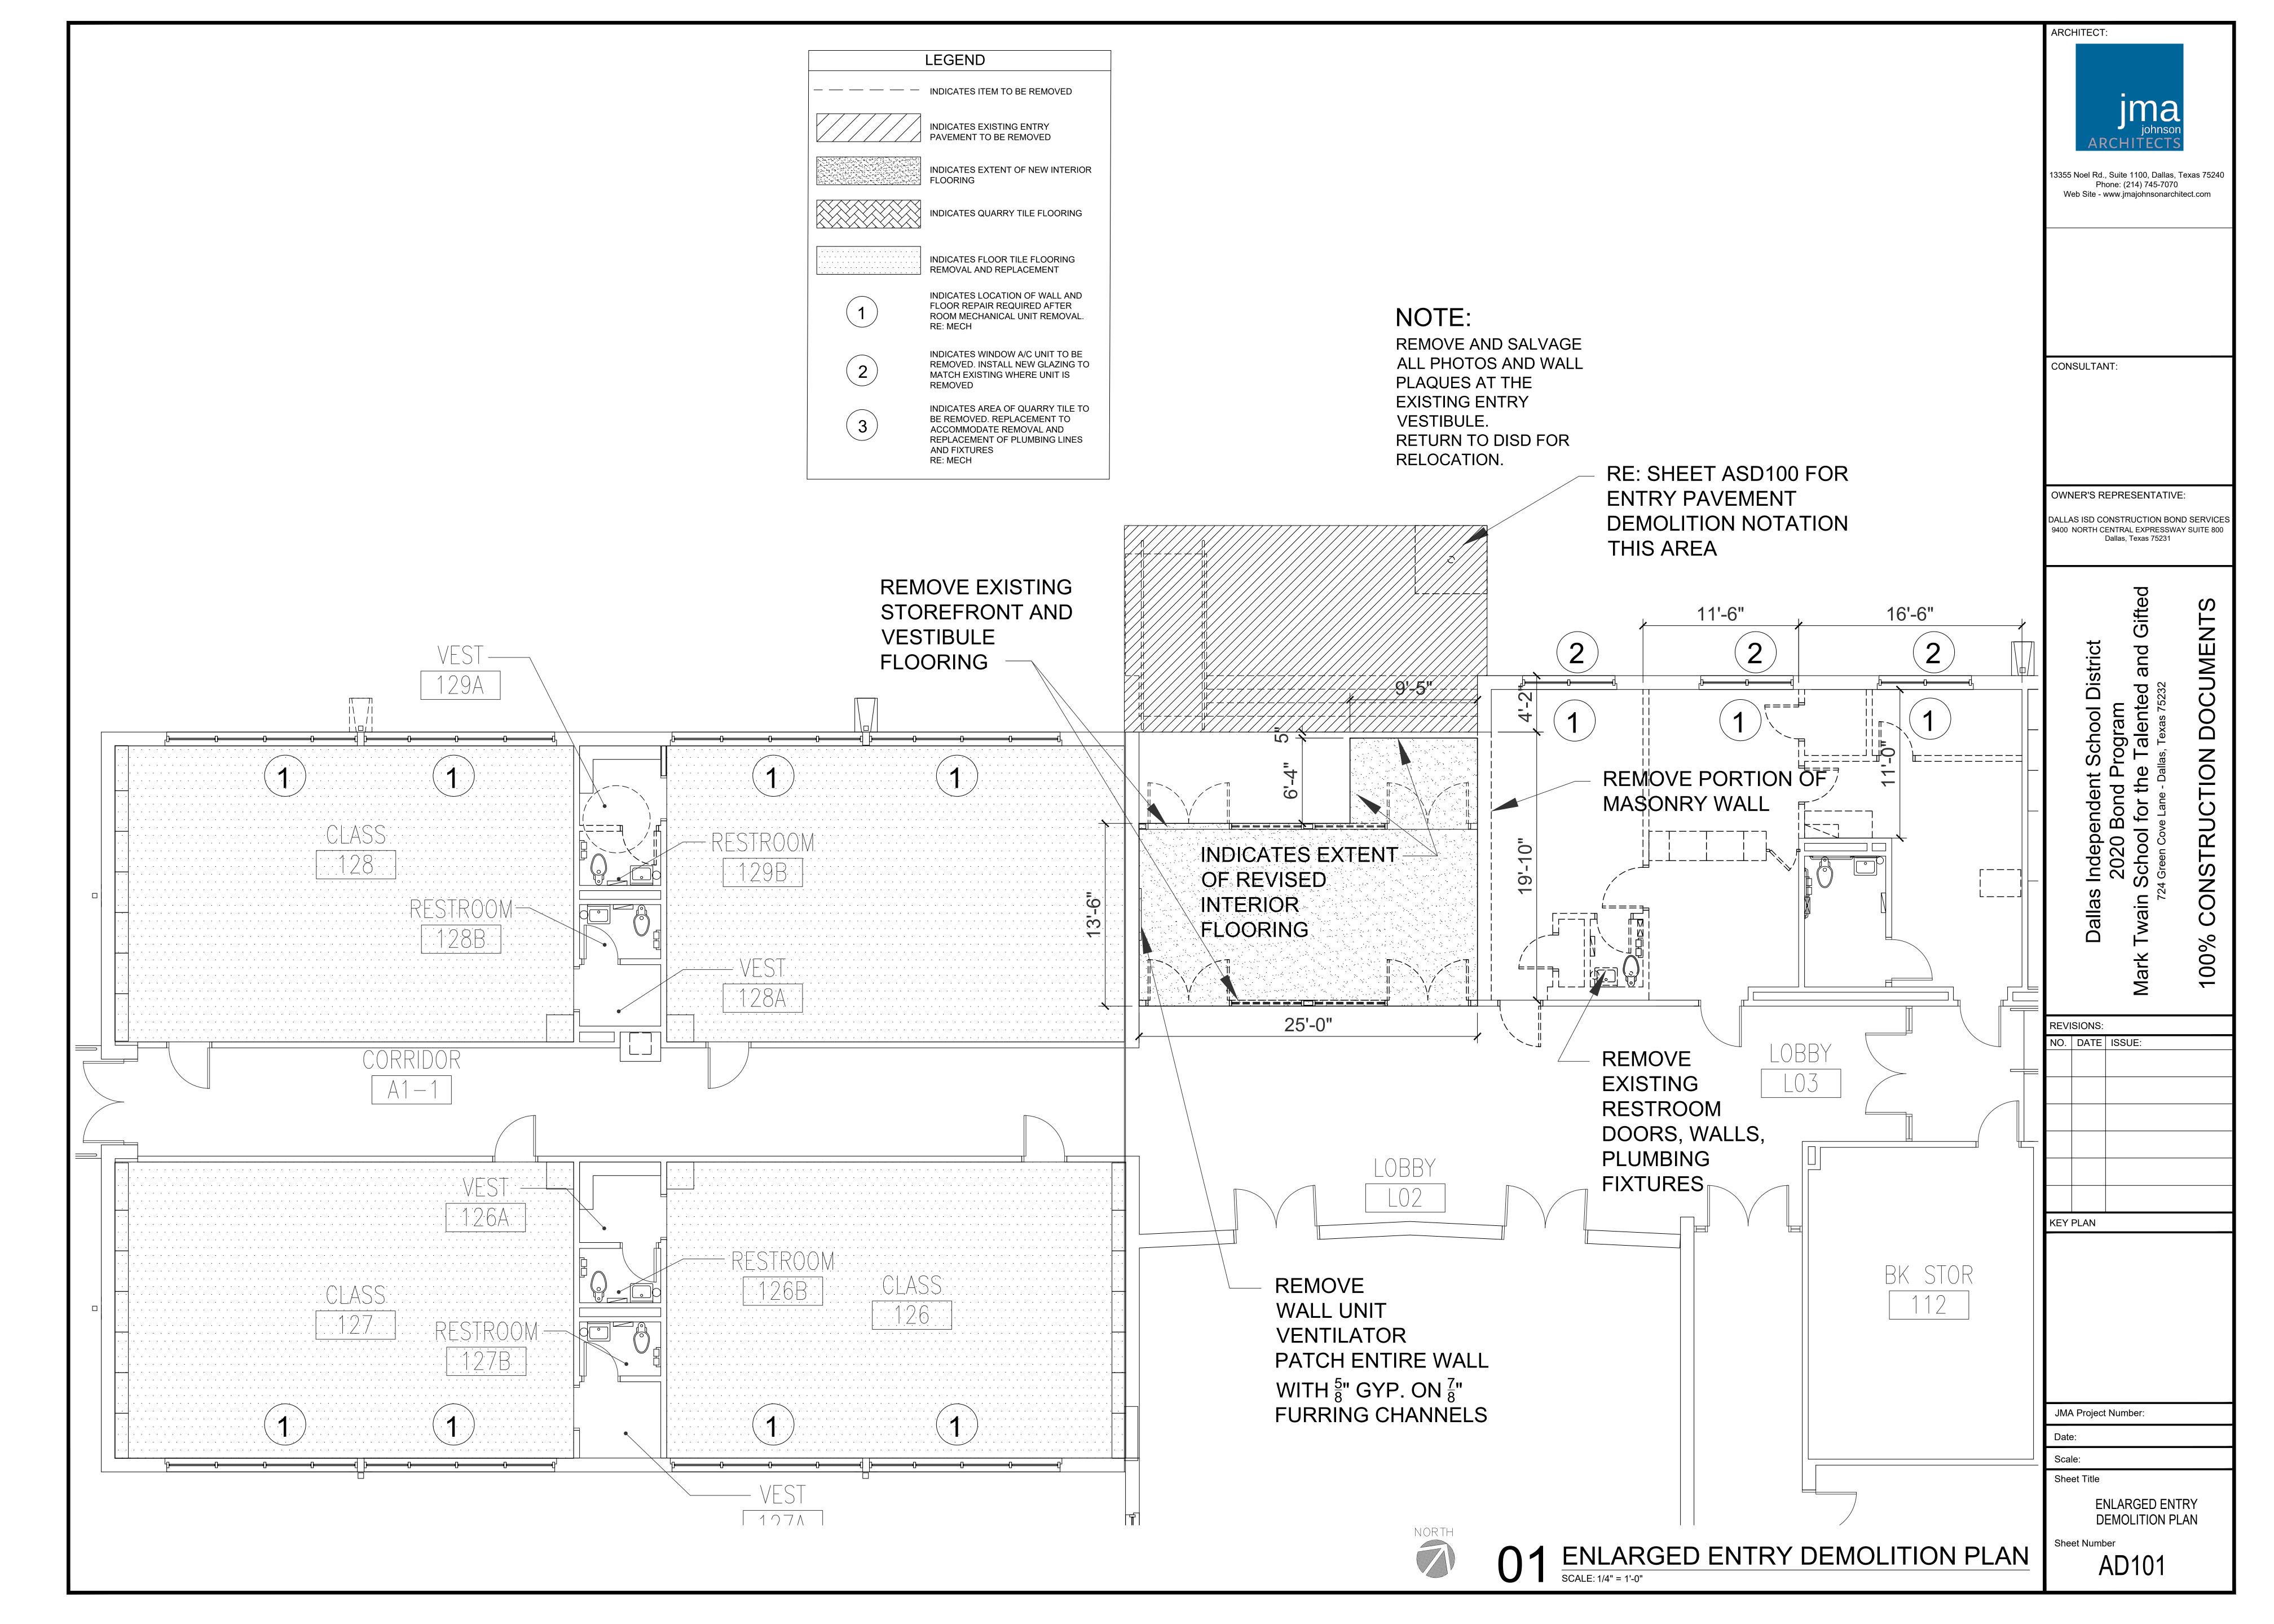
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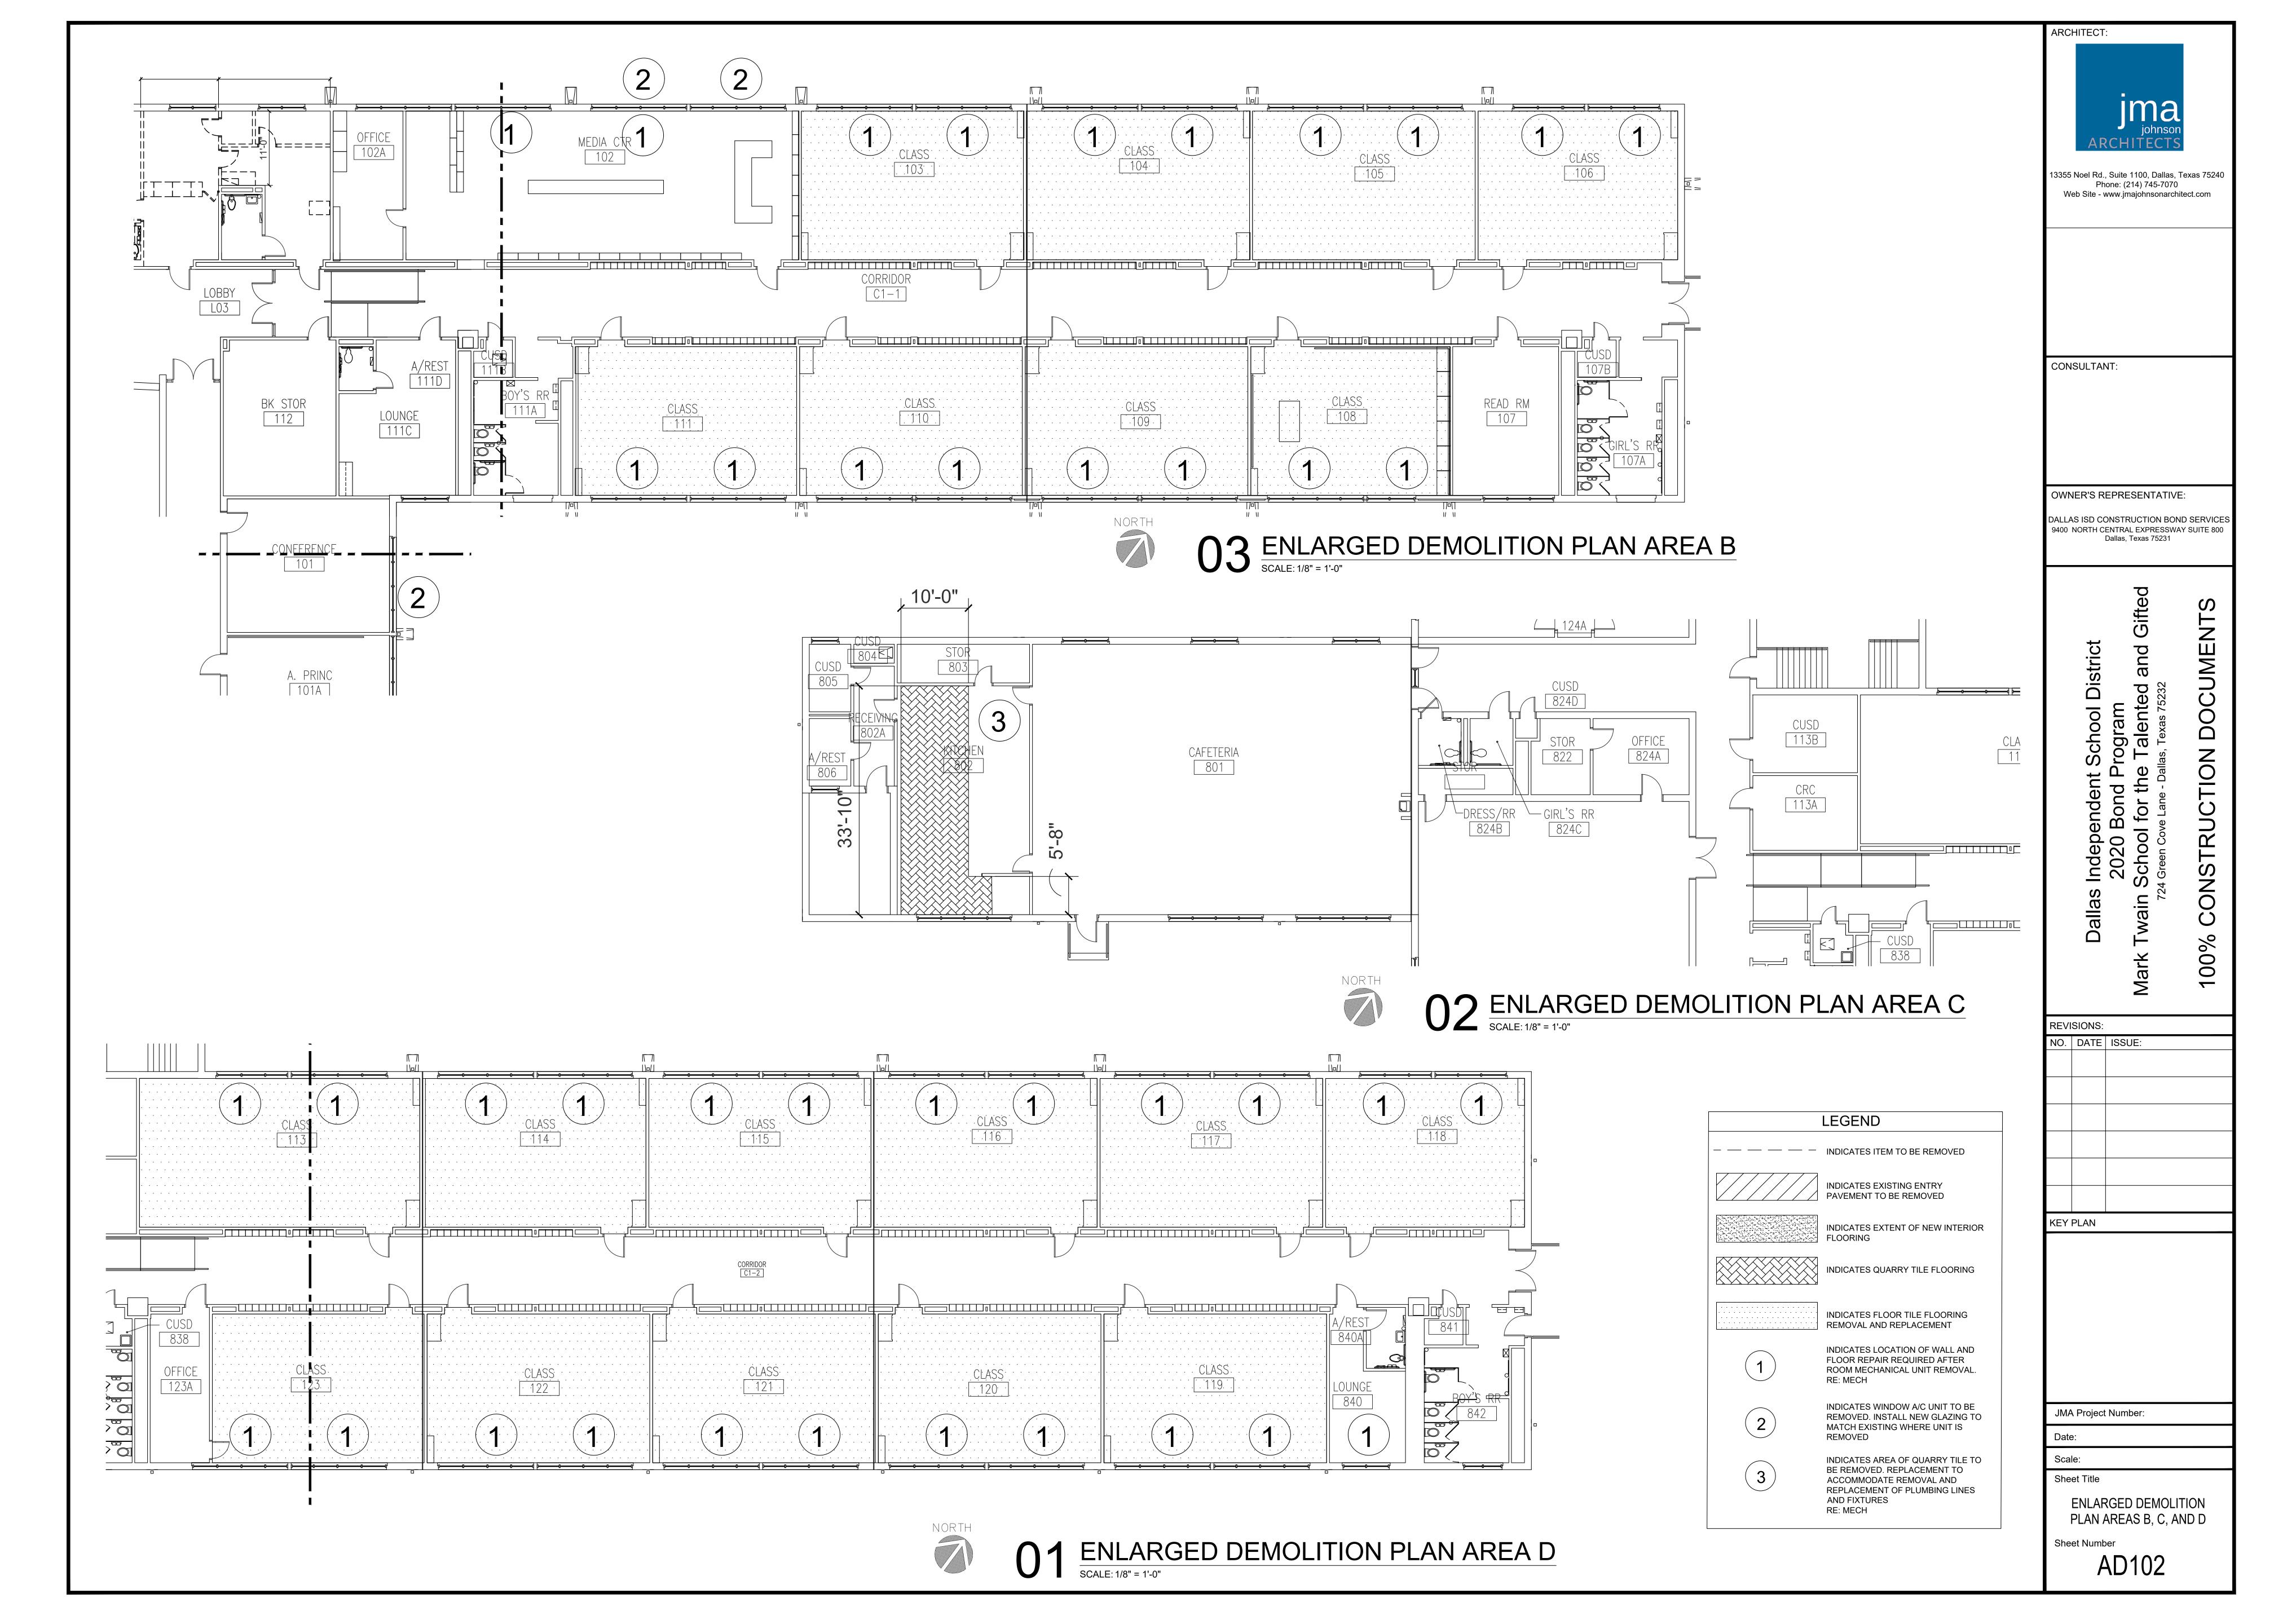
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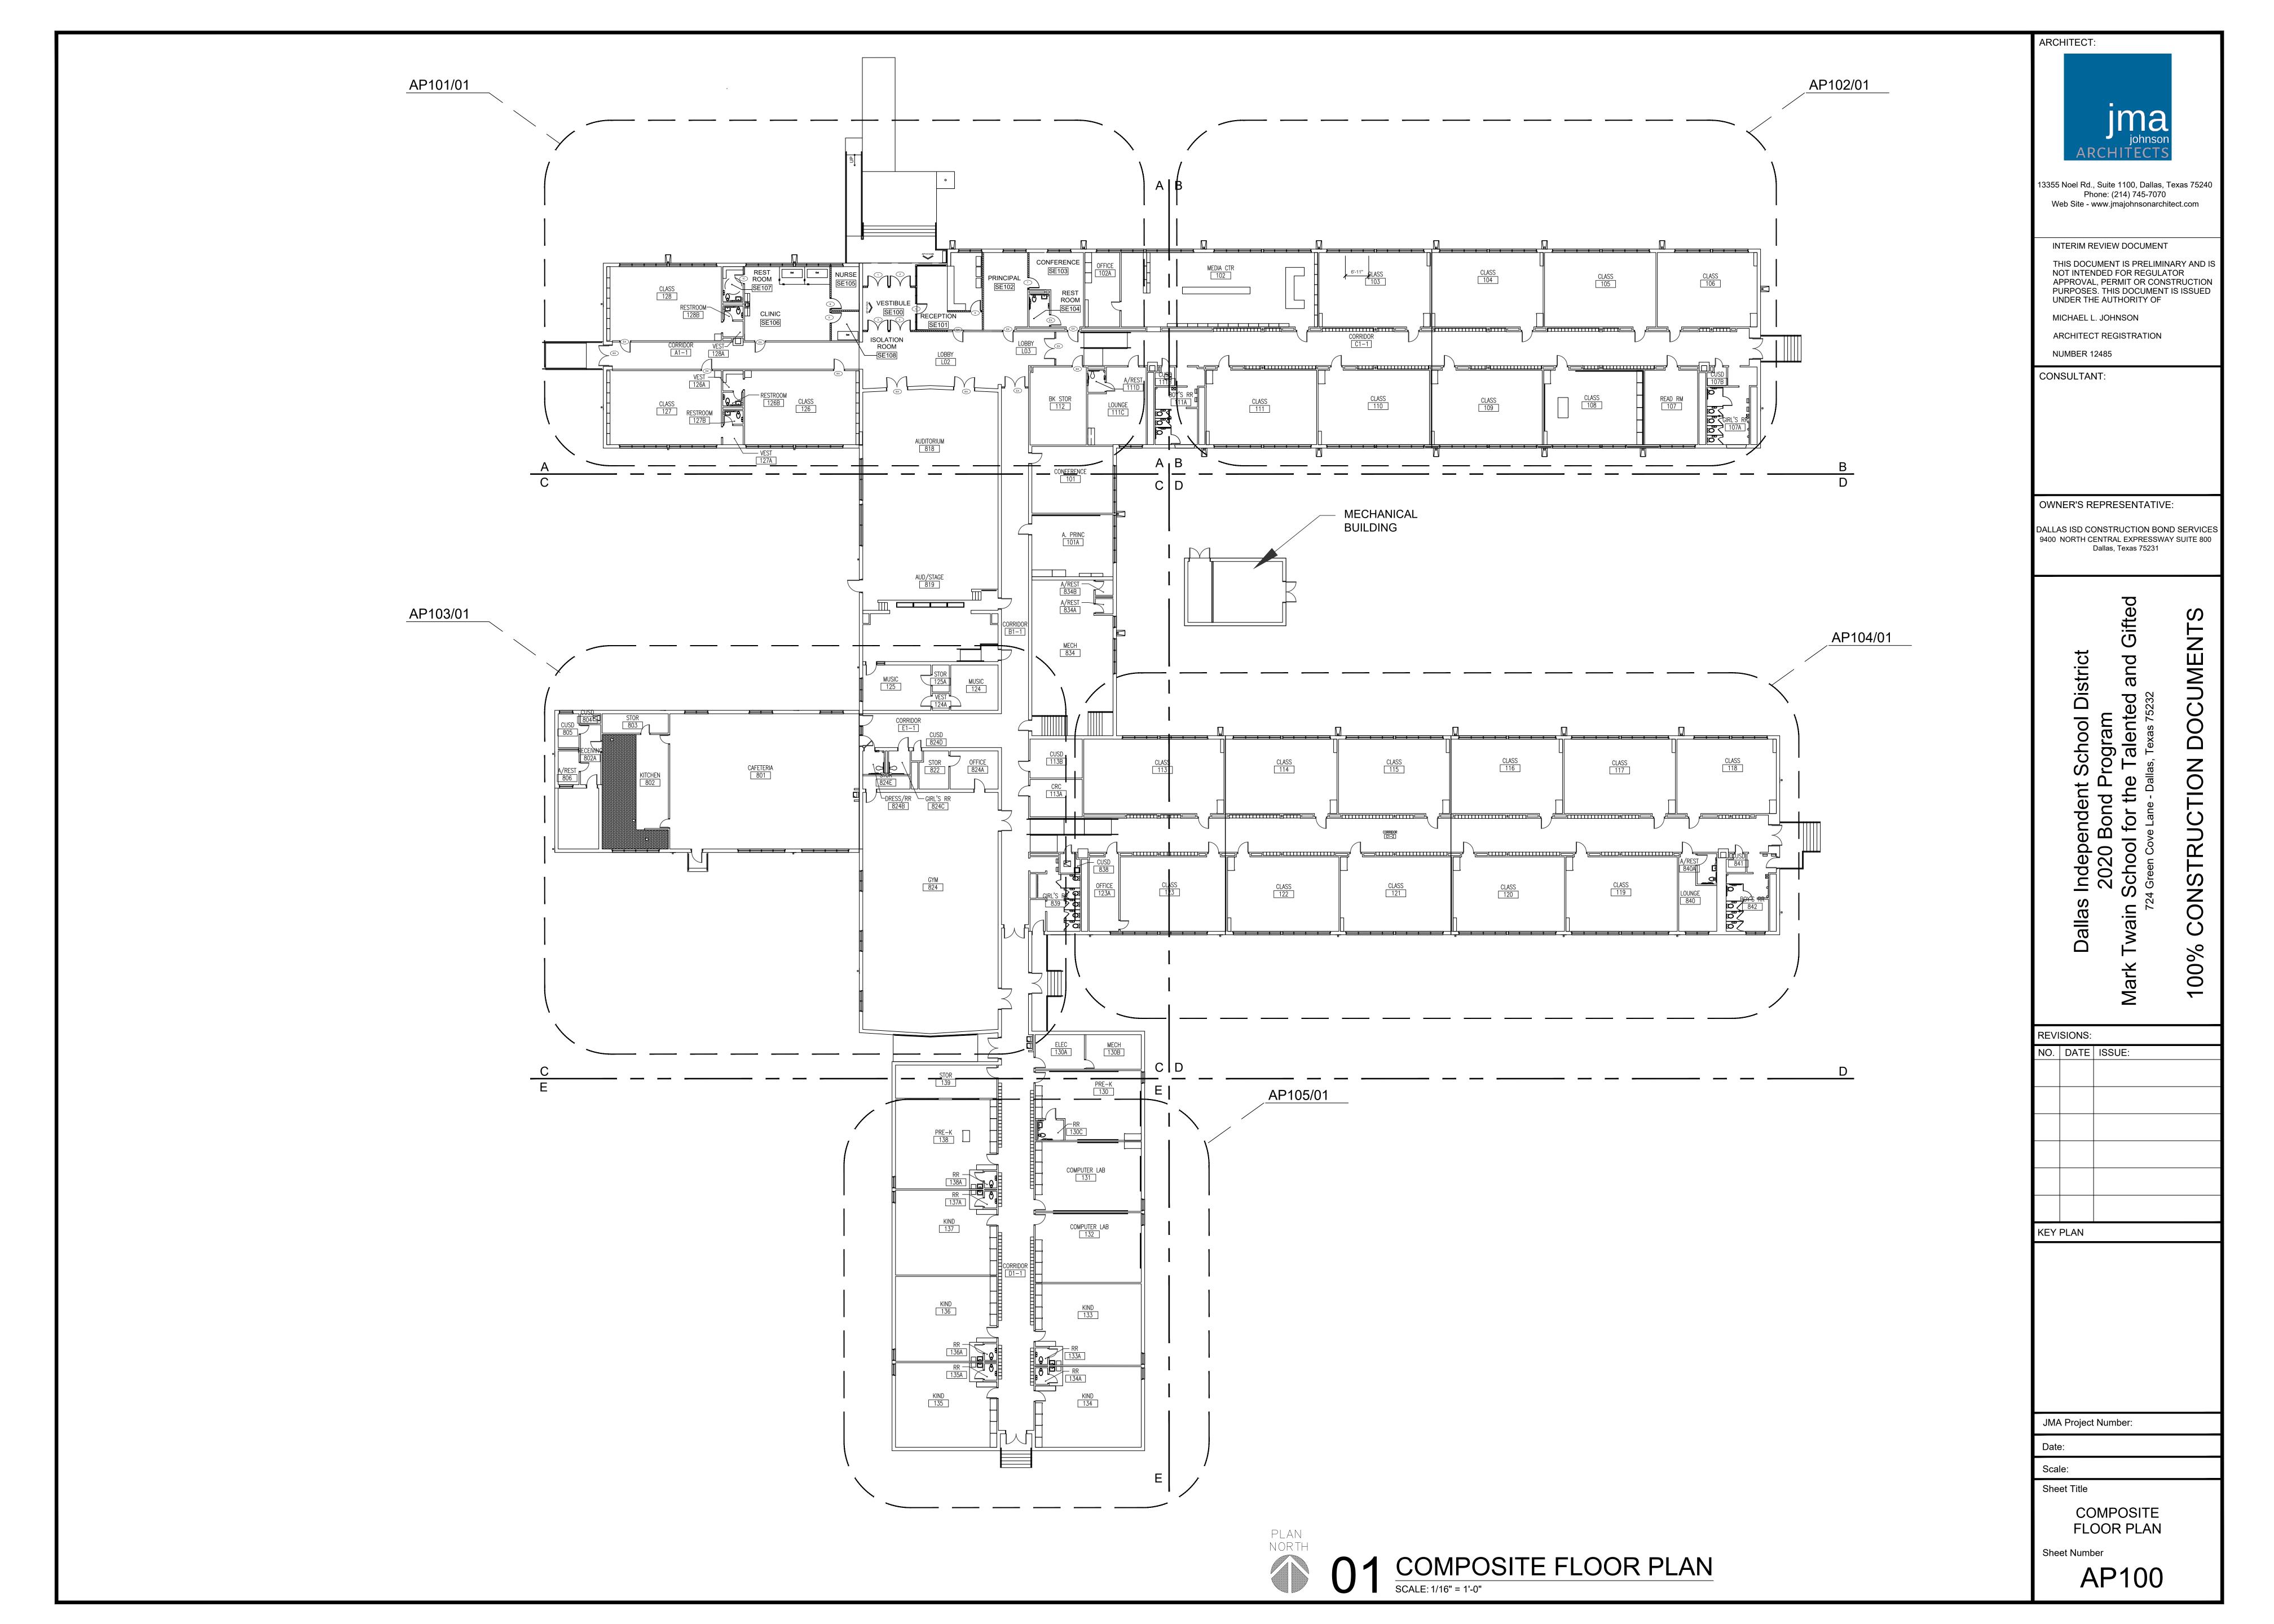



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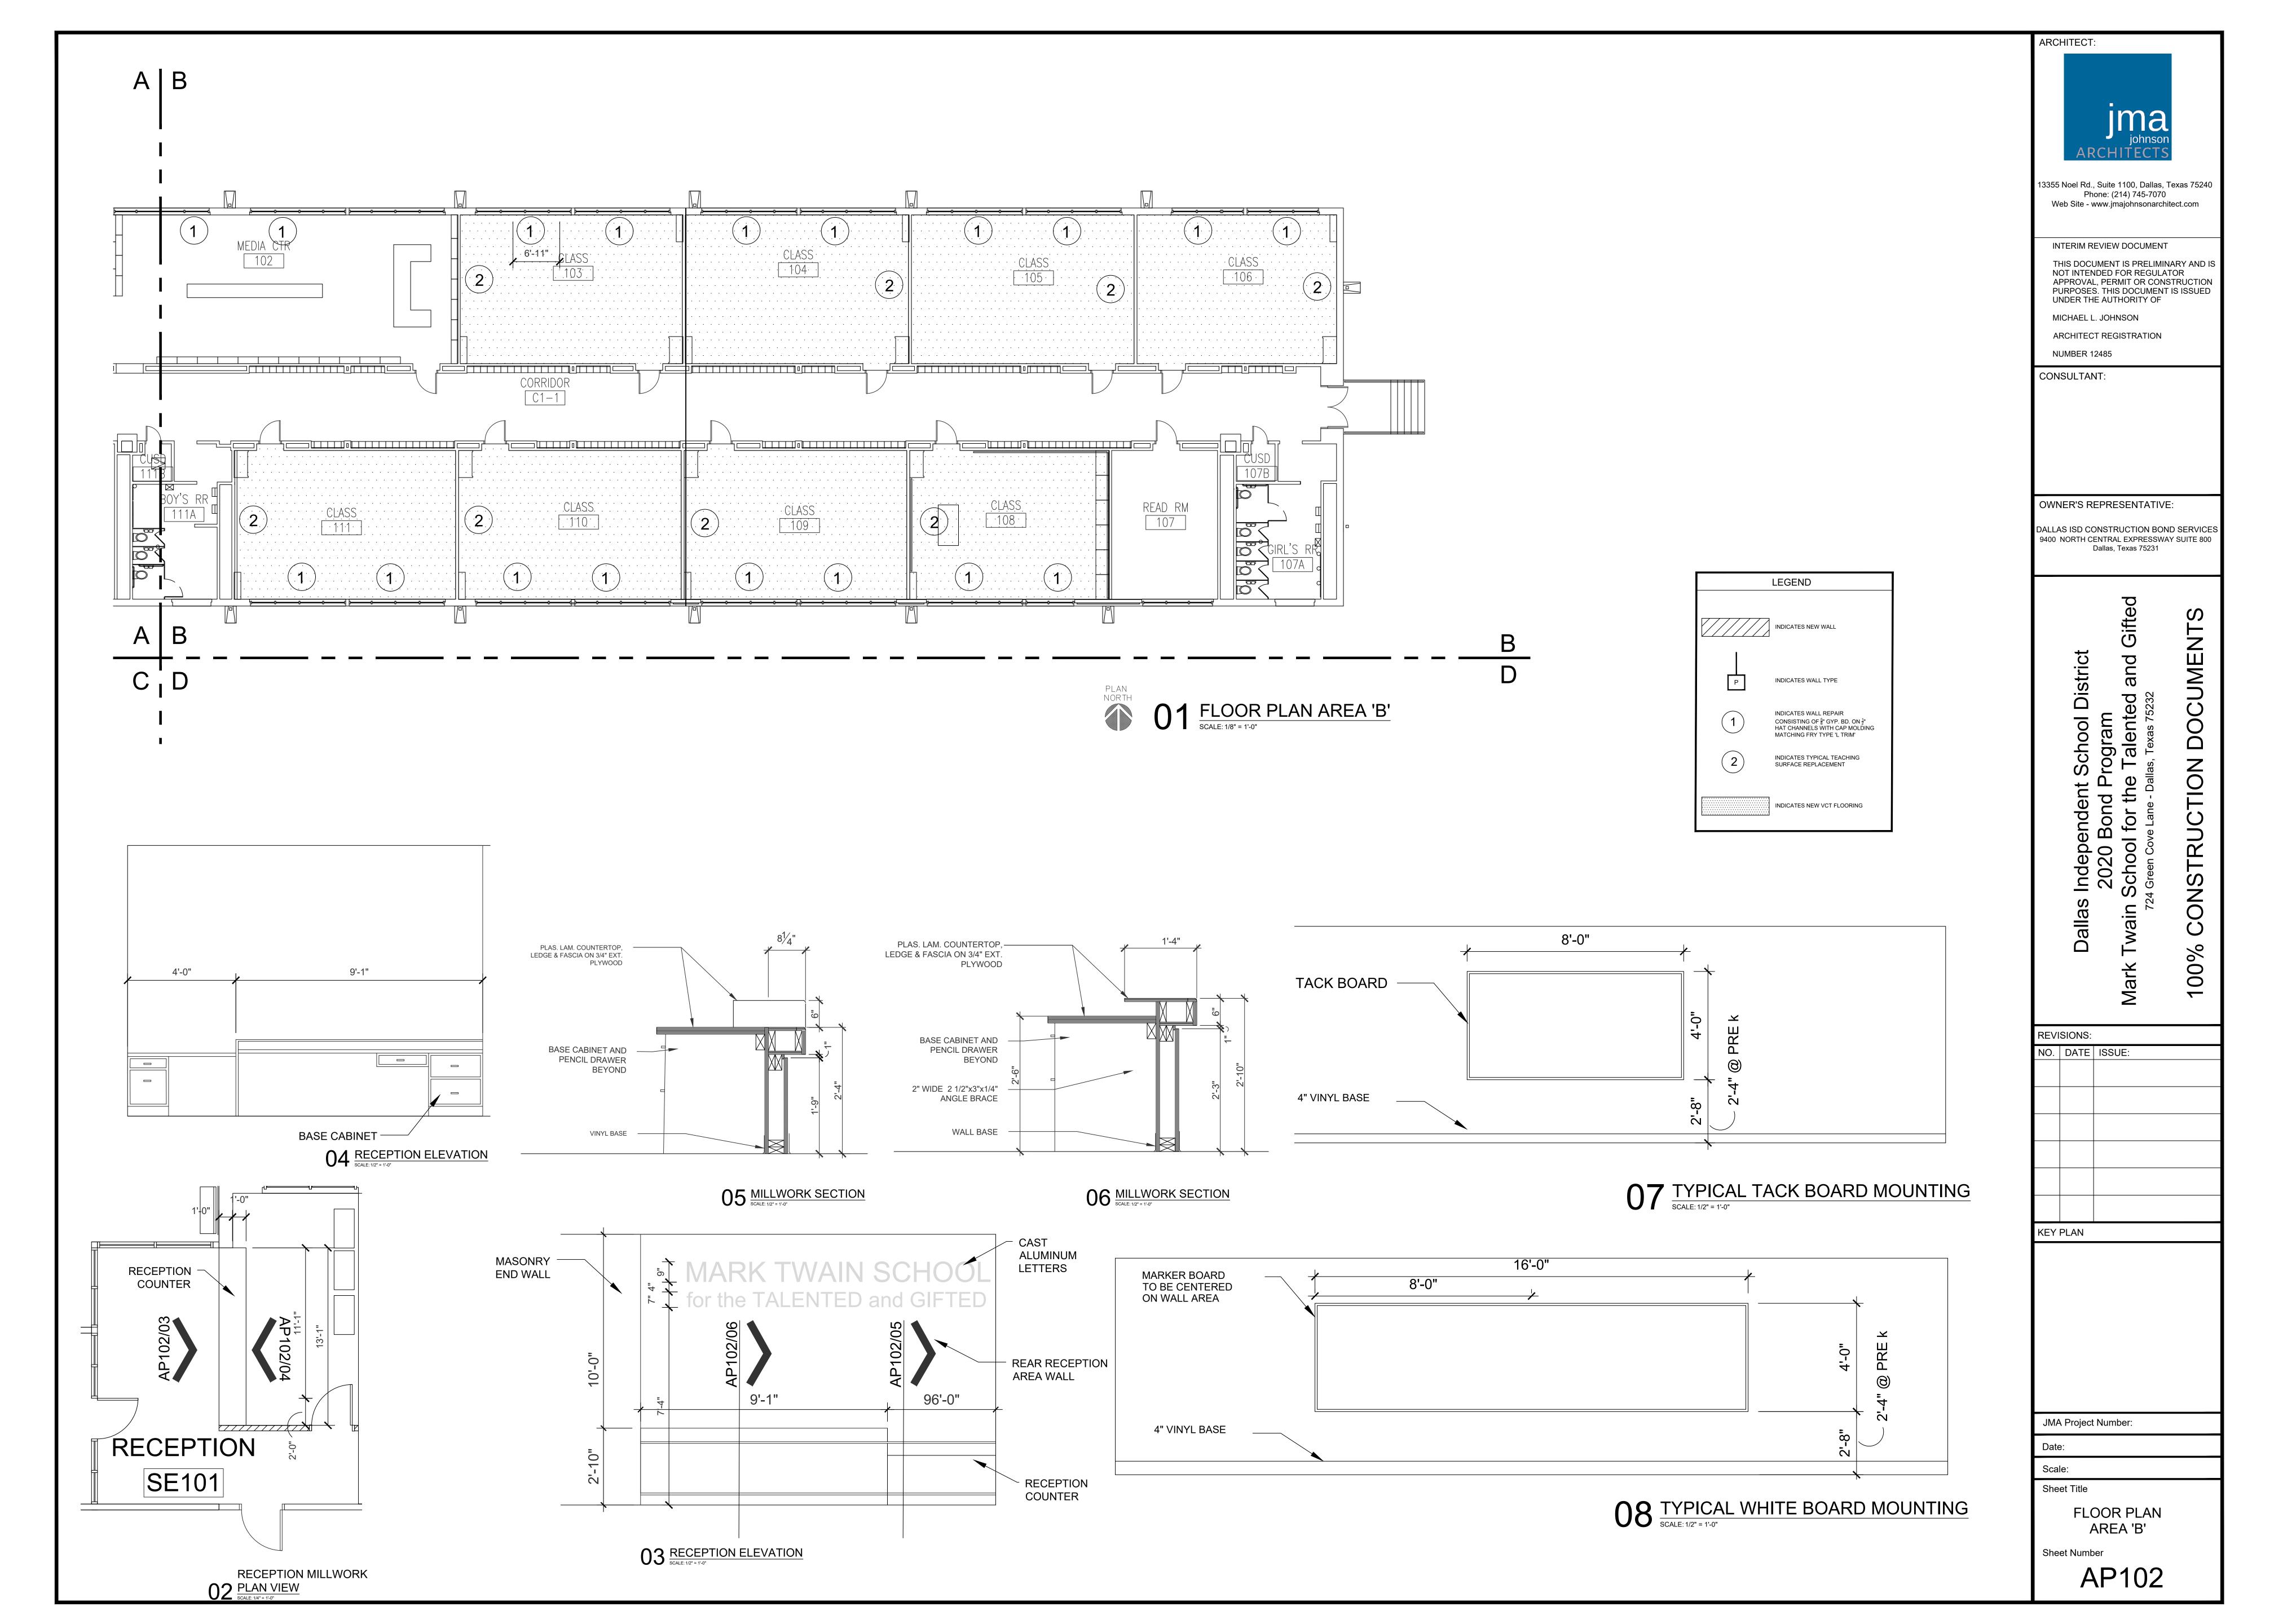











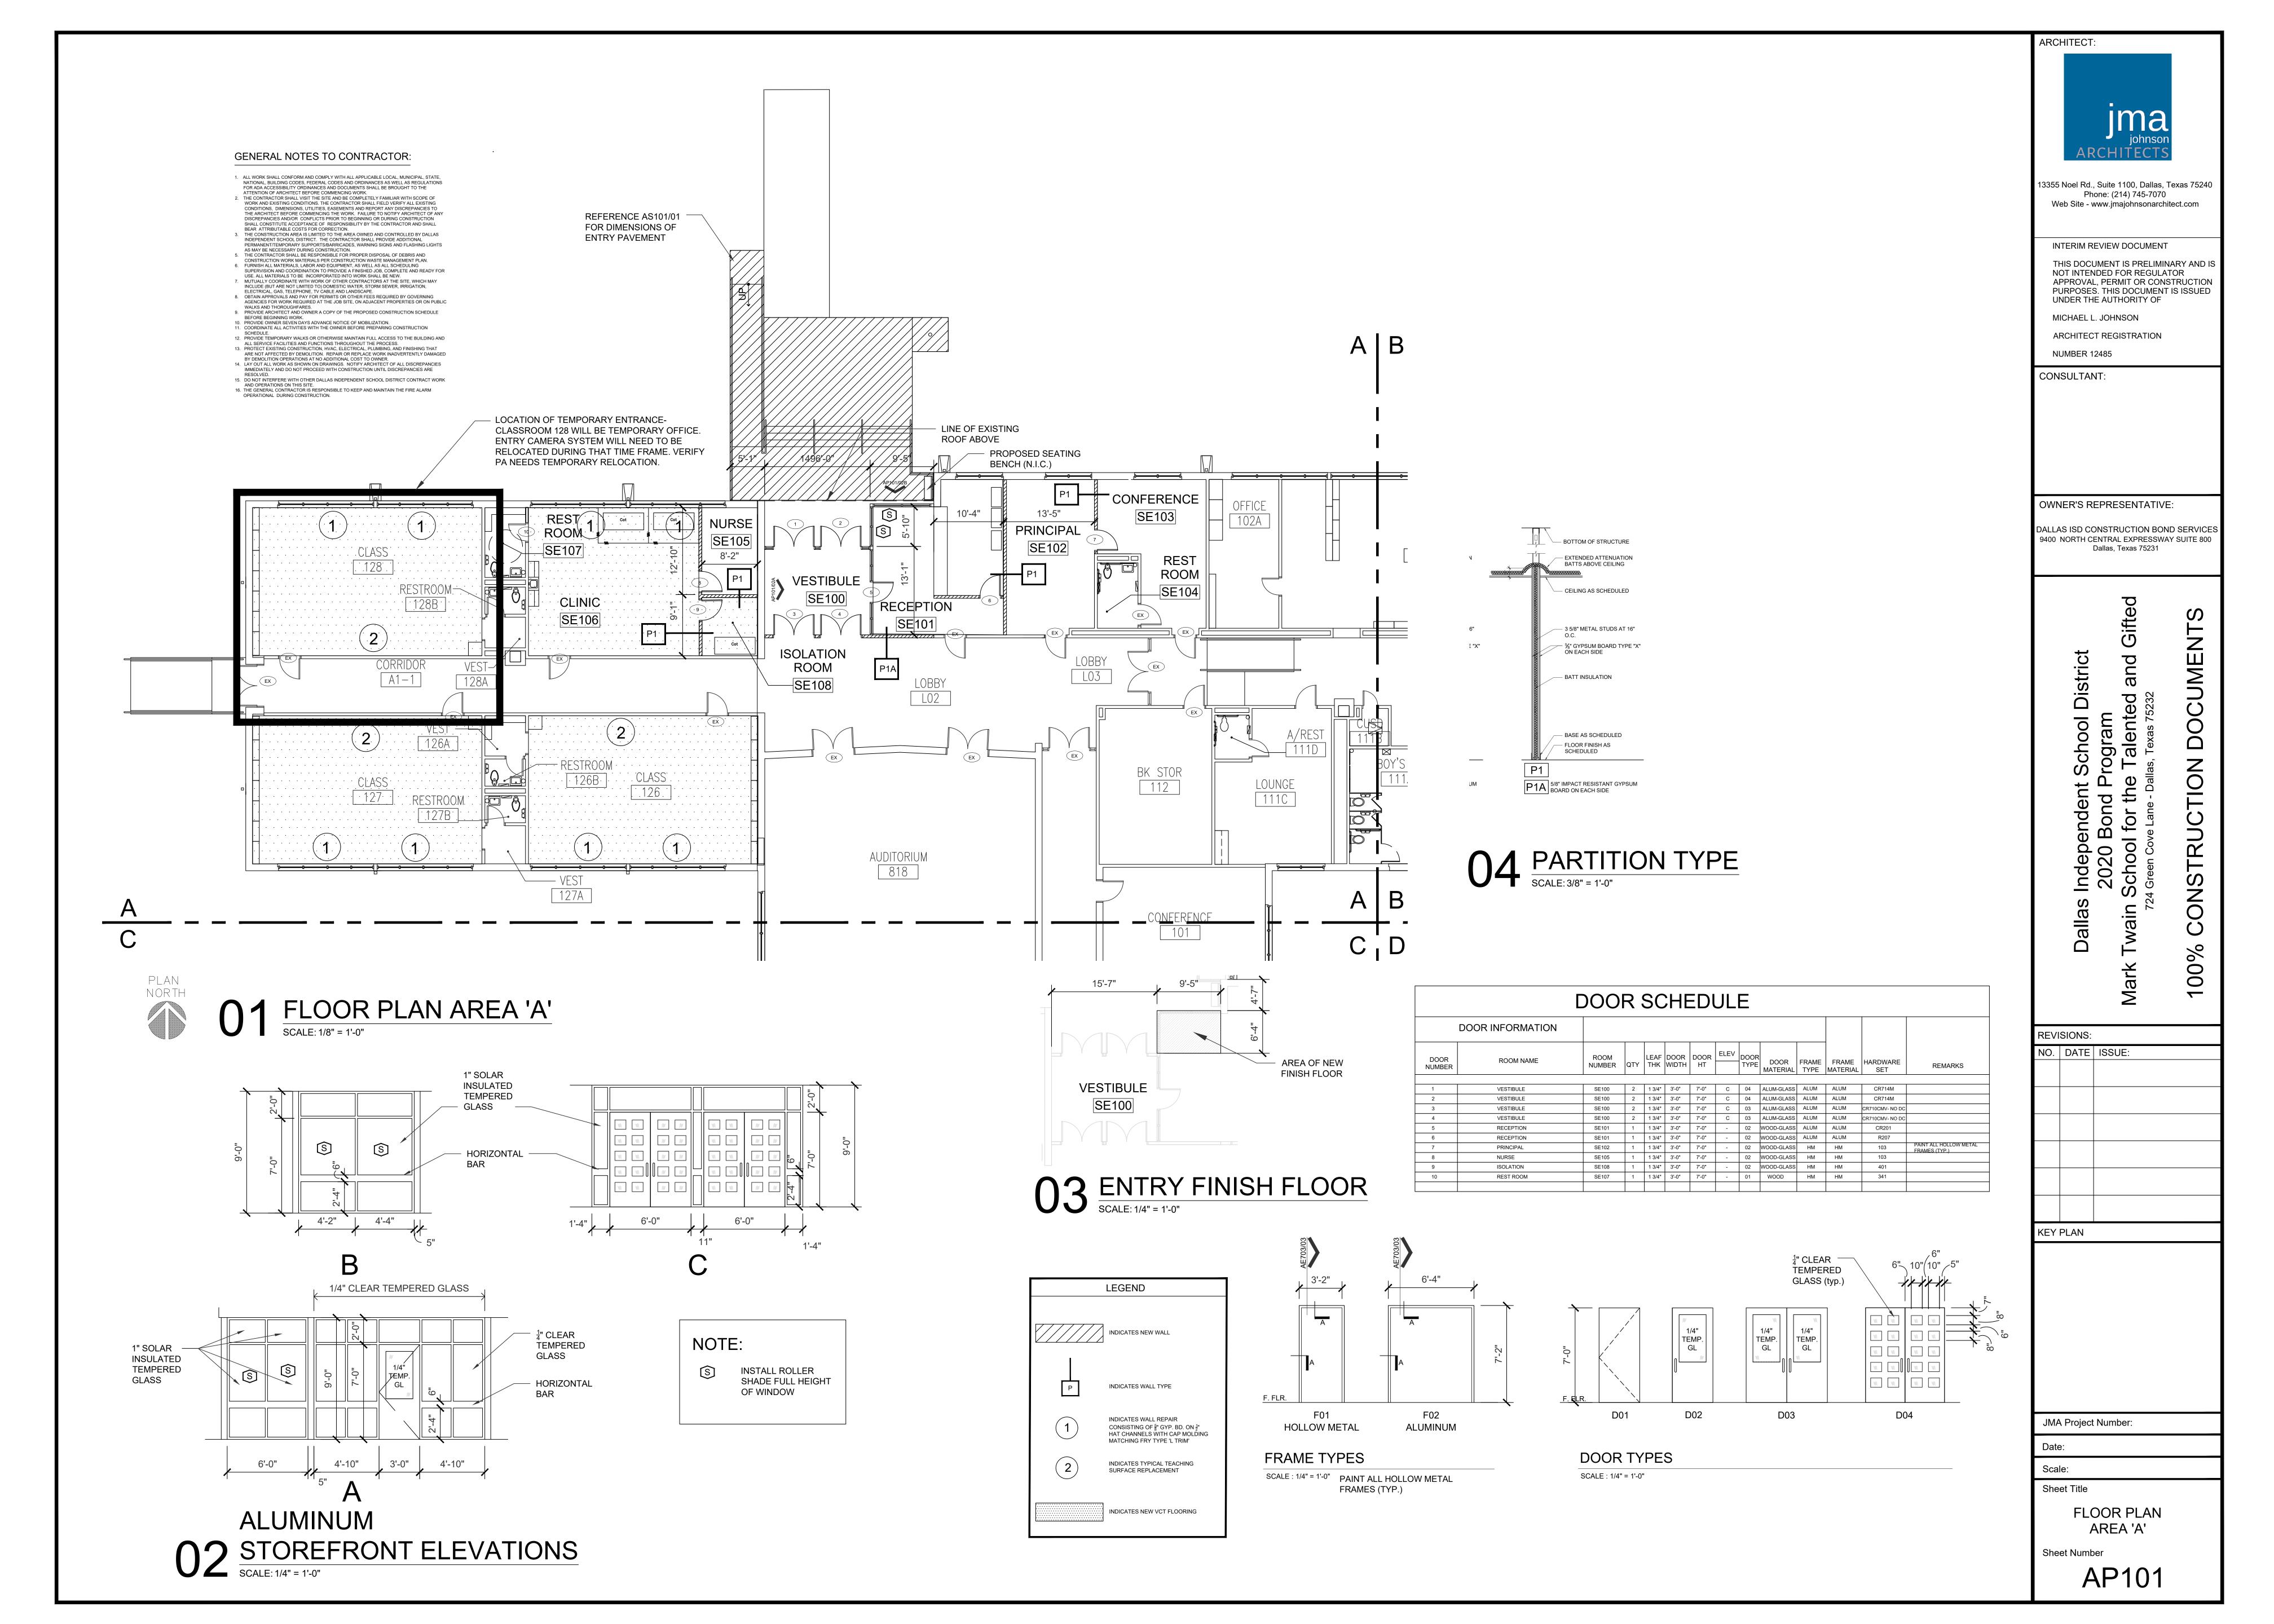


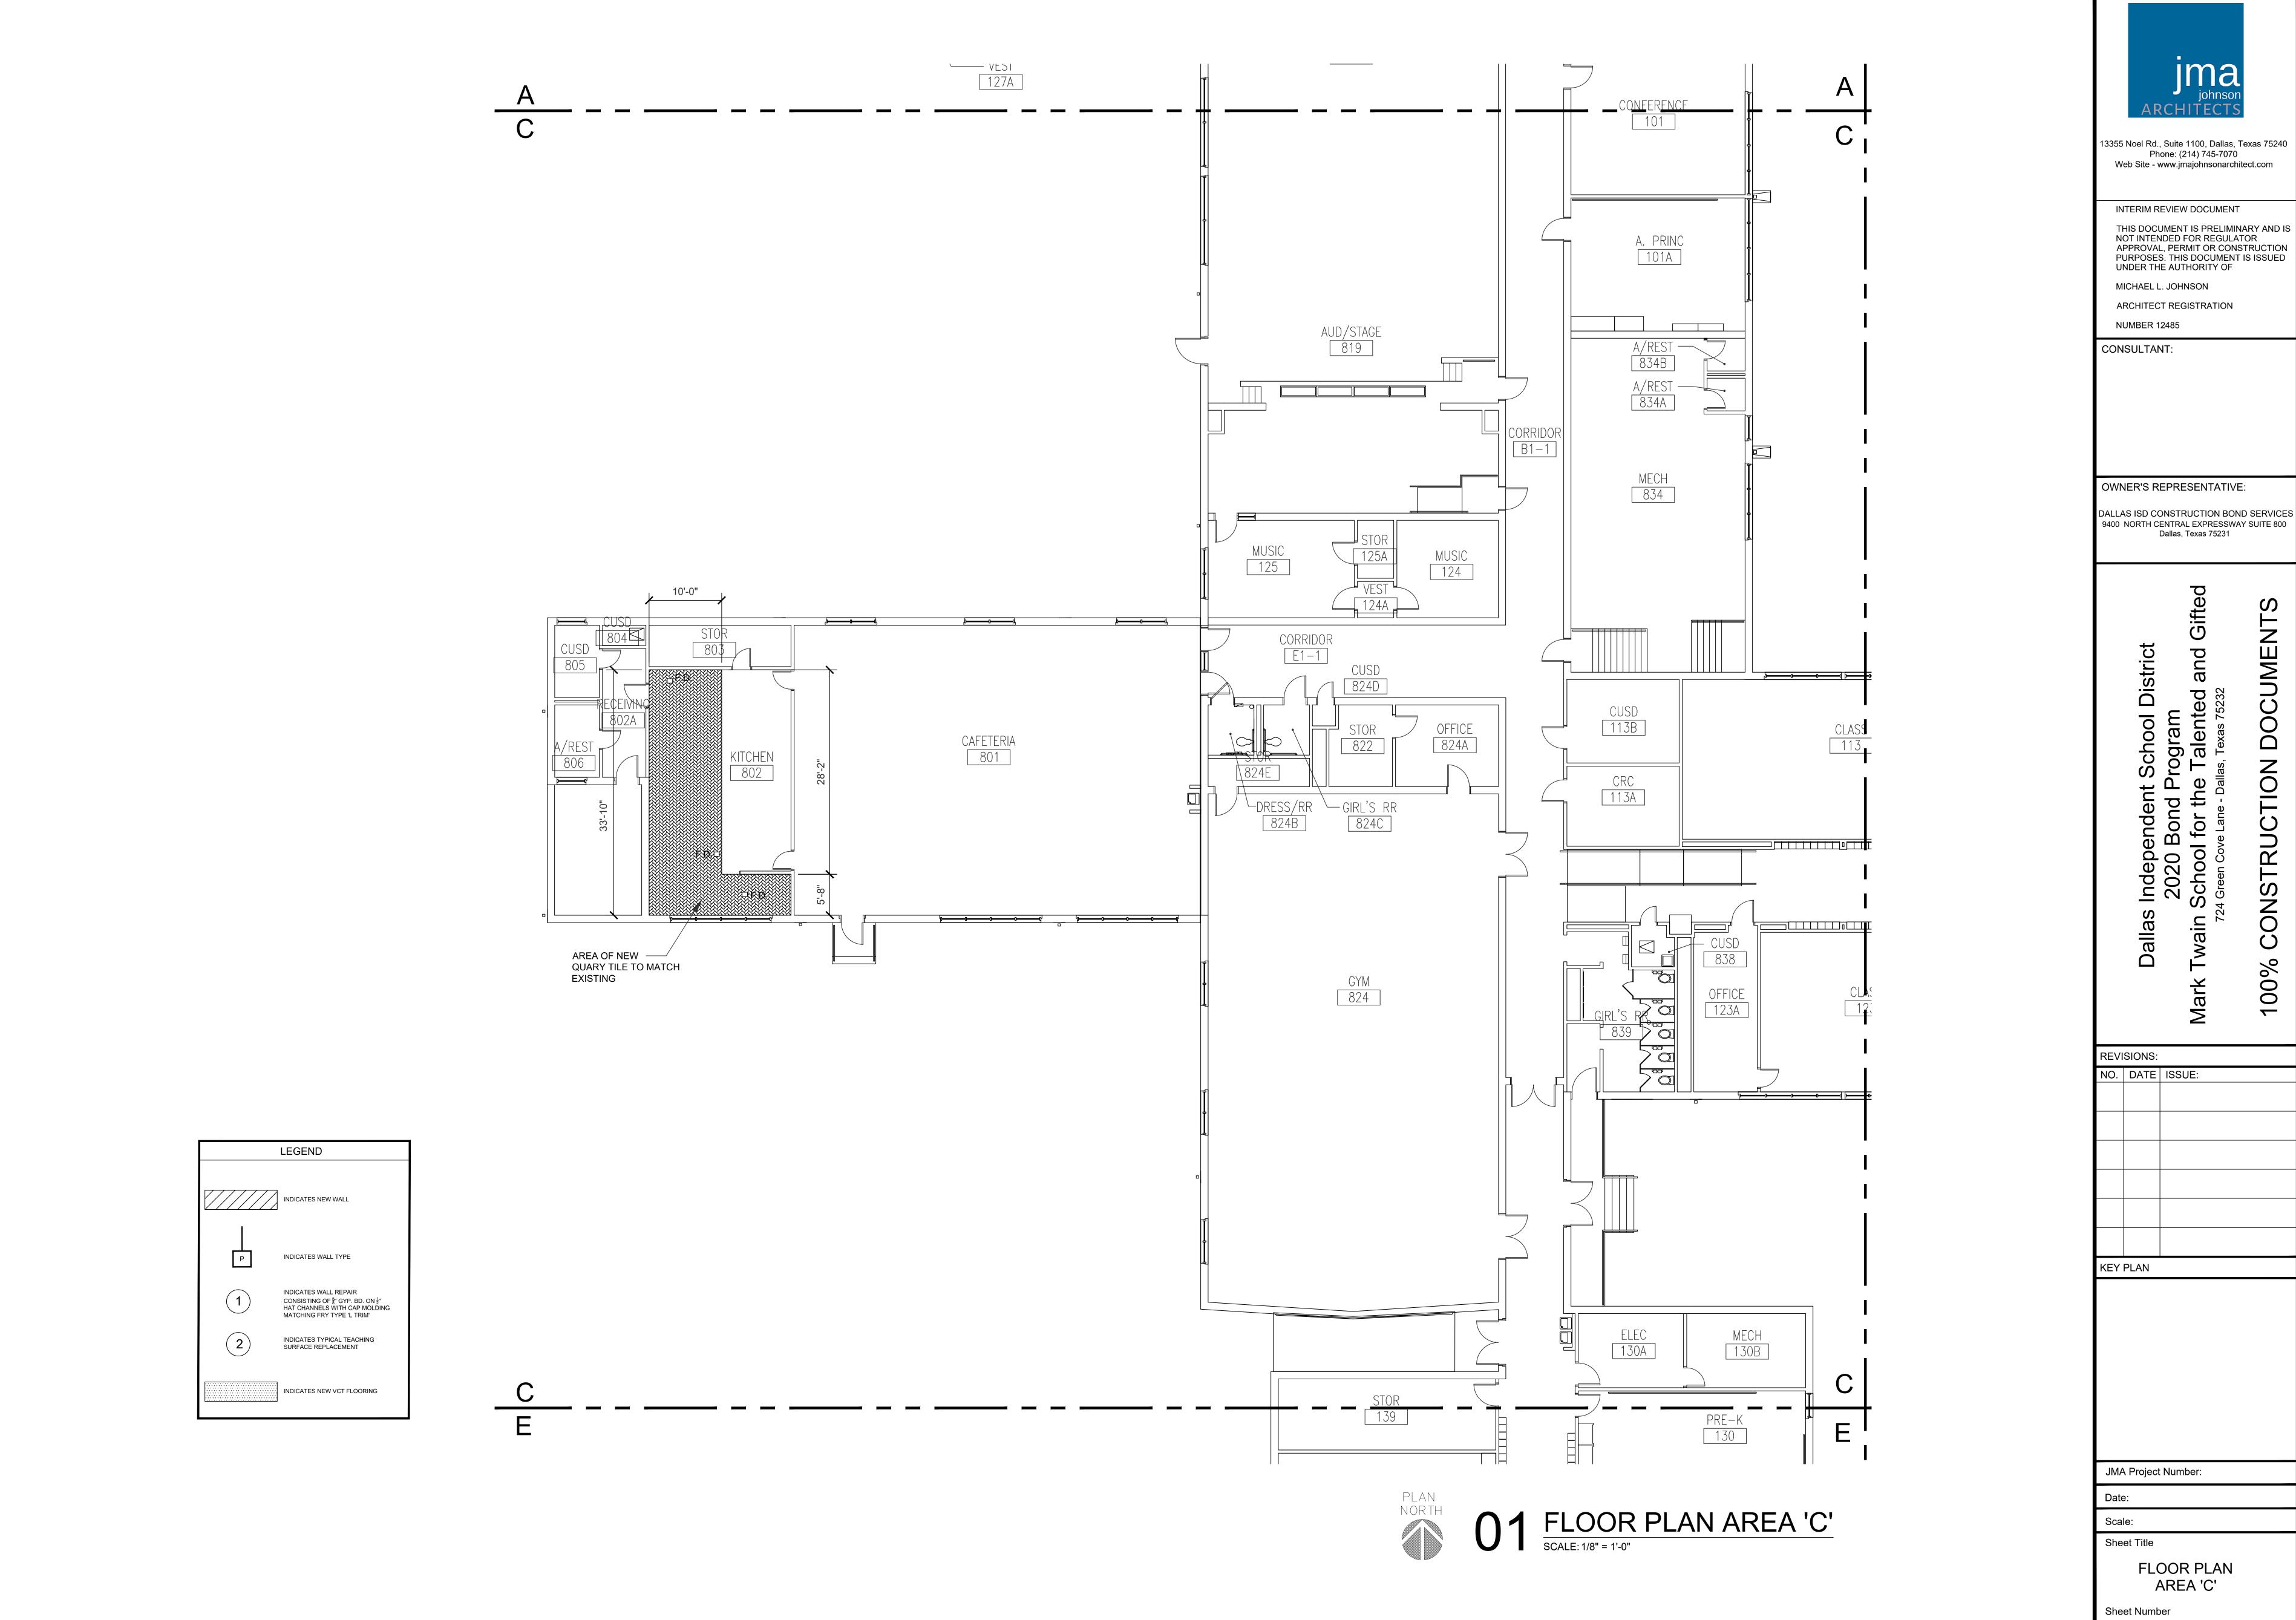


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AP103



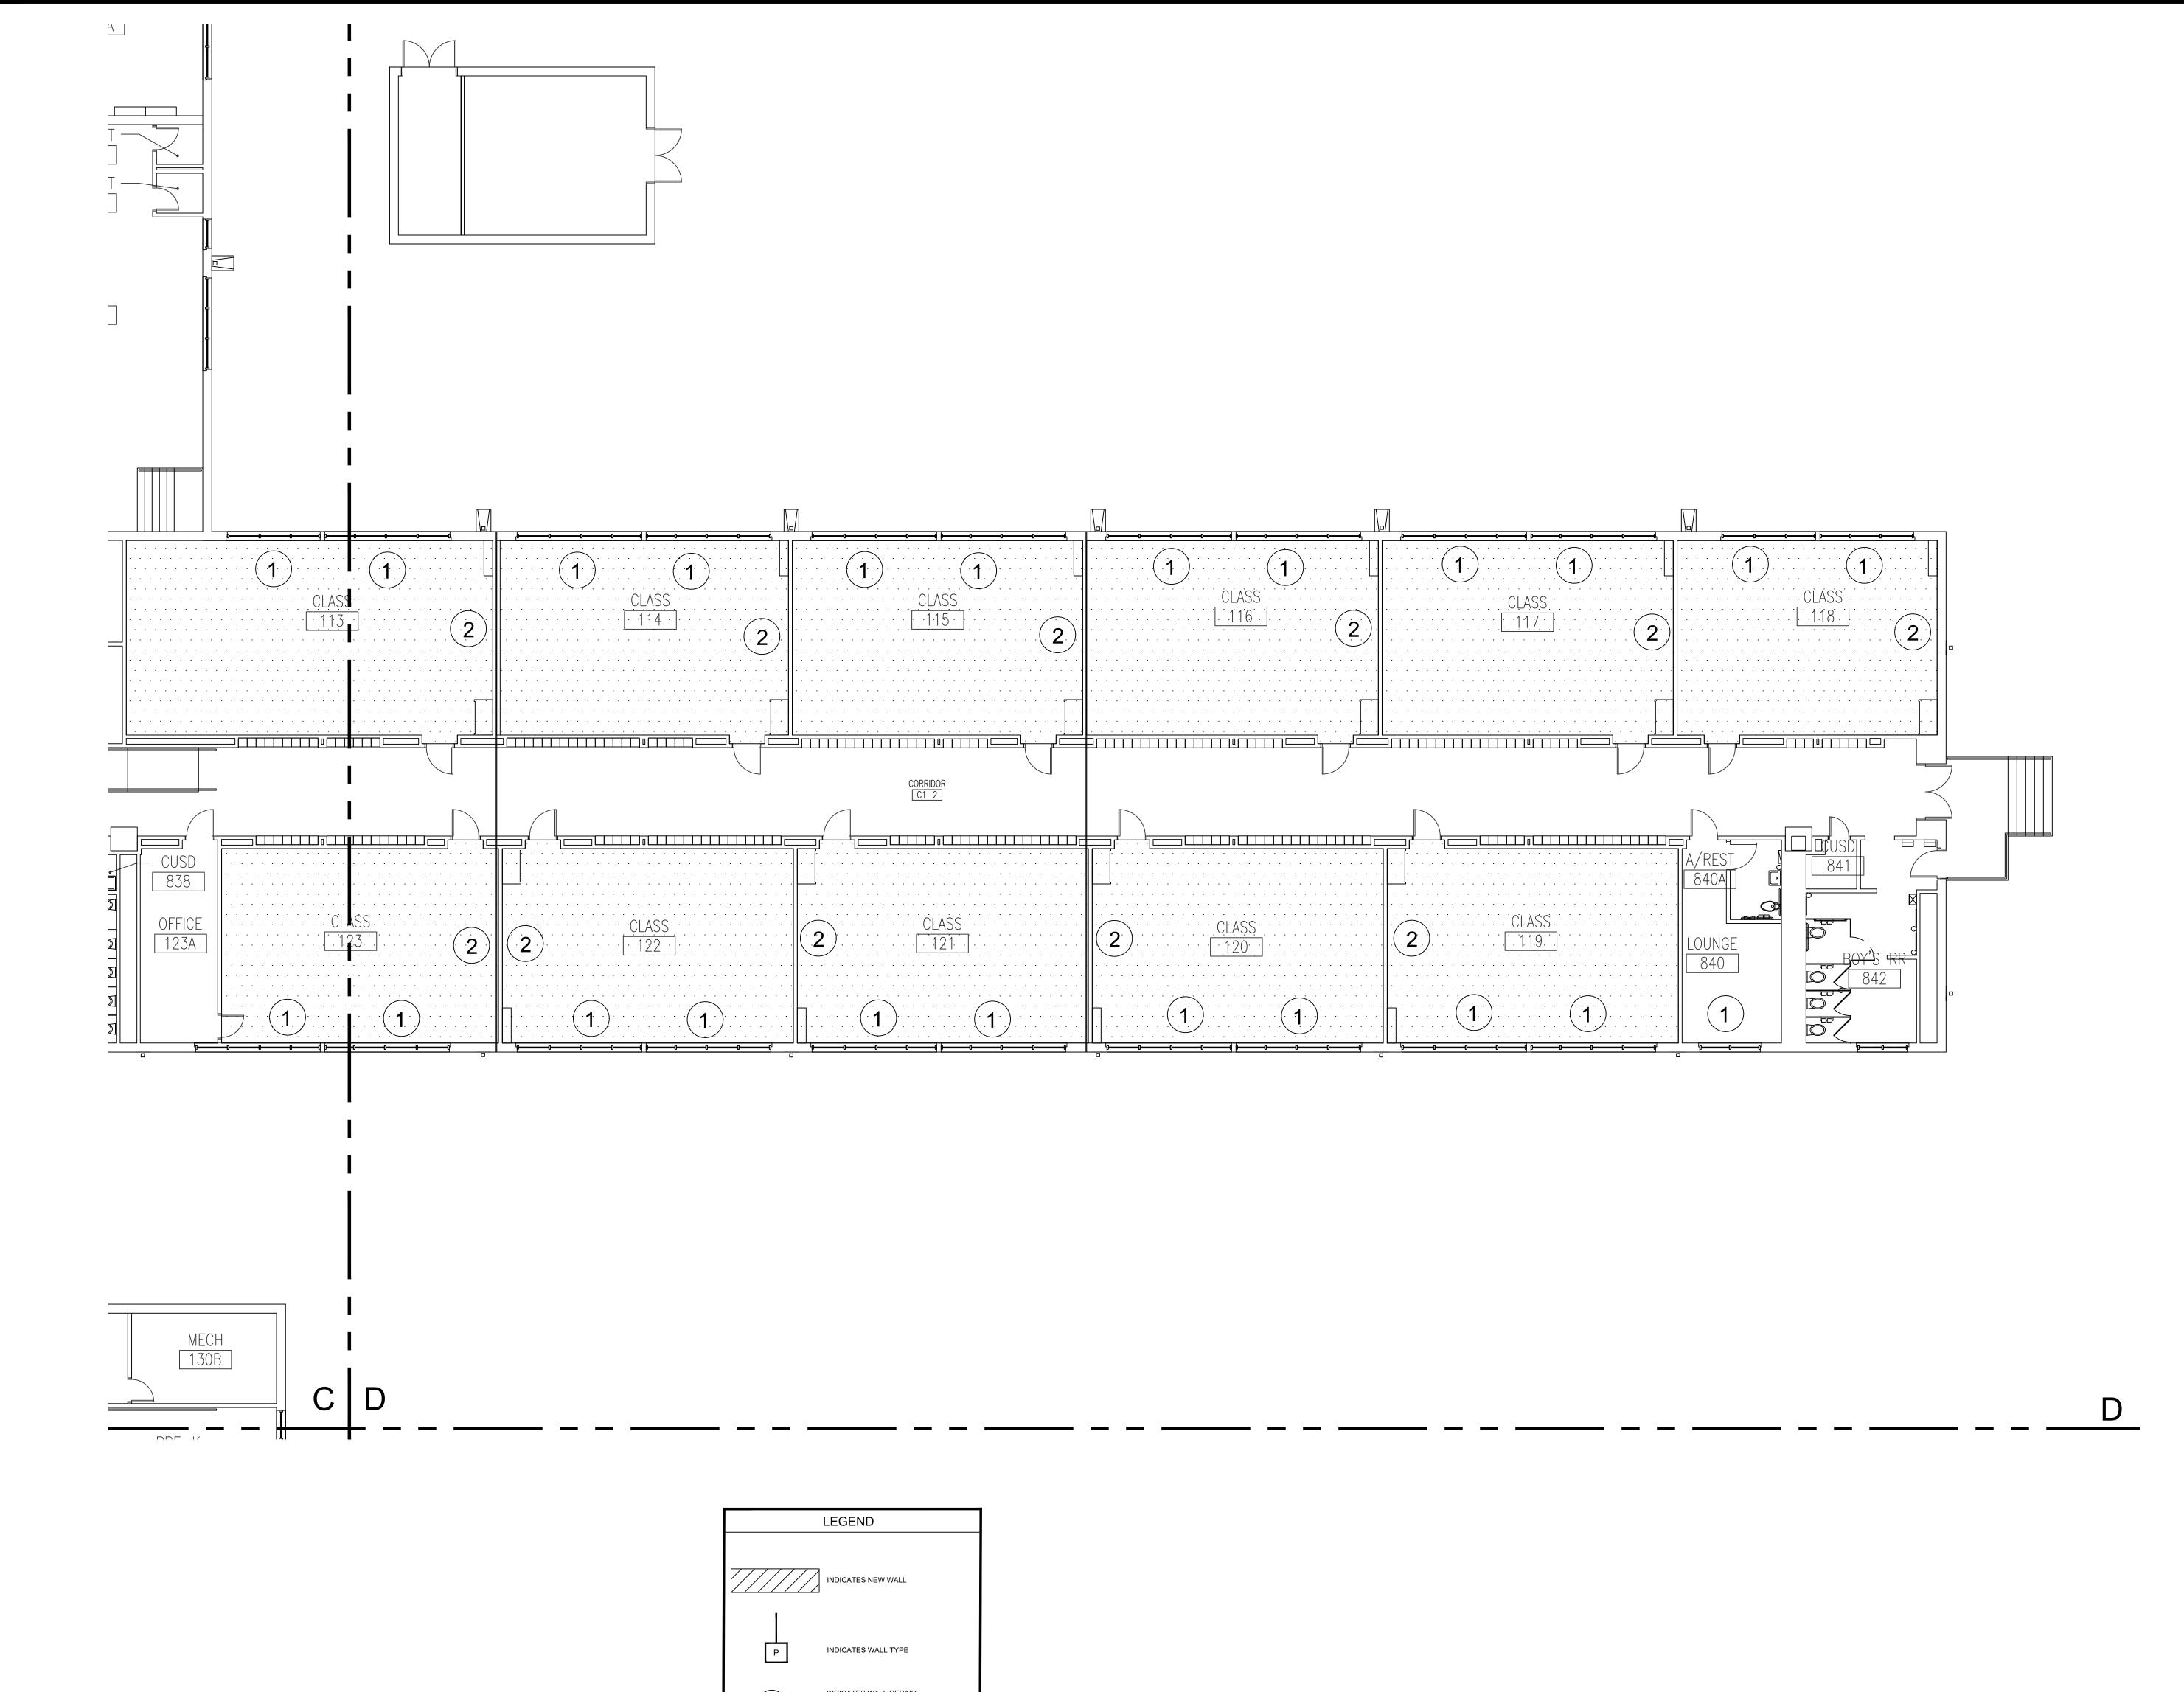

01 FLOOR PLAN AREA 'D'
SCALE: 1/8" = 1'-0"
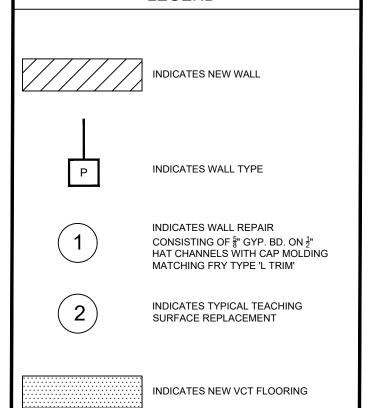
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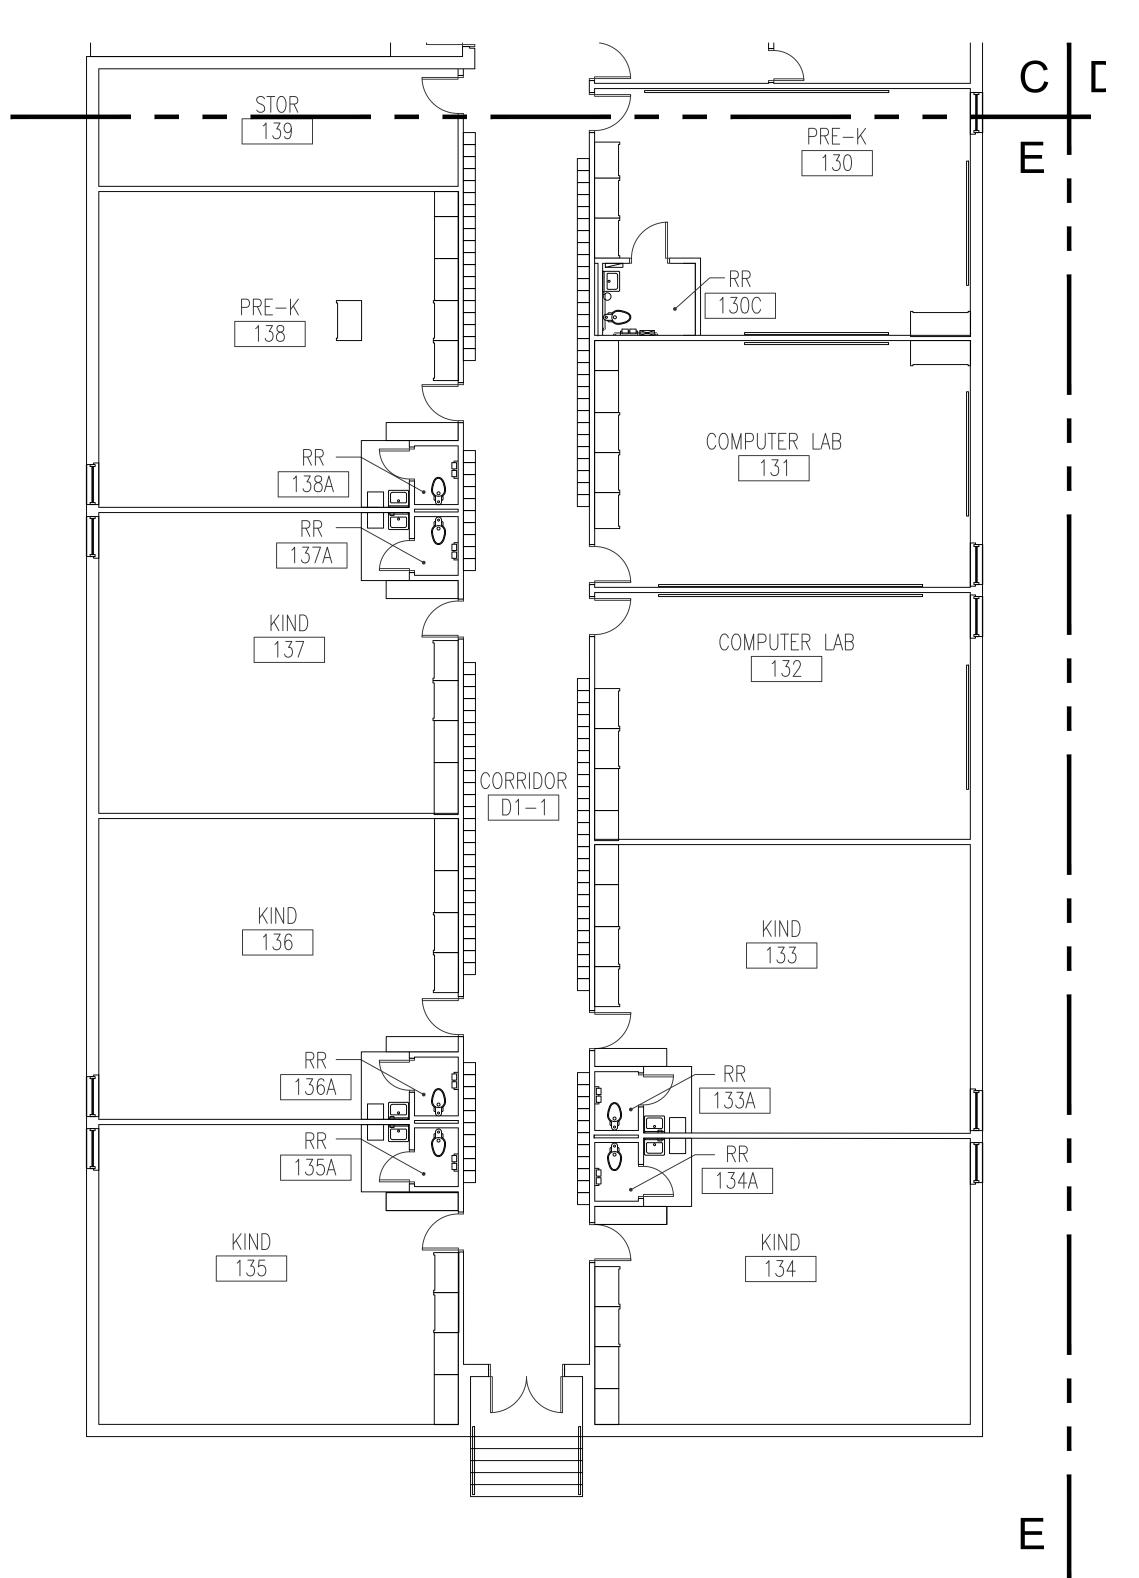
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> **FLOOR PLAN** AREA 'D'


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AP104

					OOM FINISI	1 SCHEDIII	F			
ROOM NO.	ROOM NAME	FLOORING TYPE	BASE TYPE	NORTH WALL	EAST WALL	SOUTH WALL	WEST WALL	CEILING TYPE	CEILING HEIGHT	REMARKS
SE100 SE101	VESTIBULE RECEPTION	VCT-1	V	PT-1 PT-1	PT-1 PT-1	PT-1 PT-1	PT-1 PT-1	ACT ACT	8'-10" 8'-10"	
SE102 SE103	PRINCIPAL CONFERENCE	CARPET	V	PT-1 PT-1	PT-1	PT-1 PT-1	PT-1	ACT ACT	8'-10" 8'-10"	
SE104 SE105	RESTROOM NURSE	VCT-1 CARPET	V	PT-1 PT-1	PT-1 PT-1	PT-1	PT-1	ACT ACT	8'-10" 8'-10"	
SE106 SE107 SE108	CLINIC RESTROOM ISOLATION	VCT-1 VCT-1 VCT-1	V V	PT-1 PT-1 PT-1	PT-1 PT-1 PT-1	PT-1 PT-1 PT-1	PT-1 PT-1 PT-1	ACT ACT ACT	8'-10" 8'-10" 8'-10"	
SE108	ISOLATION	VC1-1	V	F1-1	FI-I	F1-1	FI-I	ACT	6-10	
101 101A	CONFERENCE ASSISTANT PRINCIPAL	CARPET	EX EX	EX EX	EX EX	EX EX	EX EX	EX EX	8'-10" 8'-10"	
102 102A	MEDIA CENTER OFFICE	CARPET	EX EX	EX EX	EX EX	EX EX	EX EX	EX EX	8'-10" 8'-10"	
103 104	CLASSROOM CLASSROOM	VCT-1 VCT-1	EX EX	EX EX	EX EX	EX EX	EX EX	EX EX	8'-10" 8'-10"	
105 106	CLASSROOM CLASSROOM	VCT-1	EX EX	EX EX	EX EX	EX EX	EX EX	EX EX	8'-10" 8'-10"	
C1-1 107	CORRIDOR READ ROOM	VCT-1 VCT-1	EX EX	EX EX	EX EX	EX EX	EX EX	EX EX	8'-10" 8'-10"	
107A 107B	GIRLS RESTROOM CUSTODIAN	EX EX	EX EX	EX EX	EX EX	EX EX	EX EX	EX EX	8'-10" 8'-10"	
108	CLASSROOM CLASSROOM	VCT-1	EX EX	EX EX	EX EX	EX EX	EX EX	EX EX	8'-10" 8'-10"	
110	CLASSROOM CLASSROOM	VCT-1 VCT-1 EX	EX EX	EX EX EX	EX EX EX	EX EX EX	EX EX EX	EX EX EX	8'-10" 8'-10"	
111A 111B 111C	BOYS RESTROOM CUSTODIAN LOUNGE	EX CARPET	EX EX	EX EX	EX EX	EX EX	EX EX EX	EX EX	8'-10" 8'-10"	
111D 112	RESTROOM BOOK STORAGE	EX VCT-1	EX EX	EX EX	EX EX	EX EX	EX EX	EX EX	8'-10" 8'-10"	
LO2 LO3	LOBBY LOBBY	VCT-1 VCT-1	EX EX	EX EX	EX EX	EX EX	EX EX	EX EX	8'-10" 8'-10"	
A1-1 113	CORRIDOR CLASSROOM	VCT-1	EX EX	EX EX	EX EX	EX EX	EX EX	EX EX	8'-10" 8'-10"	
113A 113B	CRC CUSTODIAN	VCT-1	EX EX	EX EX	EX EX	EX EX	EX EX	EX EX	8'-10" 8'-10"	
114 115	CLASSROOM CLASSROOM	VCT-1 VCT-1	EX EX	EX EX	EX EX	EX EX	EX EX	EX EX	8'-10" 8'-10"	
116 117	CLASSROOM CLASSROOM	VCT-1 VCT-1	EX EX	EX EX	EX EX	EX EX	EX EX	EX EX	8'-10" 8'-10"	
118 C1-2	CLASSROOM CORRIDOR	VCT-1	EX EX	EX EX	EX EX	EX EX	EX EX	EX EX	8'-10" 8'-10"	
119 120	CLASSROOM CLASSROOM	VCT-1	EX EX	EX EX	EX EX	EX EX	EX EX	EX EX	8'-10" 8'-10"	
121	CLASSROOM CLASSROOM	VCT-1	EX EX	EX EX	EX EX	EX EX	EX EX	EX EX EX	8'-10" 8'-10"	
123 123A 124	CLASSROOM OFFICE MUSIC	VCT-1 VCT-1 VCT-1	EX EX	EX EX EX	EX EX EX	EX EX EX	EX EX EX	EX EX	8'-10" 8'-10"	
124A 125	VESTIBULE MUSIC	VCT-1 VCT-1	EX EX	EX EX	EX EX	EX EX	EX EX	EX EX	8'-10" 8'-10"	
125A 126	STORAGE CLASSROOM	EX VCT-1	EX EX	EX EX	EX EX	EX EX	EX EX	EX EX	8'-10" 8'-10"	
126A 126B	VESTIBULE RESTROOM	VCT-1	EX EX	EX EX	EX EX	EX EX	EX EX	EX EX	8'-10" 8'-10"	
127 127A	CLASSROOM VESTIBULE	VCT-1 VCT-1	EX EX	EX EX	EX EX	EX EX	EX EX	EX EX	8'-10" 8'-10"	
127B 128	RESTROOM CLASSROOM	EX VCT-1	EX EX	EX EX	EX EX	EX EX	EX EX	EX EX	8'-10" 8'-10"	
128A 128B	VESTIBULE RESTROOM	VCT-1 EX	EX EX	EX EX	EX EX	EX EX	EX EX	EX EX	8'-10" 8'-10"	
B1-1 130	CORRIDOR PRE-K	VCT-1	EX EX	EX EX	EX EX	EX EX	EX EX	EX EX	8'-10" 8'-10"	
130A 130B	ELECTRICAL MECHANICAL	EX EX	EX EX	EX EX	EX EX	EX EX	EX EX	EX EX	8'-10" 8'-10"	
130C 131	RESTROOM COMPUTER LAB	VCT-1	EX EX	EX EX	EX EX	EX EX	EX EX	EX EX	8'-10" 8'-10"	
132	COMPUTER LAB KINDERGARTEN	VCT-1 VCT-1 EX	EX EX	EX EX EX	EX EX EX	EX EX EX	EX EX EX	EX EX EX	8'-10" 8'-10"	
133A 134 134A	RESTROOM KINDERGARTEN RESTROOM	VCT-1	EX EX	EX EX	EX EX	EX EX	EX EX	EX EX	8'-10" 8'-10"	
135 135A	KINDERGARTEN RESTROOM	VCT-1	EX EX	EX EX	EX EX	EX EX	EX EX	EX EX	8'-10" 8'-10"	
136 135A	KINDERGARTEN RESTROOM	VCT-1	EX EX	EX EX	EX EX	EX EX	EX EX	EX EX	8'-10" 8'-10"	
137 137A	KINDERGARTEN RESTROOM	VCT-1	EX EX	EX EX	EX EX	EX EX	EX EX	EX EX	8'-10" 8'-10"	
138 138A	PRE-K RESTROOM	VCT-1 EX	EX EX	EX EX	EX EX	EX EX	EX EX	EX EX	8'-10" 8'-10"	
139 801	STORAGE CAFETERIA	EX VCT-1	EX EX	EX EX	EX EX	EX EX	EX EX	EX EX	8'-10" 8'-10"	
802 802A	KITCHEN RECEIVING	EX EX	EX EX	EX EX	EX EX	EX EX	EX EX	EX EX	8'-10" 8'-10"	
803 804	STORAGE CUSTODIAN	EX EX	EX EX	EX EX	EX EX	EX EX	EX EX	EX EX	8'-10" 8'-10"	
805 806	CUSTODIAN RESTROOM	EX EX	EX EX	EX EX	EX EX	EX EX	EX EX	EX EX	8'-10" 8'-10"	
818 819	AUDITORIUM STAGE STORAGE	EX EX	EX EX	EX EX	EX EX	EX EX	EX EX	EX EX FX	8'-10"	
822 824 824A	STORAGE GYMNASIUM OFFICE	EX EX	EX EX	EX EX EX	EX EX EX	EX EX EX	EX EX EX	EX EX EX	8'-10" EX 8'-10"	
824A 824B 824C	OFFICE DRESS / RR GIRLS RESTROOM	EX EX	EX EX	EX EX	EX EX EX	EX EX	EX EX	EX EX EX	8'-10" 8'-10" 8'-10"	
824C 824D 824E	CUSTODIAN STORAGE	EX EX	EX EX	EX EX	EX EX	EX EX	EX EX	EX EX	8'-10" 8'-10"	
834 834A	MECHANICAL RESTROOM	EX EX	EX EX	EX EX	EX EX	EX EX	EX EX	EX EX	8'-10" 8'-10"	
834B 838	RESTROOM CUSTODIAN	EX EX	EX EX	EX EX	EX EX	EX EX	EX EX	EX EX	8'-10" 8'-10"	
839 840	GIRLS RESTROOM LOUNGE	EX CARPET	EX EX	EX EX	EX EX	EX EX	EX EX	EX EX	8'-10" 8'-10"	
840A 841	RESTROOM CUSTODIAN	EX EX	EX EX	EX EX	EX EX	EX EX	EX EX	EX EX	8'-10" 8'-10"	
842	BOYS RESTROOM	EX	EX	EX	EX	EX	EX	EX	8'-10"	
	MATERIAL LEGEND:									
VCT- 1	VINYL COMPOSITION FLOOR TILE 12" x 12" Armstrong 51899 Cool White (Field Color) Armstrong 51821 Caribbean Blue (Accept)									
VCT- 2	Armstrong 51821 Caribbean Blue (Accent)									
CPT- 1	CARPET Mohawk Group Datum -color 7559 Opal									
	Bending Earth Collection size24"x 24"									
V	Base Armstrong Company									
	4in. Wall Coved: Color Ebony									
	PAINT ShermanWilliams PROMar 200 Latex									
PT - 1 EX	SemiGloss #Koo3OW227 - 1Soft Sesamea Existing Material Finish to Remain							1		





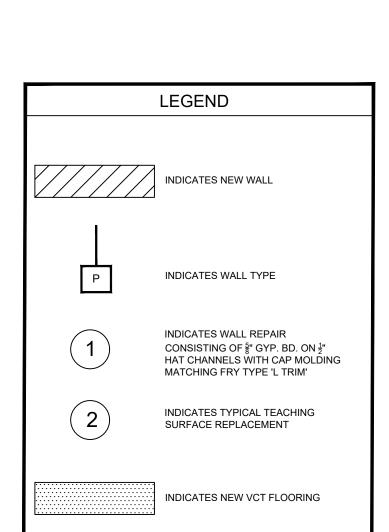

ARCHITECT:

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OWNER'S REPRESENTATIVE:

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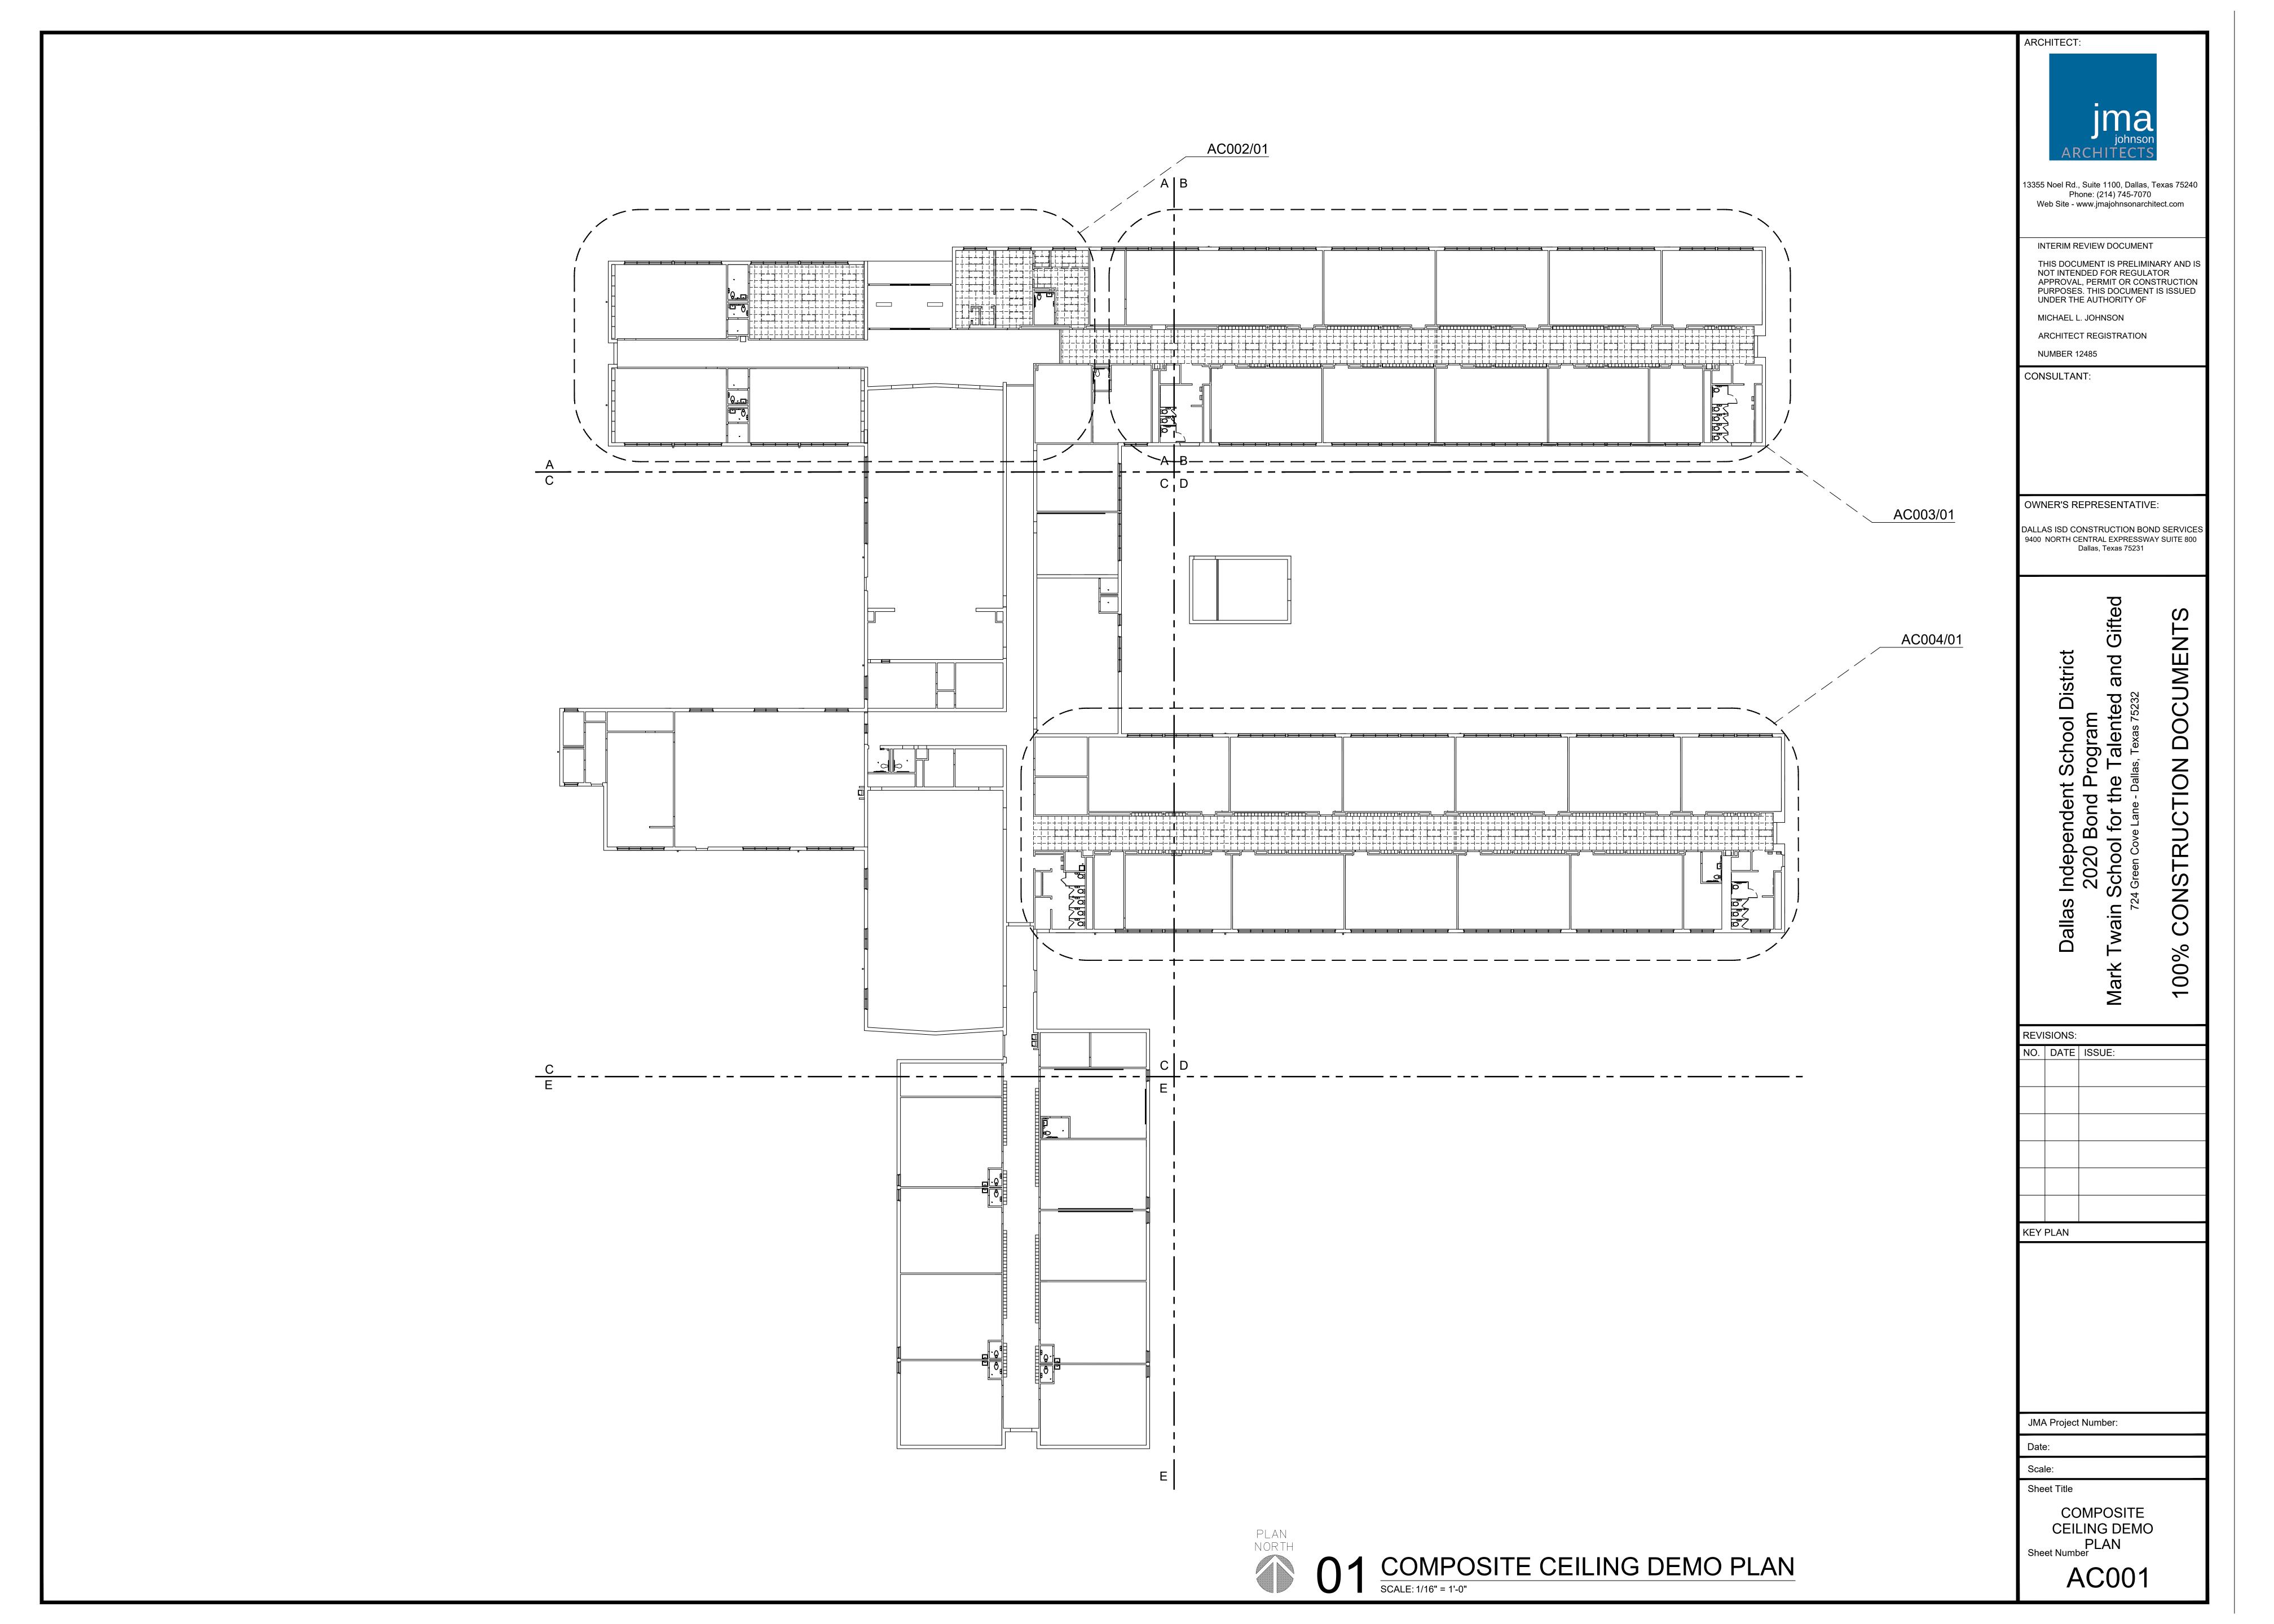
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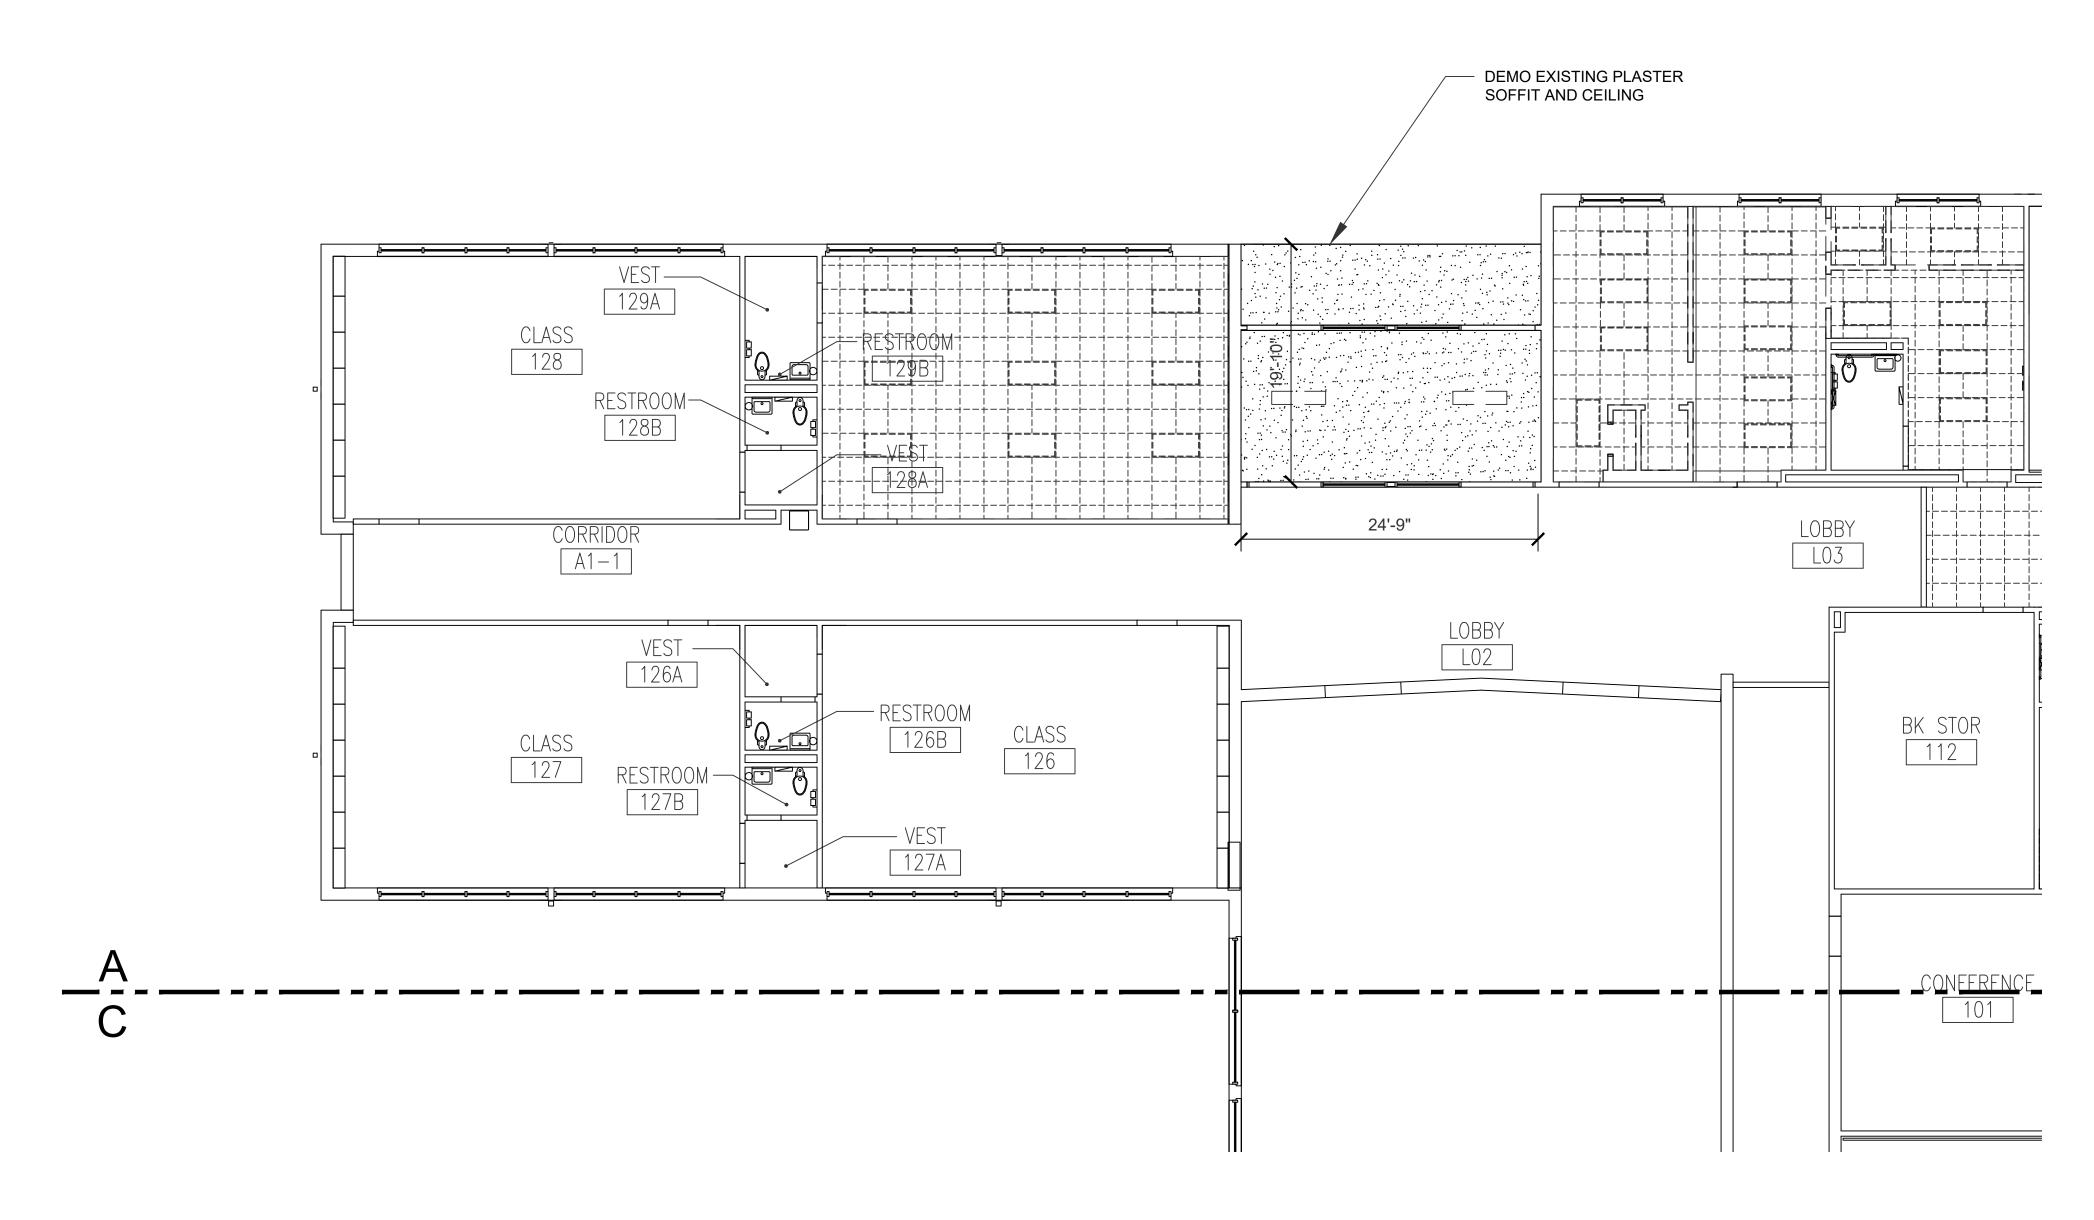
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FLOOR PLAN AREA 'E'


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PLAN NORTH

O1 CEILING DEMO PLAN AREA 'A'
SCALE: 1/8" = 1'-0"



GENERAL NOTE:

- 1. CONTRACTOR SHALL RE-ORIENT SPRINKLER HEADS TO BE BELOW NEW CEILING TILE.
- 2. AREAS THAT SHOW NO DEMOLITION PATTERNS INDICATE NO CEILING DEMOLITION WORK TO BE PERFORMED. U.N.O.
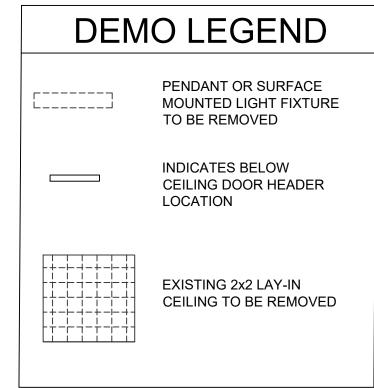
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wain School for the Talented and Gifted


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Sheet Title

CEILING DEMO
PLAN
AREA 'A'
Sheet Number





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Dallas Independent School District 2020 Bond Program Mark Twain School for the Talented and
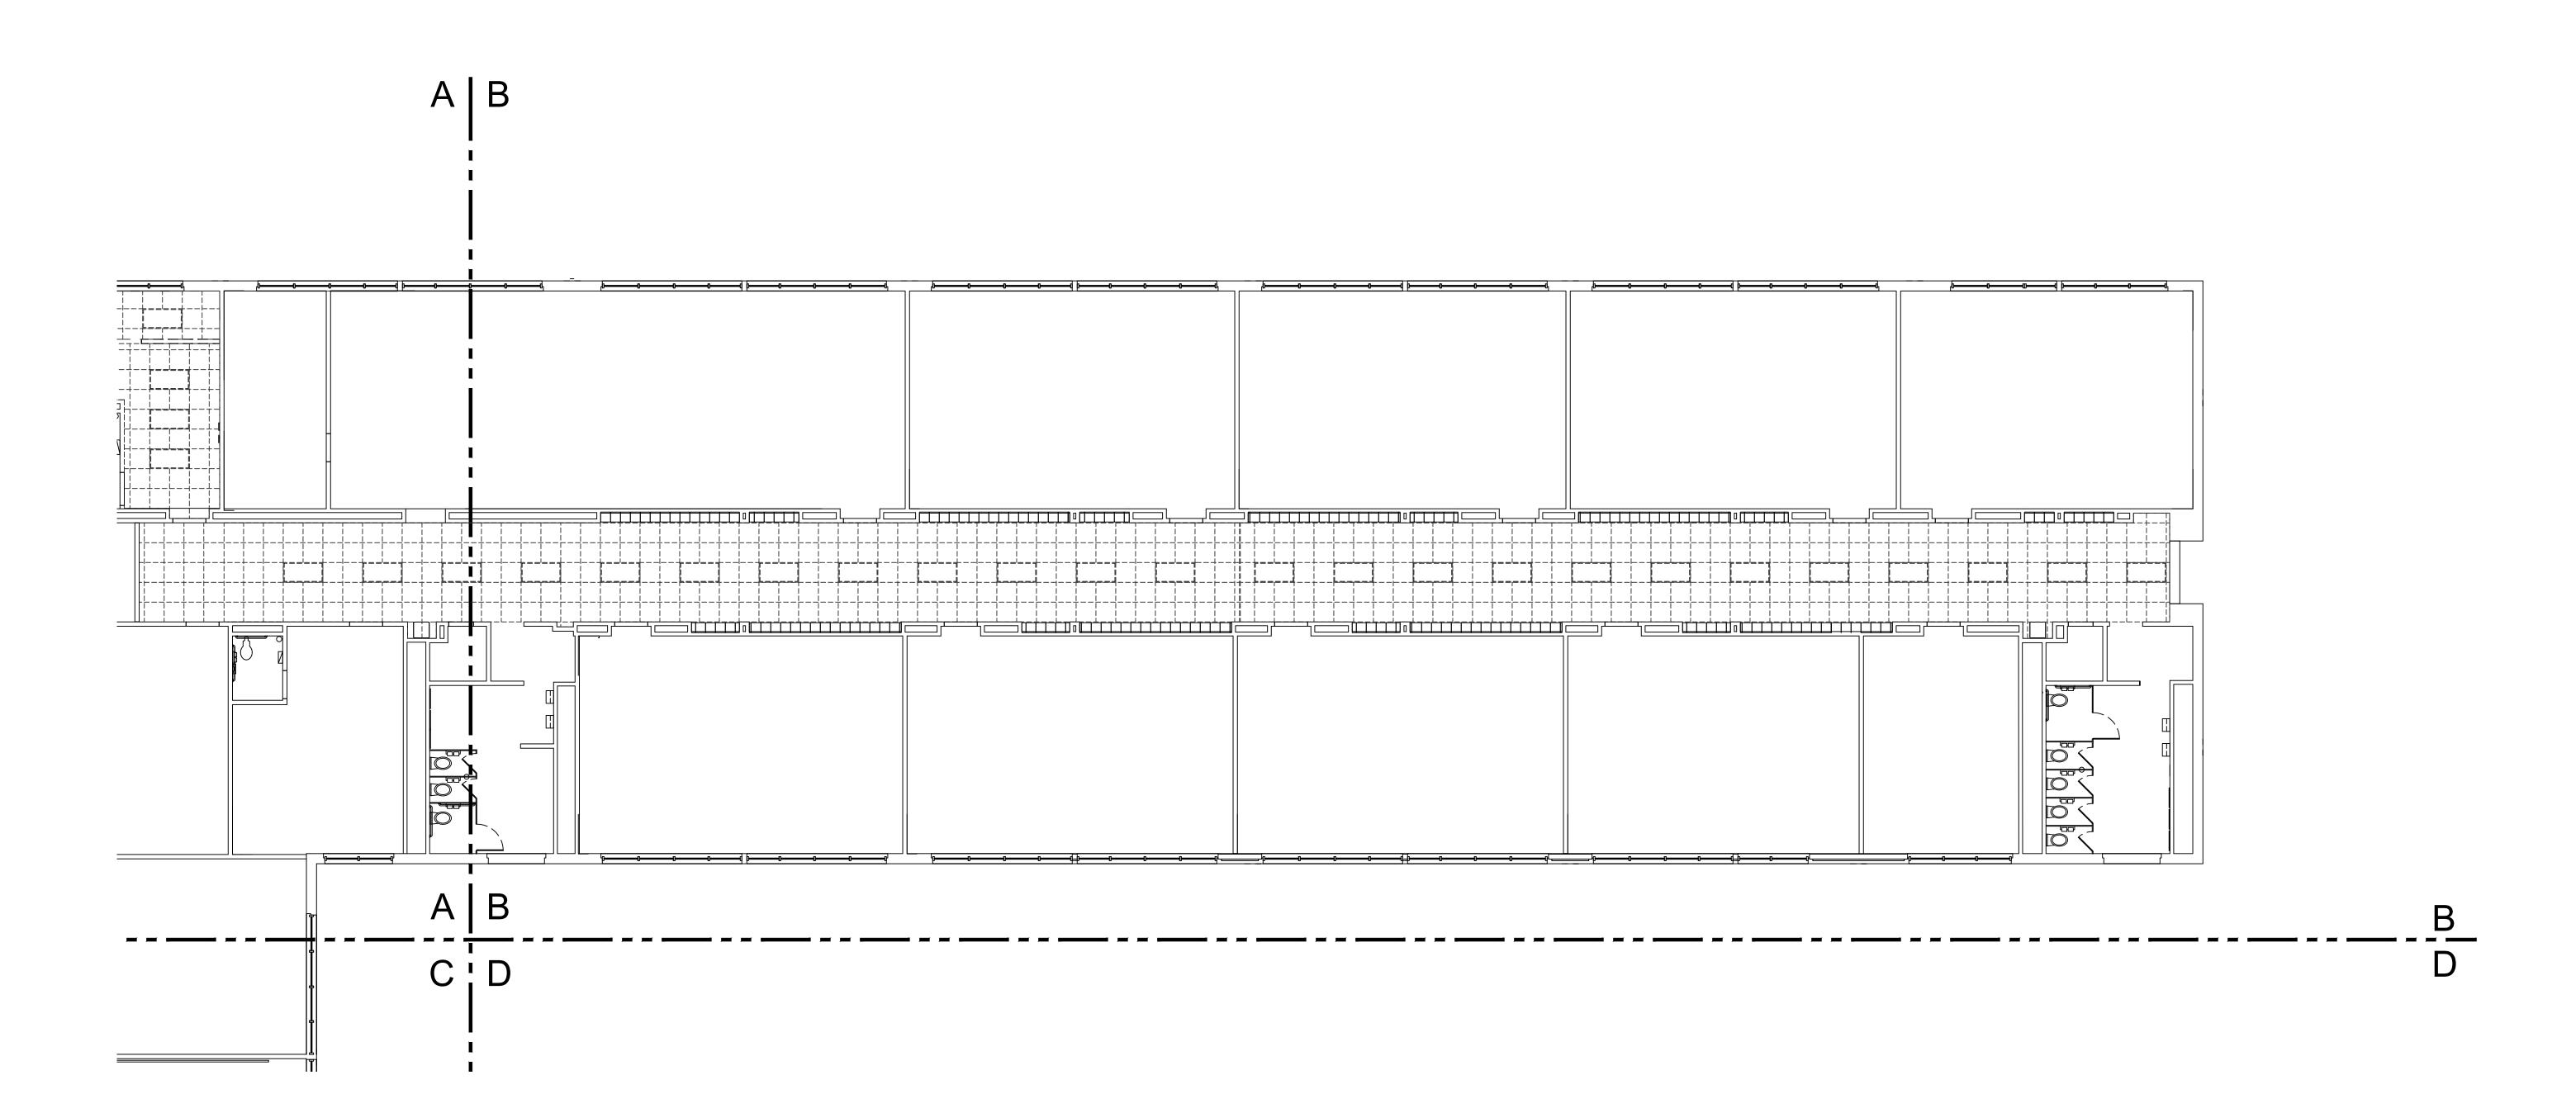
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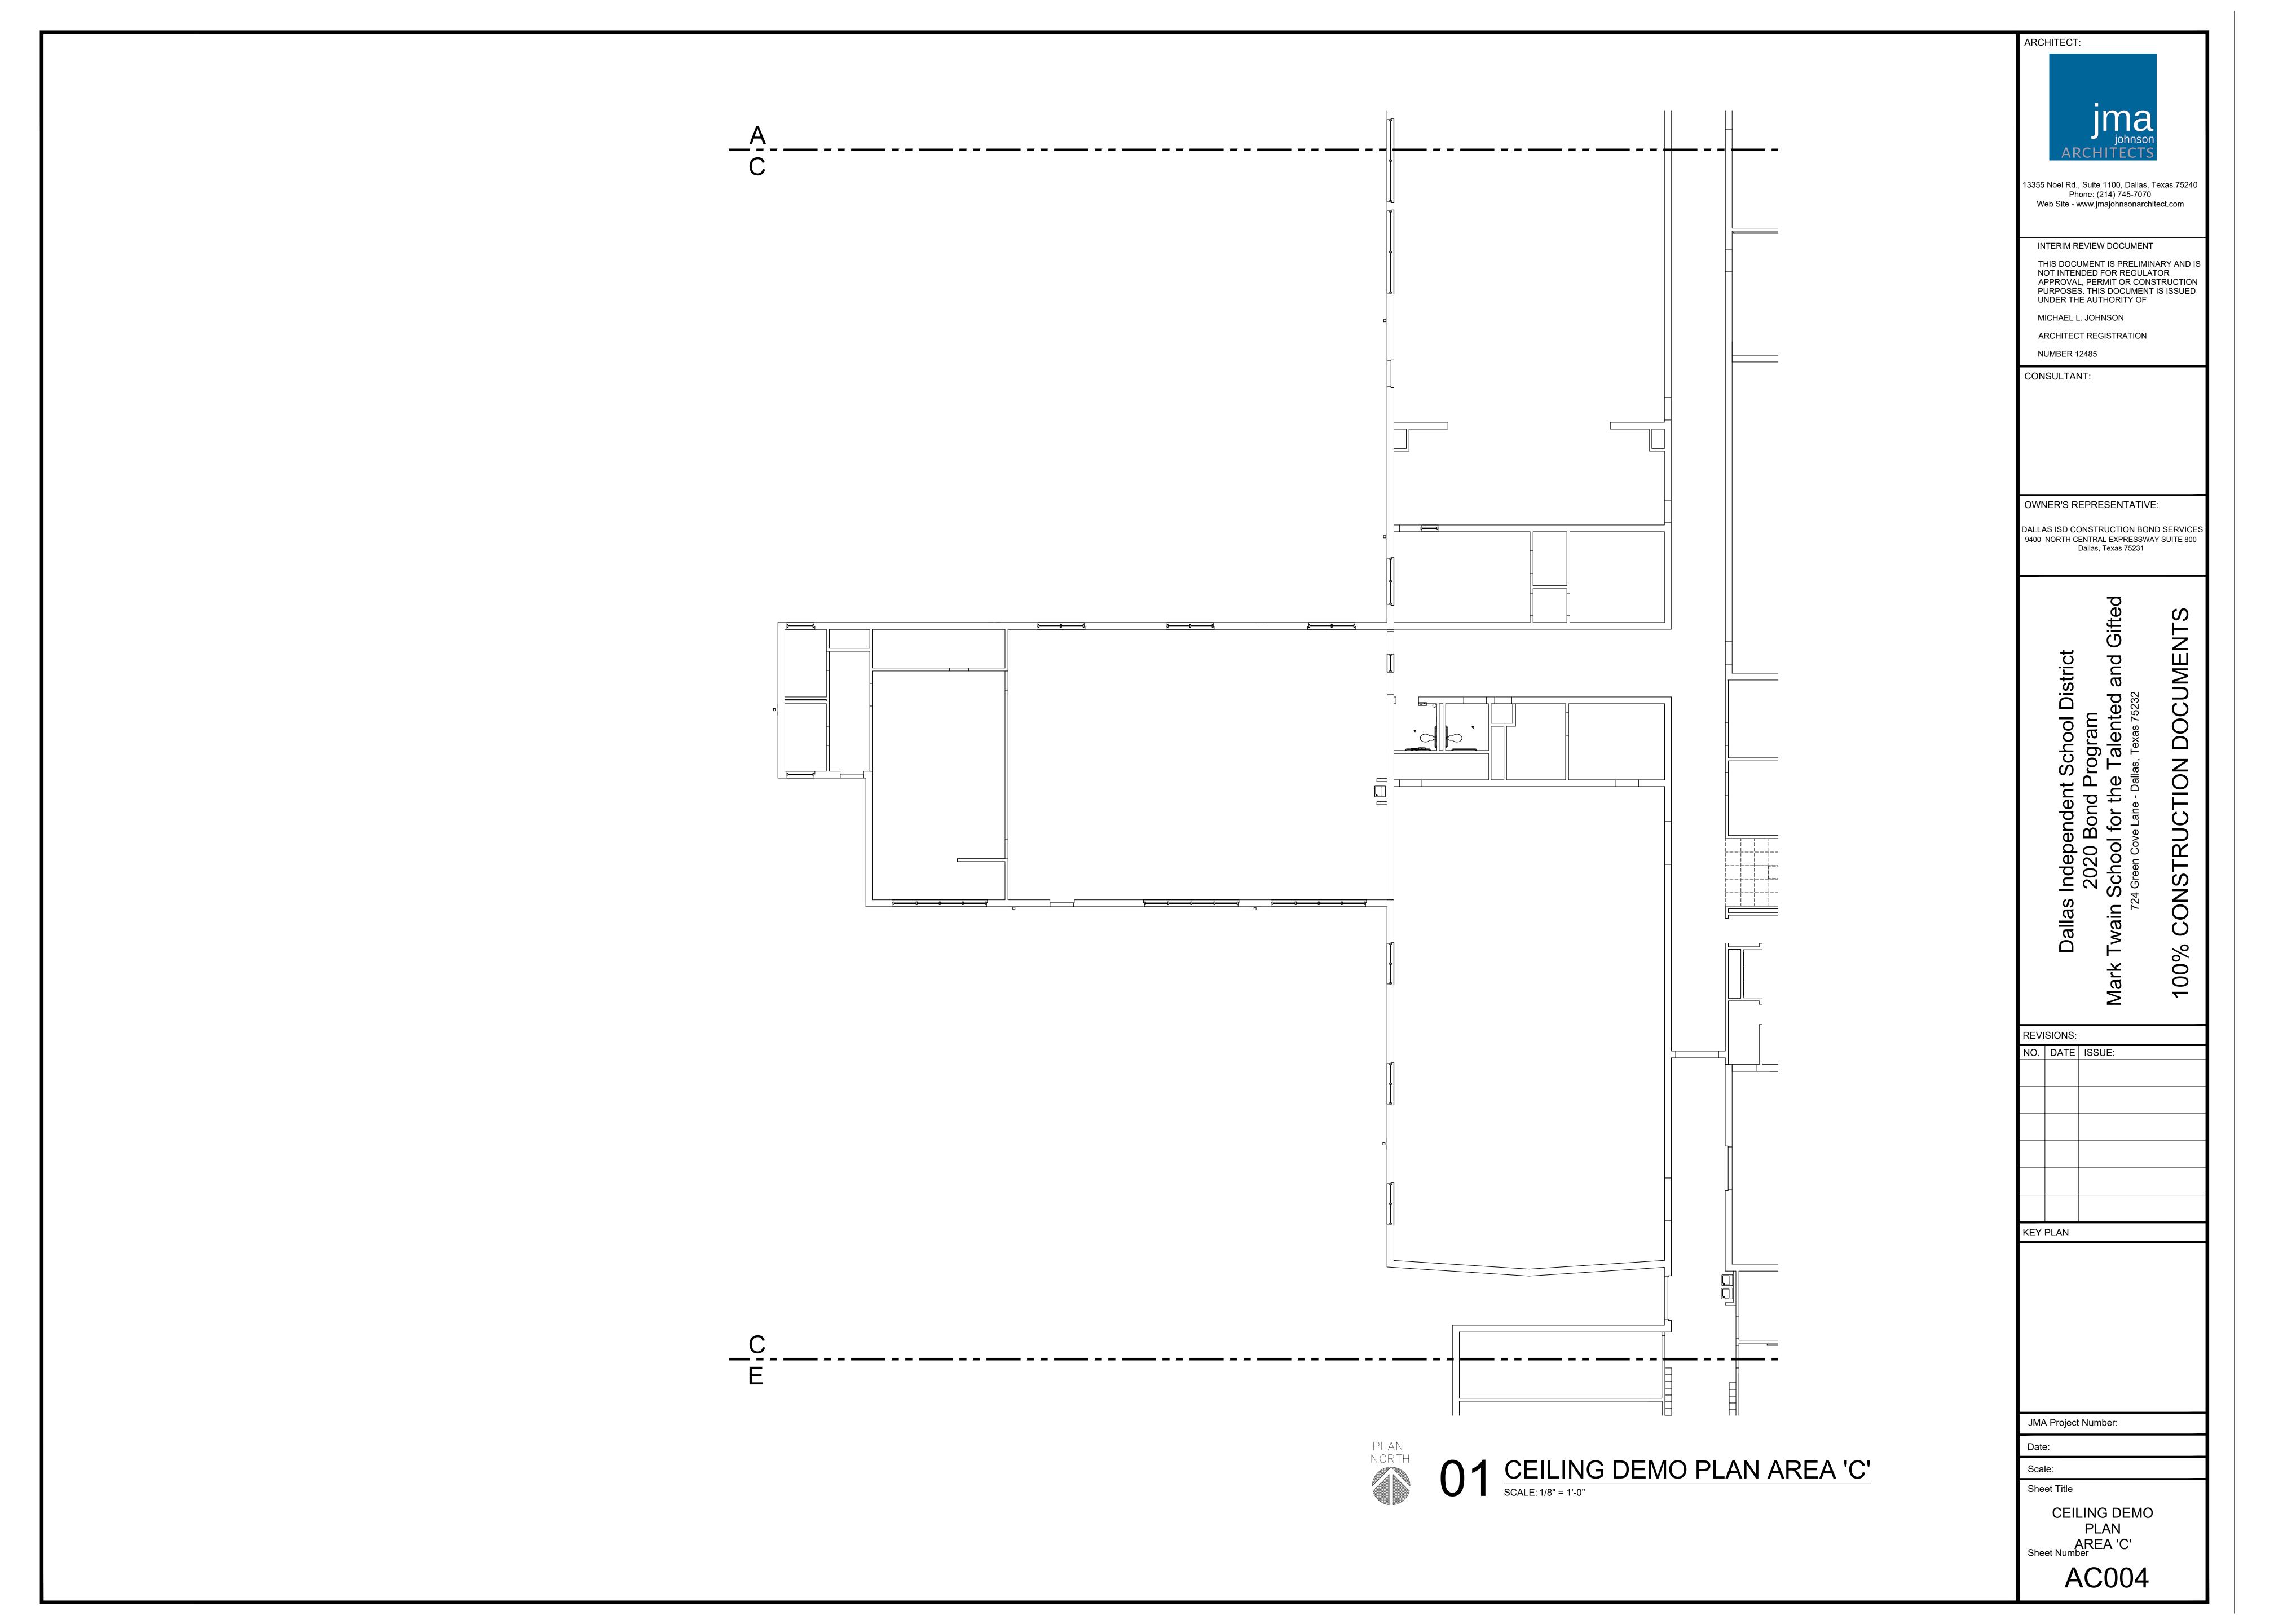
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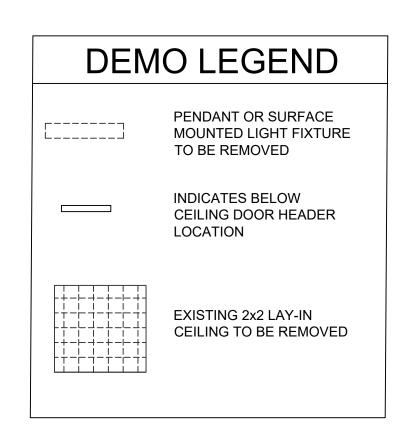
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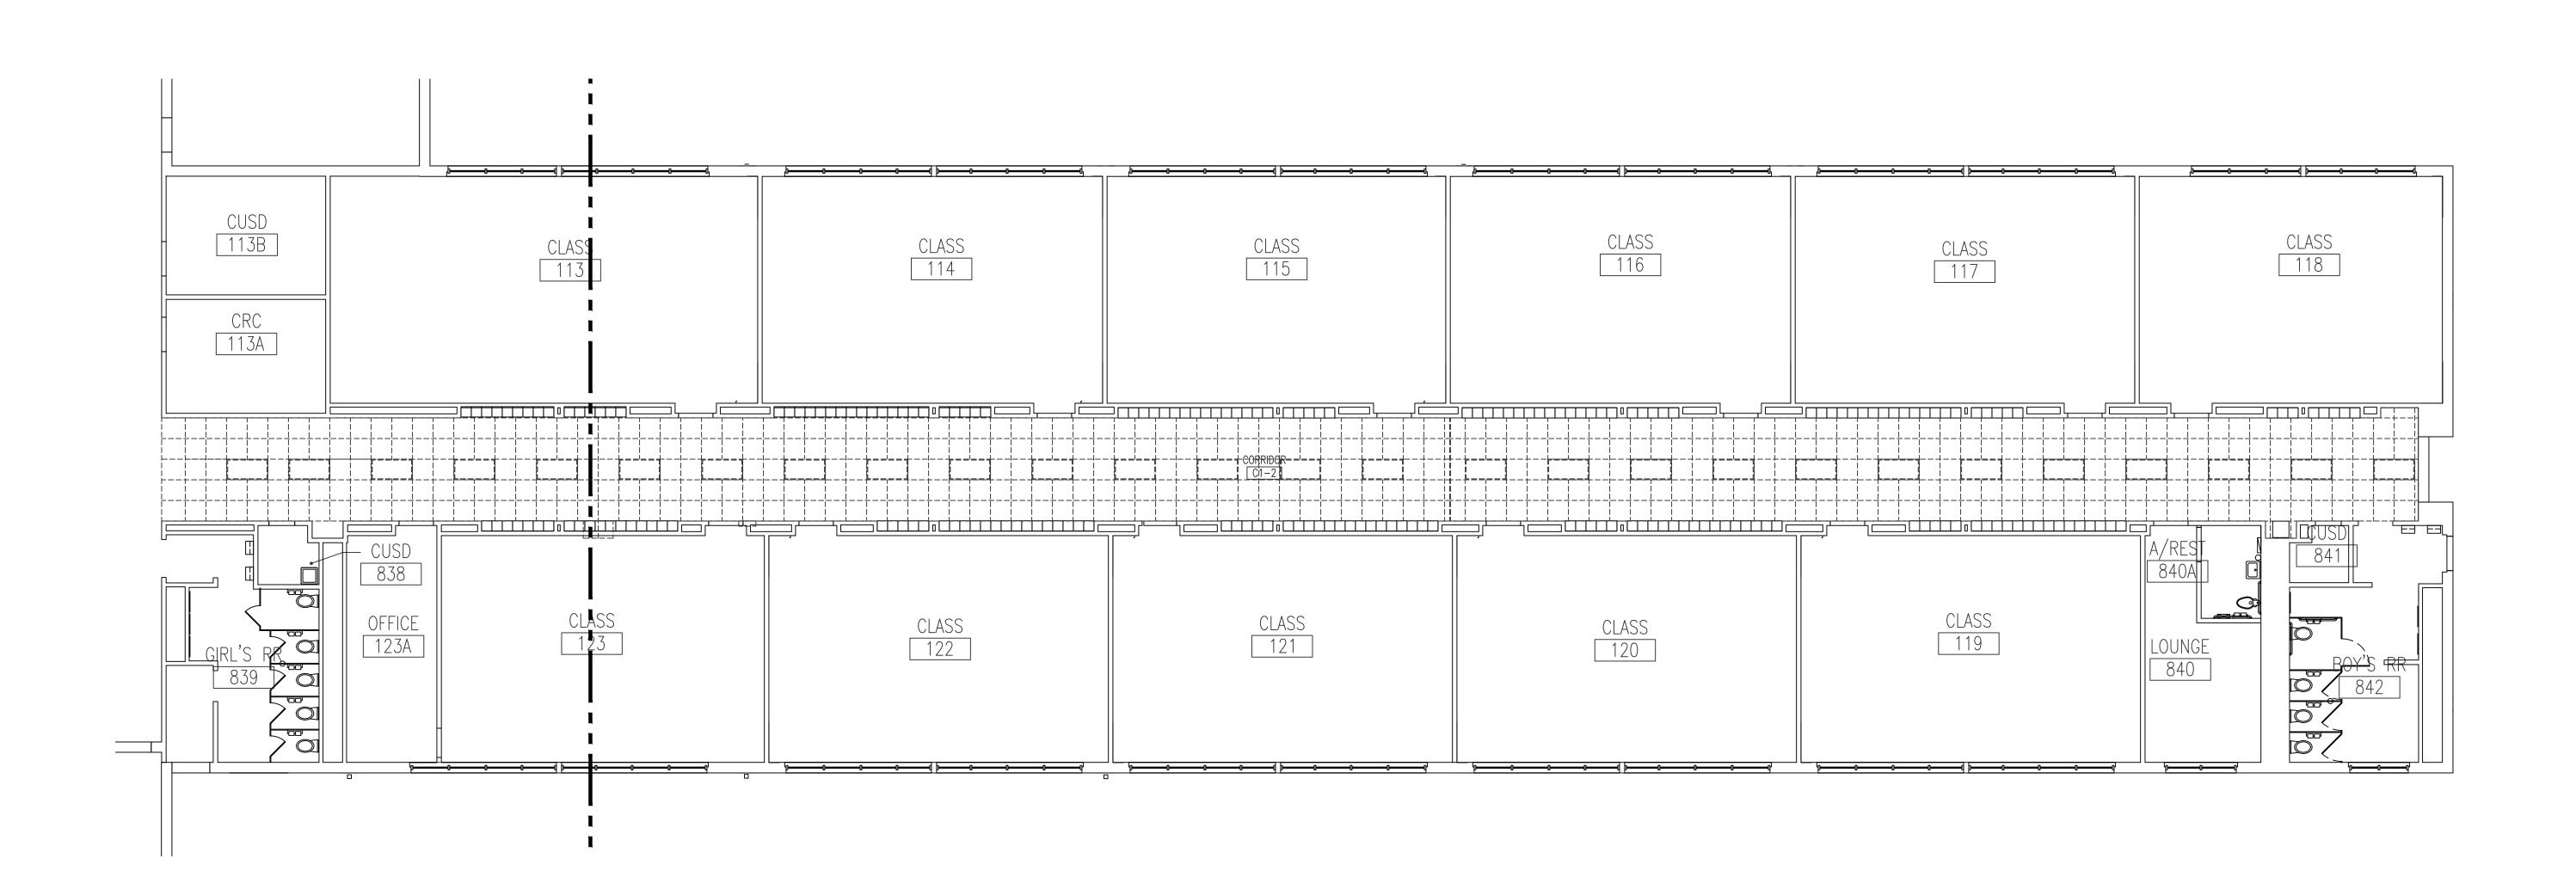
CEILING DEMO
PLAN
AREA 'B'

Sheet Number





- 1. CONTRACTOR SHALL RE-ORIENT SPRINKLER HEADS TO BE BELOW NEW CEILING TILE.
- 2. AREAS THAT SHOW NO DEMOLITION PATTERNS INDICATE NO CEILING DEMOLITION WORK TO BE PERFORMED. U.N.O.





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Dallas, Texas 75232
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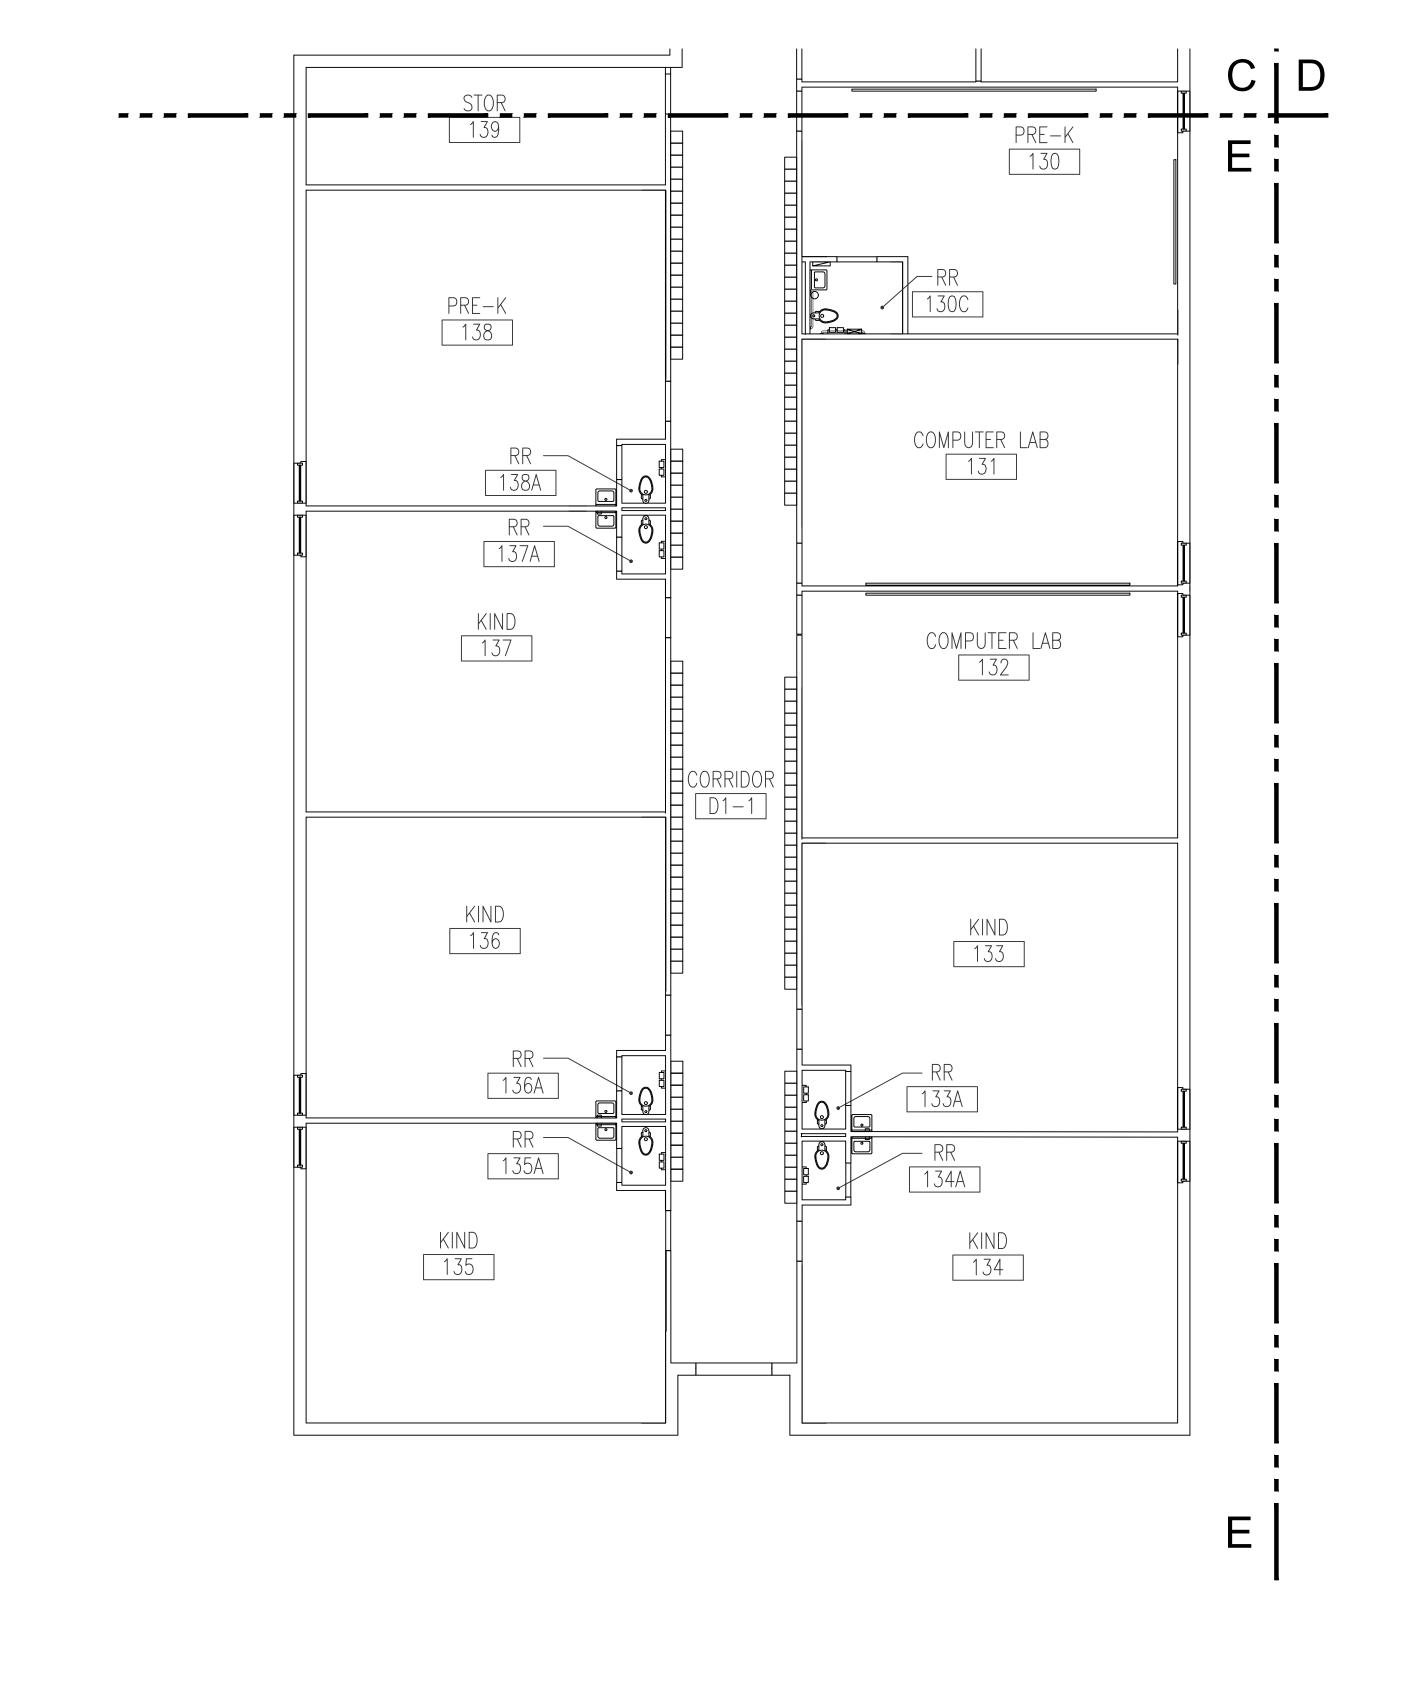
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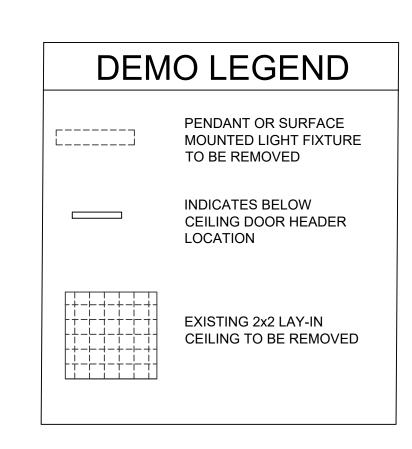
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CEILING DEMO
PLAN
AREA 'D'
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- 1. CONTRACTOR SHALL RE-ORIENT SPRINKLER HEADS TO BE BELOW NEW CEILING TILE.
- 2. AREAS THAT SHOW NO DEMOLITION PATTERNS INDICATE NO CEILING DEMOLITION WORK TO BE PERFORMED. U.N.O.

NOTE:

NO CEILING WORK THIS AREA



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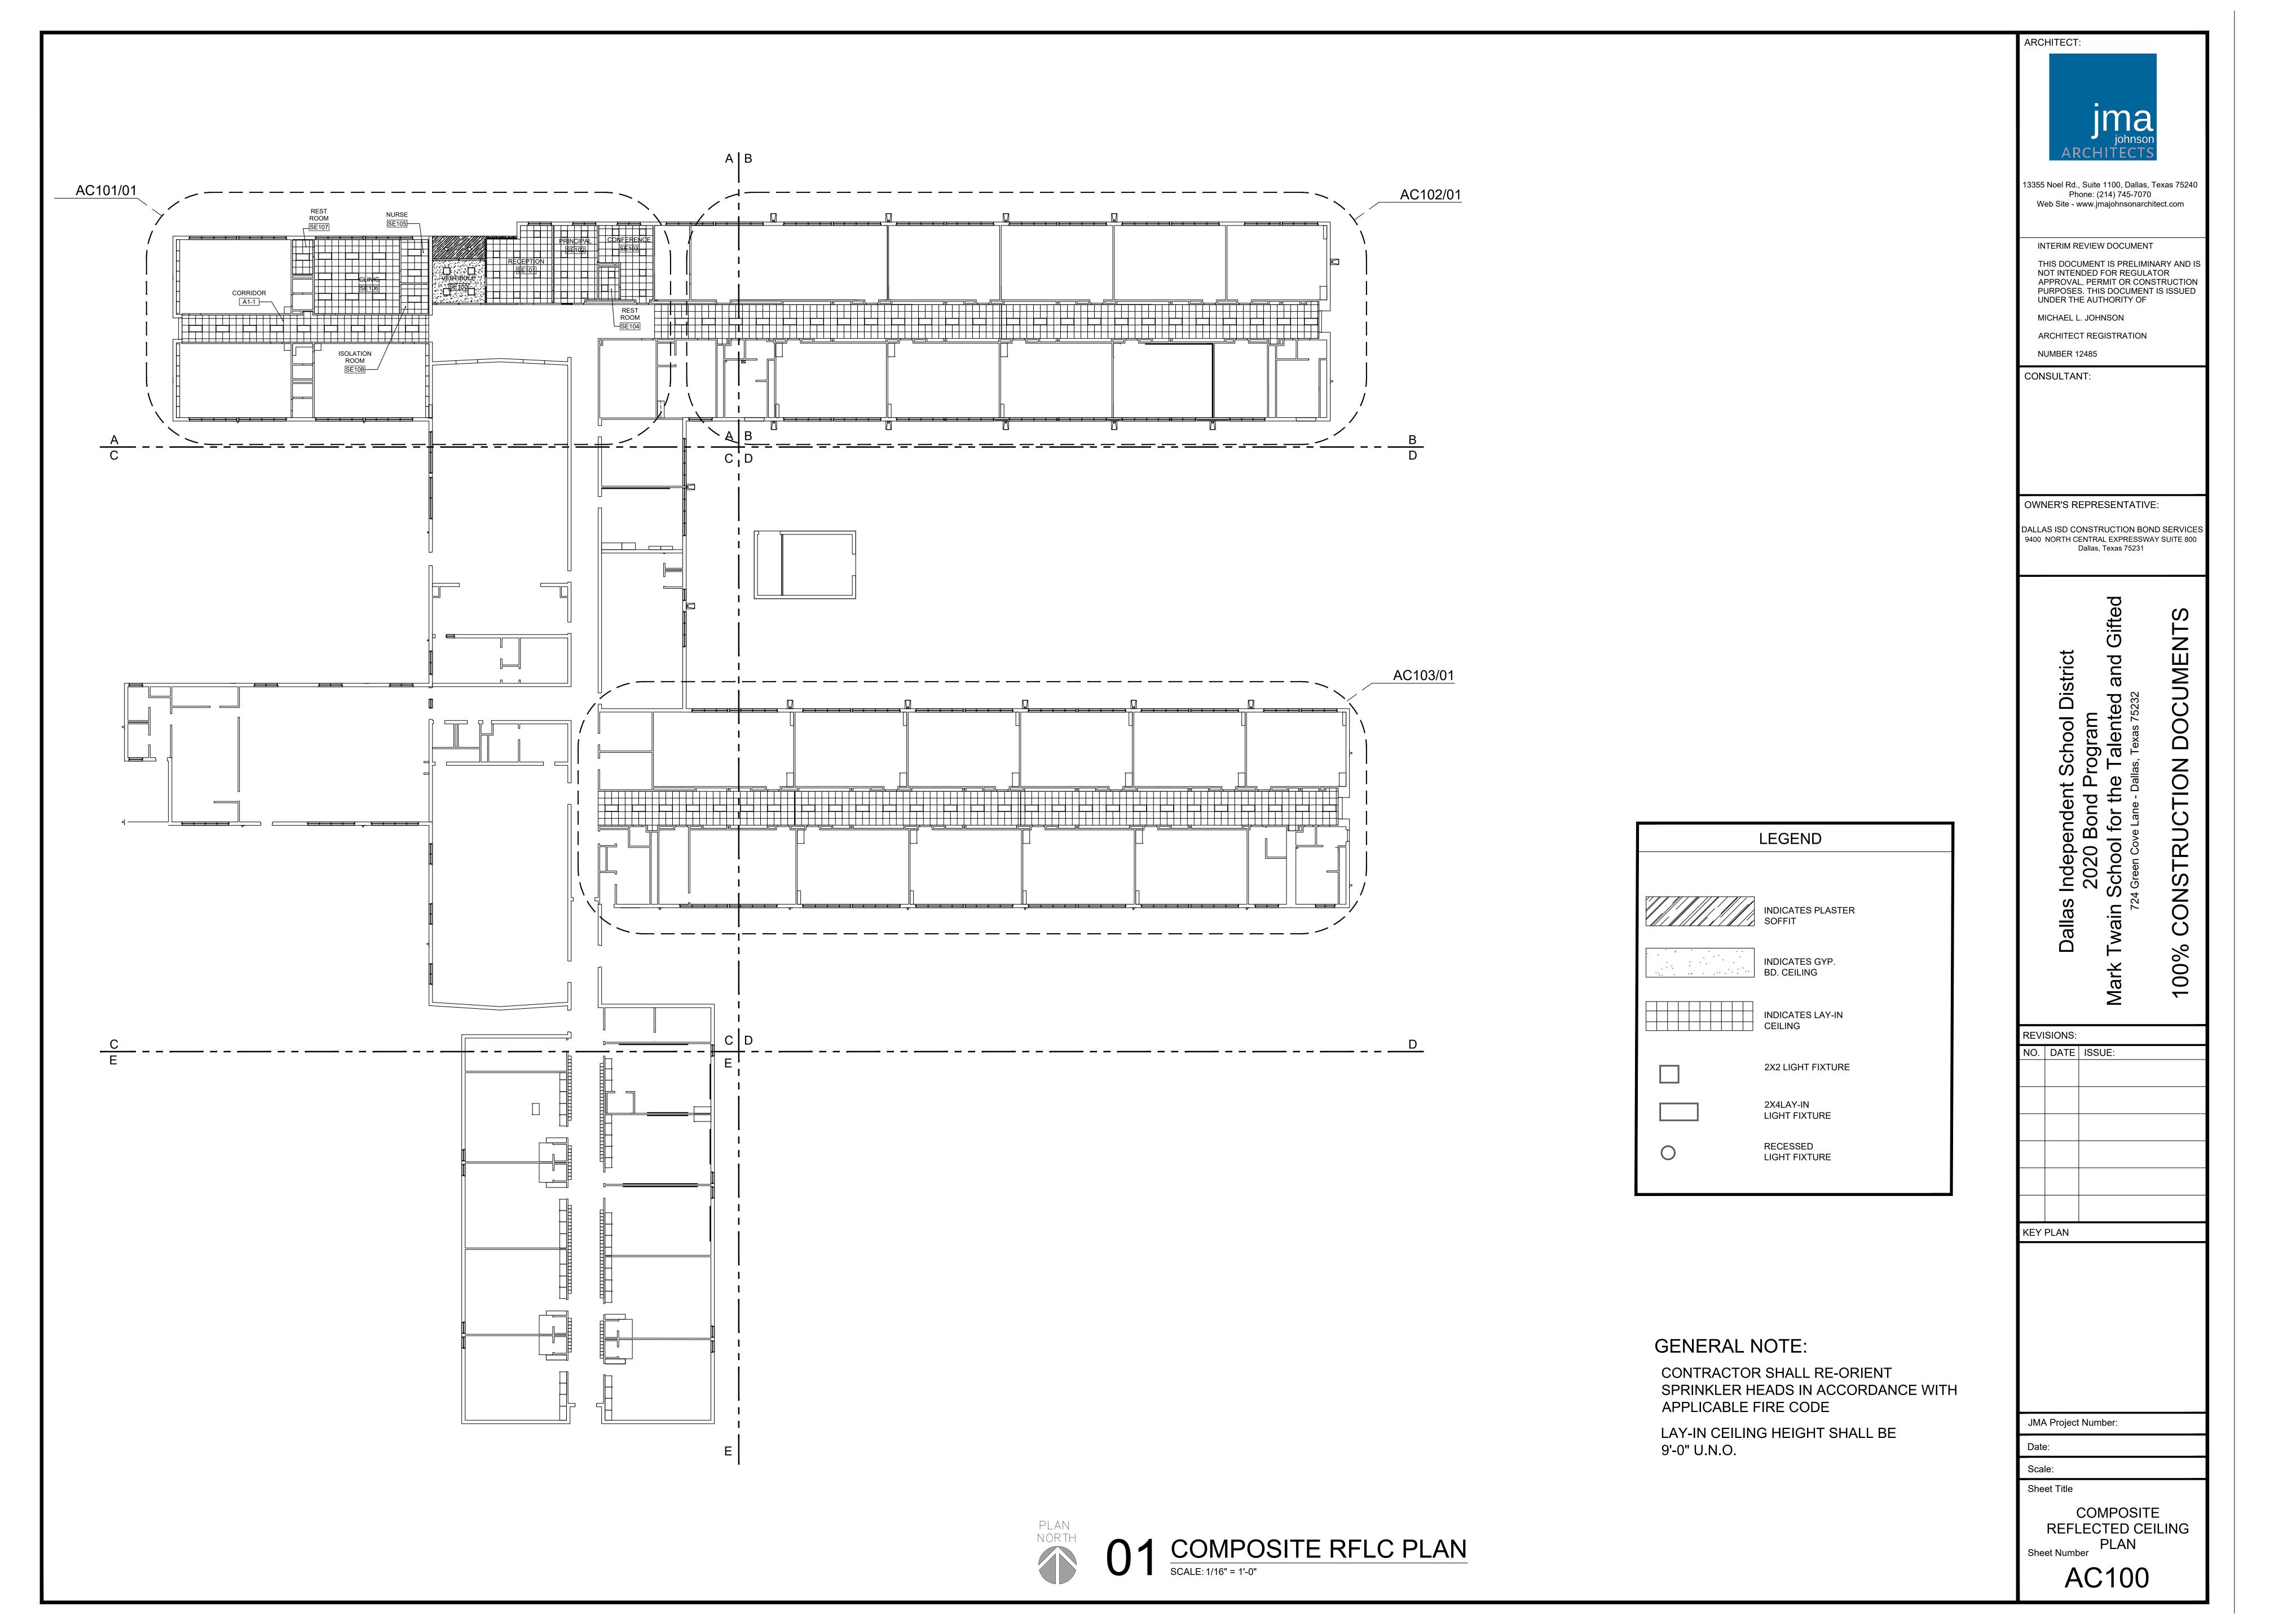
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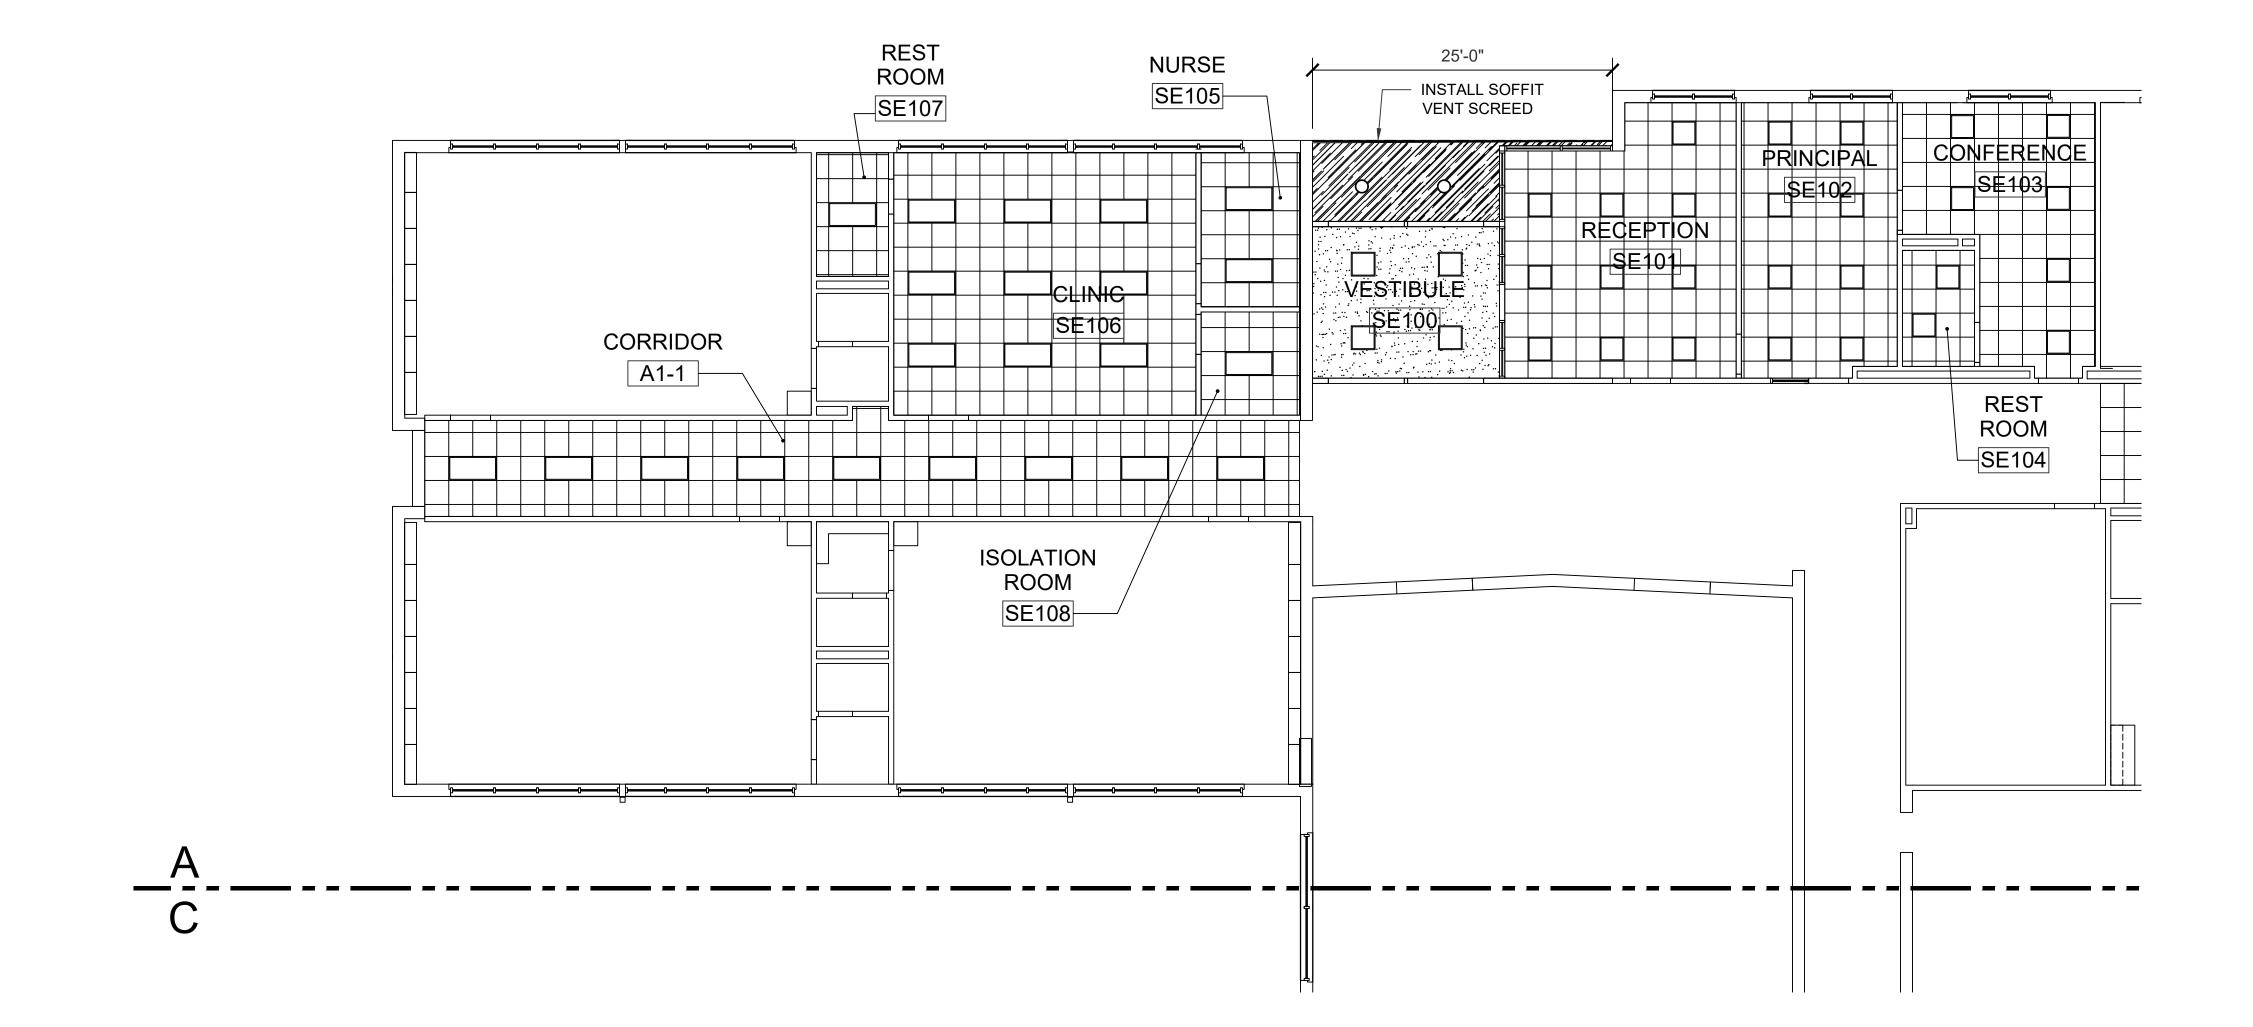
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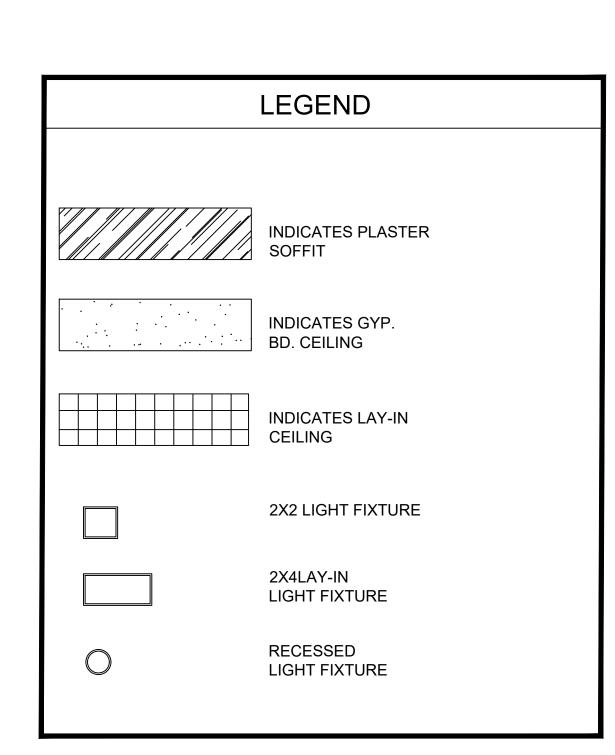
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CEILING DEMO
PLAN
AREA 'E'
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CONTRACTOR SHALL RE-ORIENT
SPRINKLER HEADS IN ACCORDANCE WITH
APPLICABLE FIRE CODE

LAY-IN CEILING HEIGHT SHALL BE 9'-0" U.N.O.

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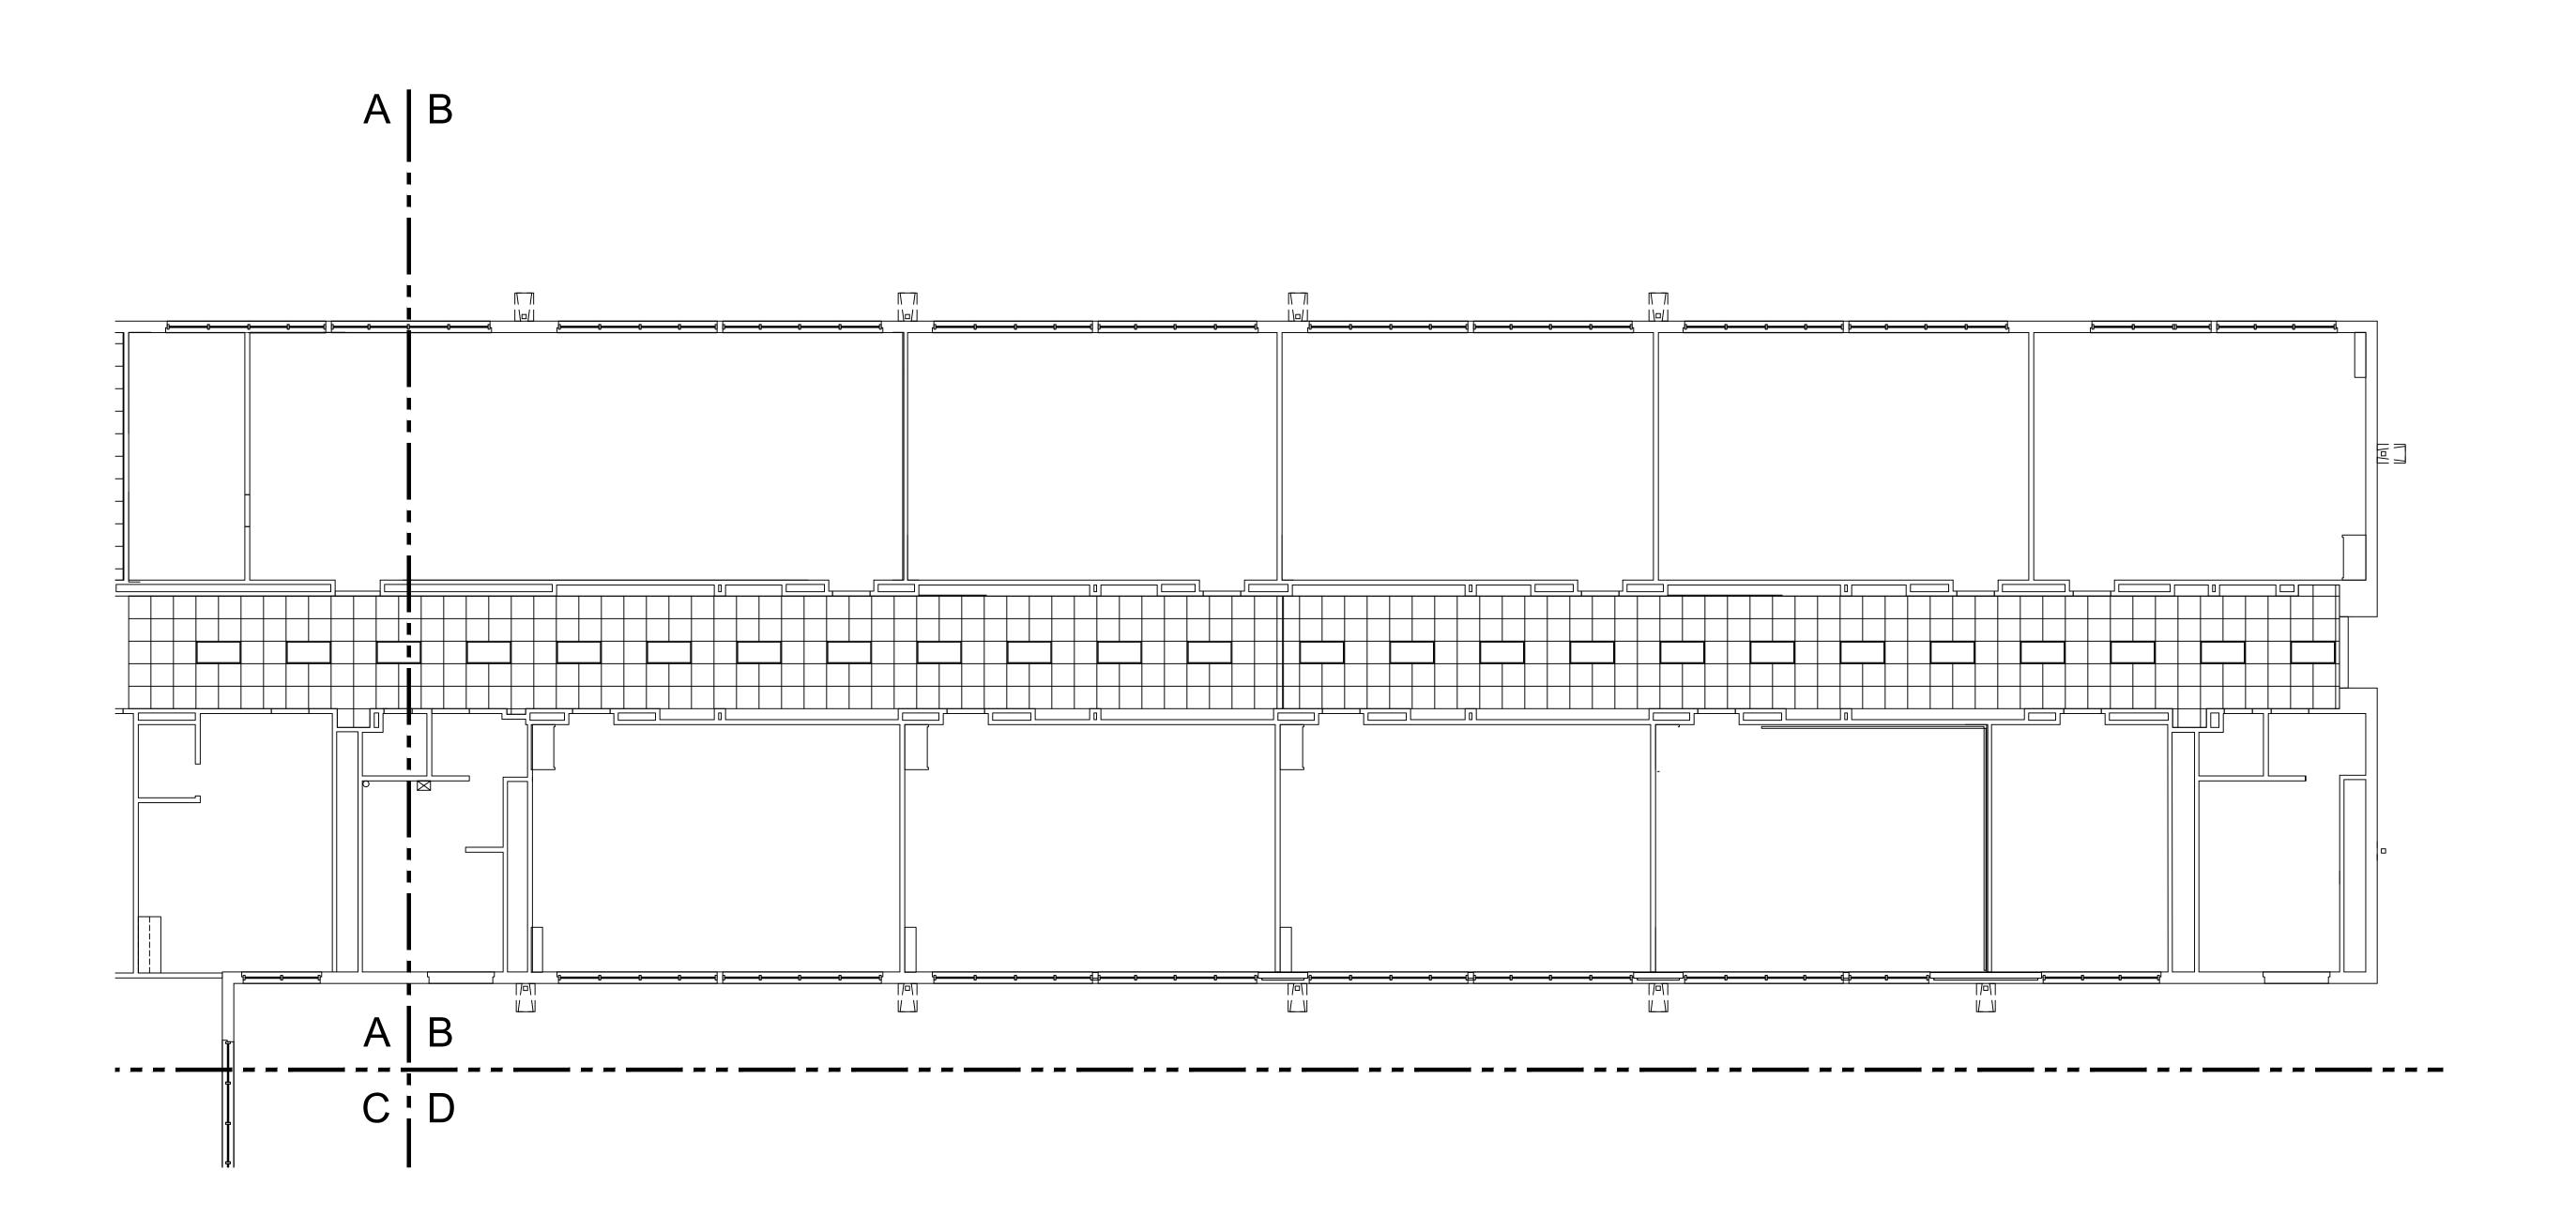
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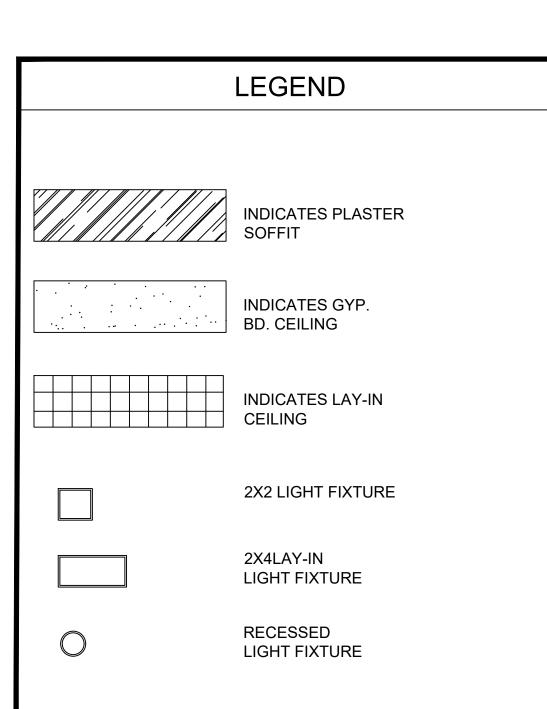
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CEILING PLAN
AREA 'A'

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CONTRACTOR SHALL RE-ORIENT SPRINKLER HEADS IN ACCORDANCE WITH APPLICABLE FIRE CODE

LAY-IN CEILING HEIGHT SHALL BE 9'-0" U.N.O.

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SCALE: 1/8" = 1'-0"

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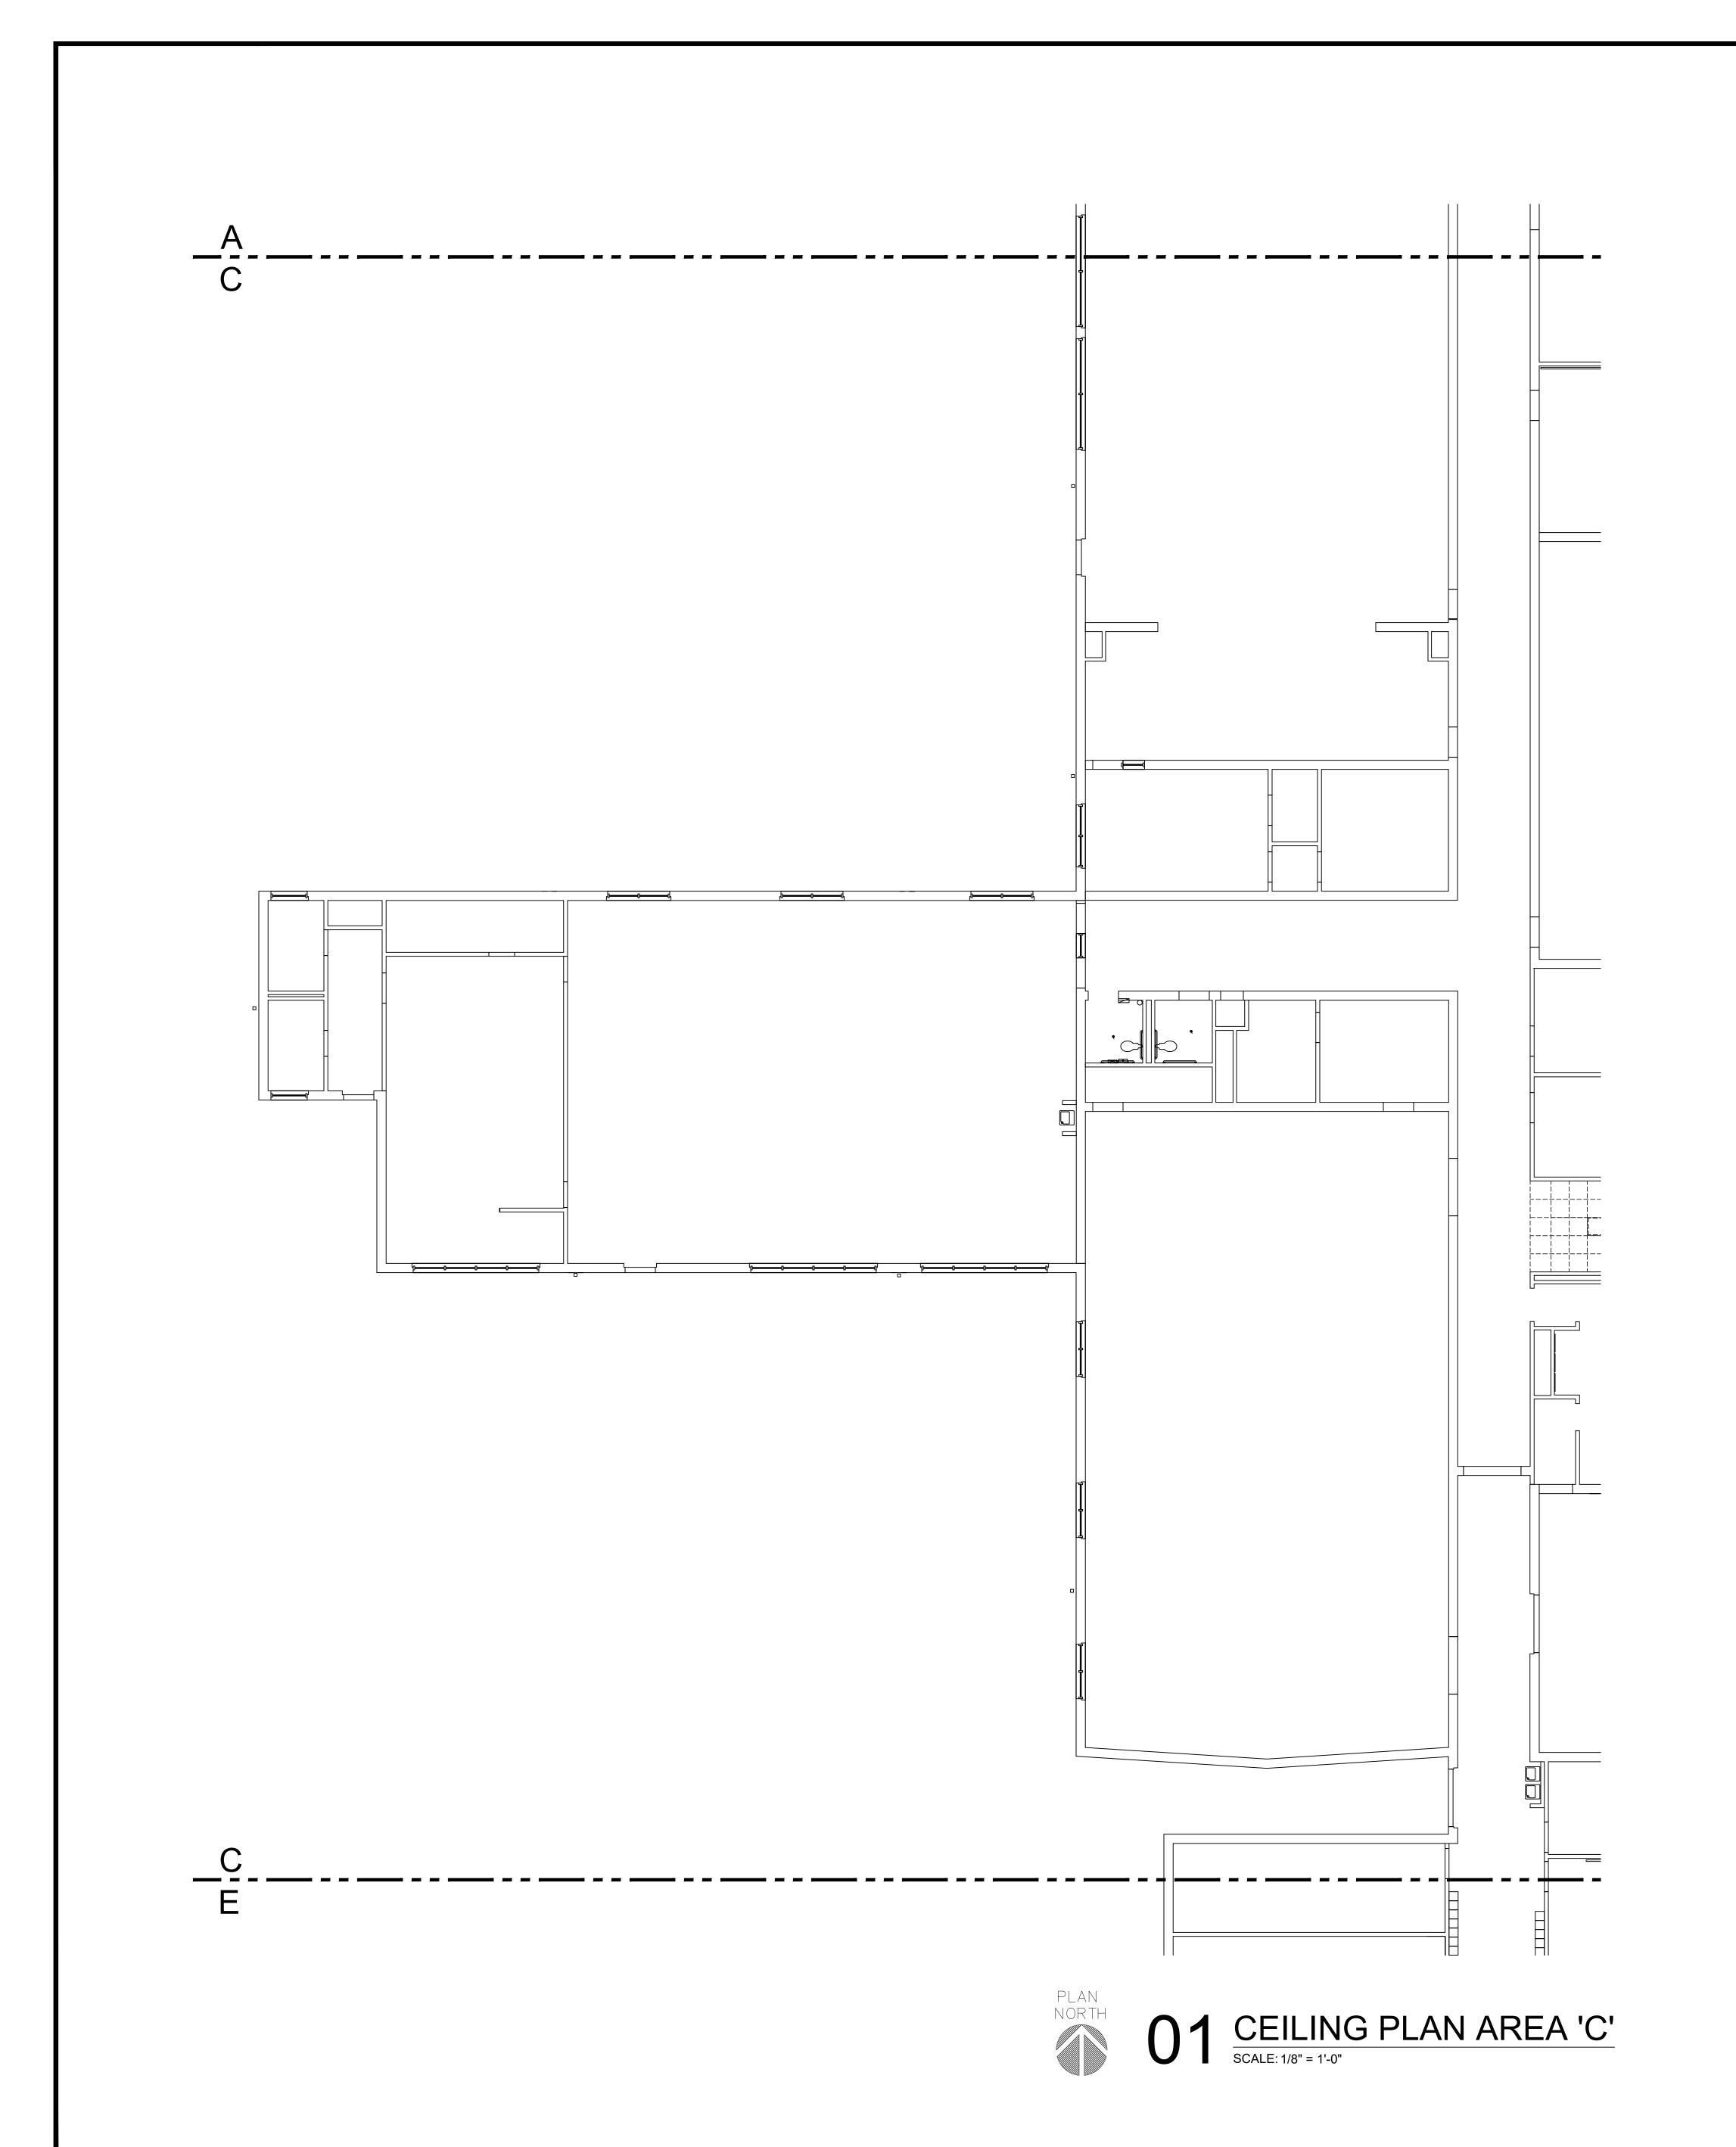
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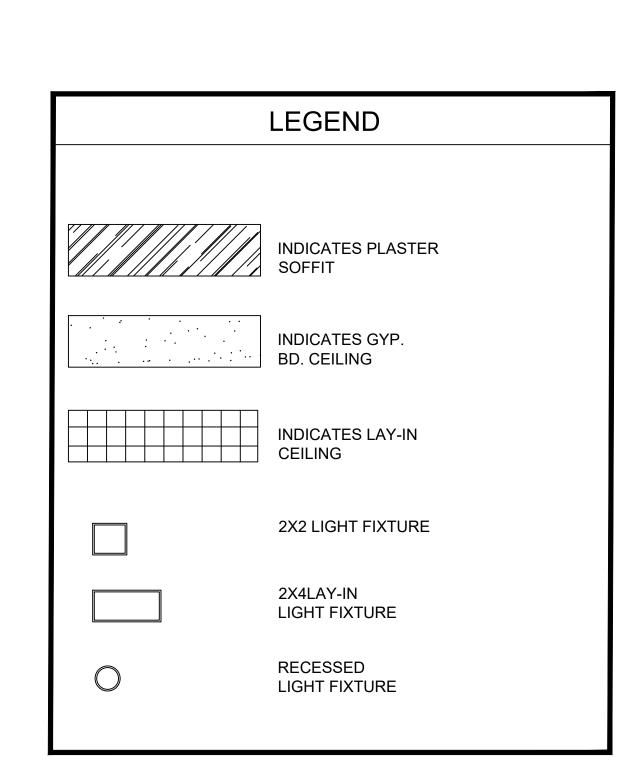
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CONTRACTOR SHALL RE-ORIENT SPRINKLER HEADS IN ACCORDANCE WITH APPLICABLE FIRE CODE

LAY-IN CEILING HEIGHT SHALL BE 9'-0" U.N.O.

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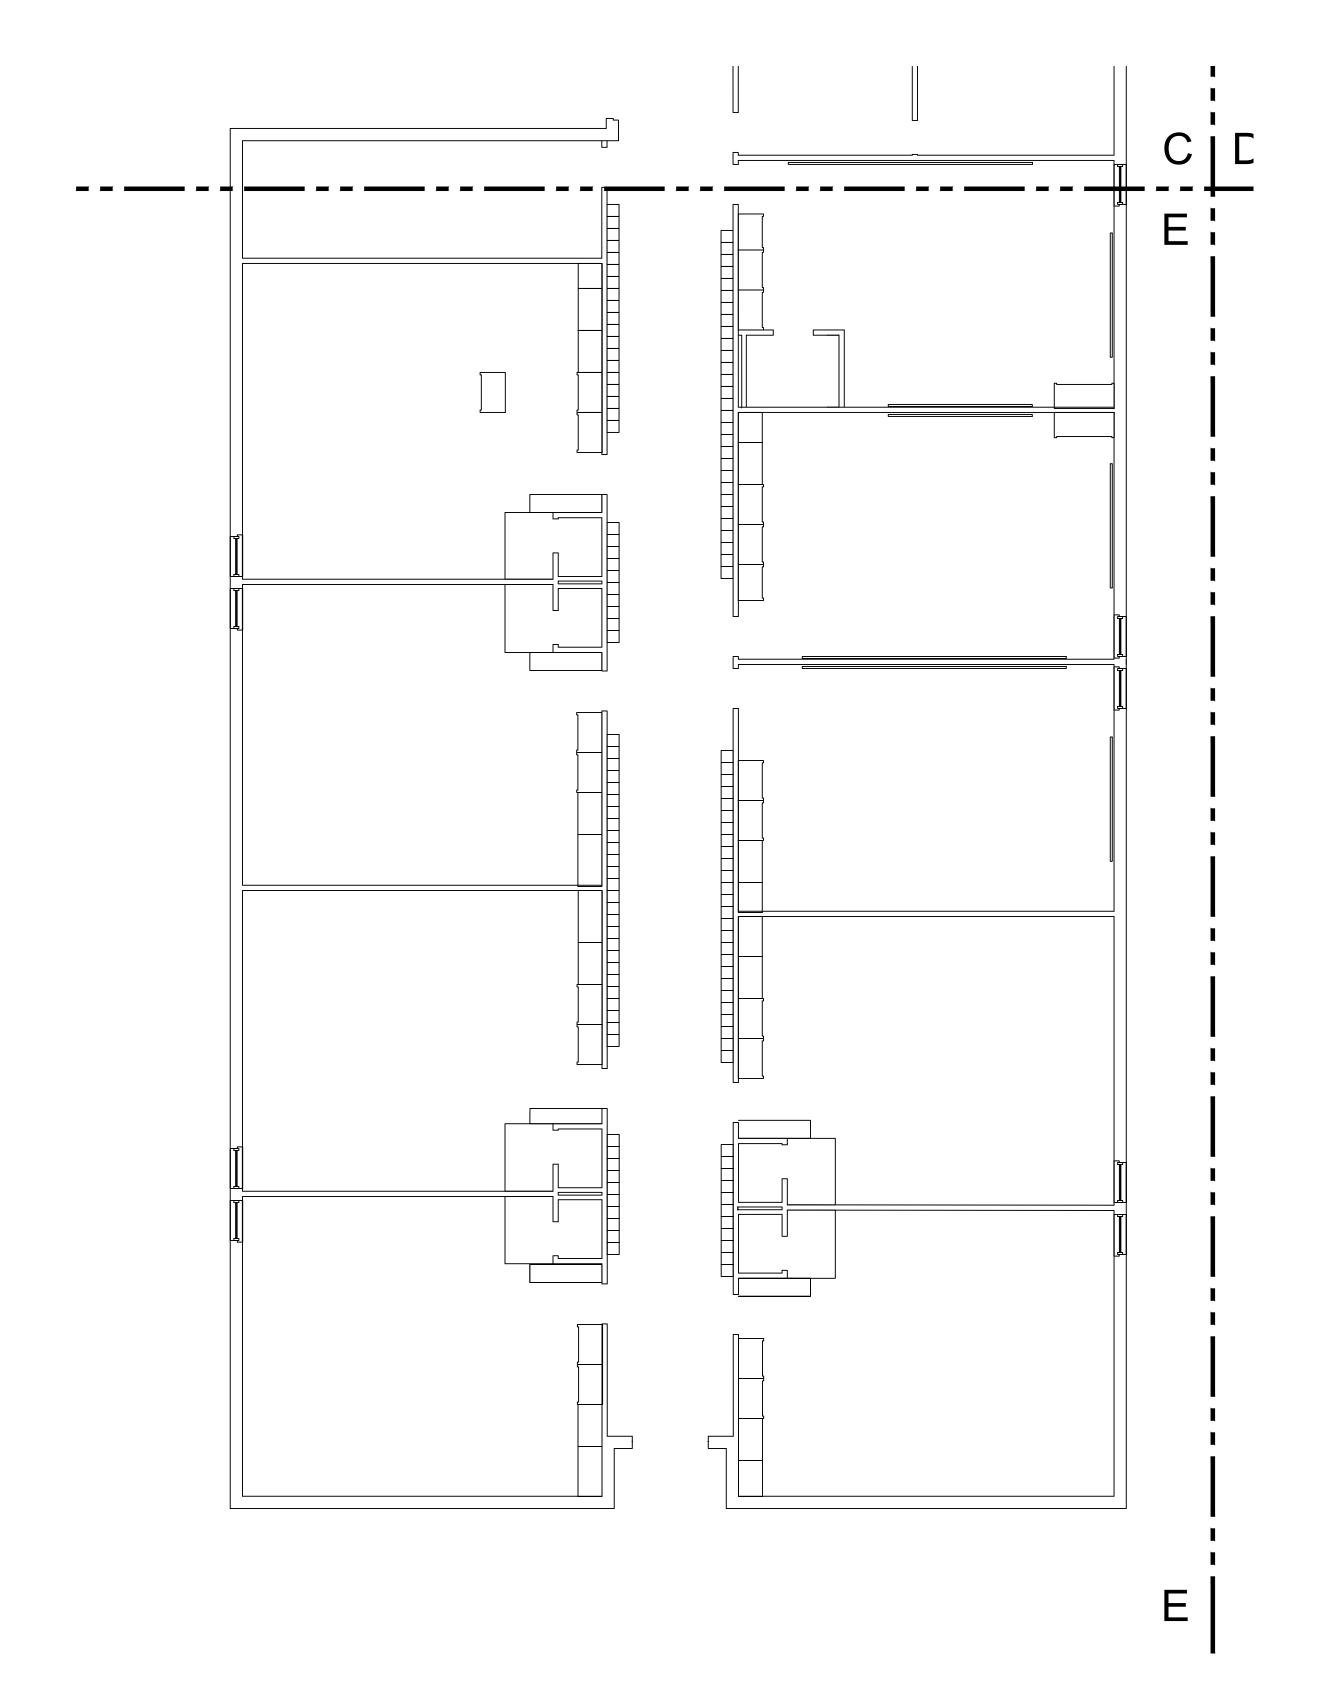
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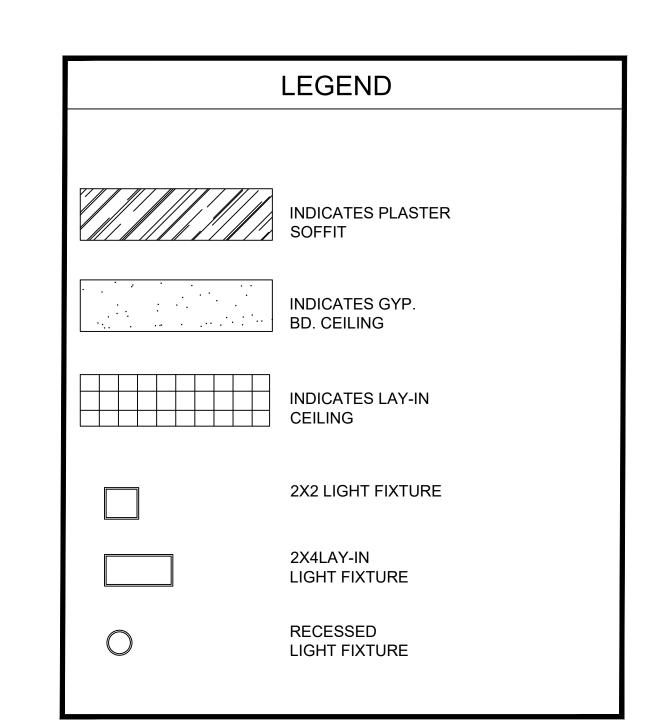
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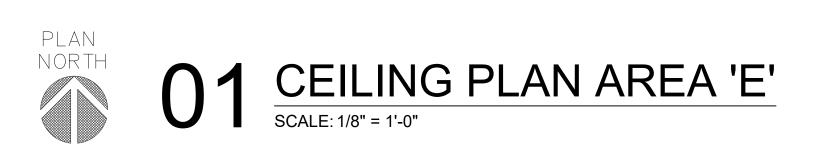
NOTE:
NO CEILING WORK THIS
AREA



GENERAL NOTE:

CONTRACTOR SHALL RE-ORIENT SPRINKLER HEADS IN ACCORDANCE WITH APPLICABLE FIRE CODE

LAY-IN CEILING HEIGHT SHALL BE 9'-0" U.N.O.



ARCHITECT:

jma
johnson
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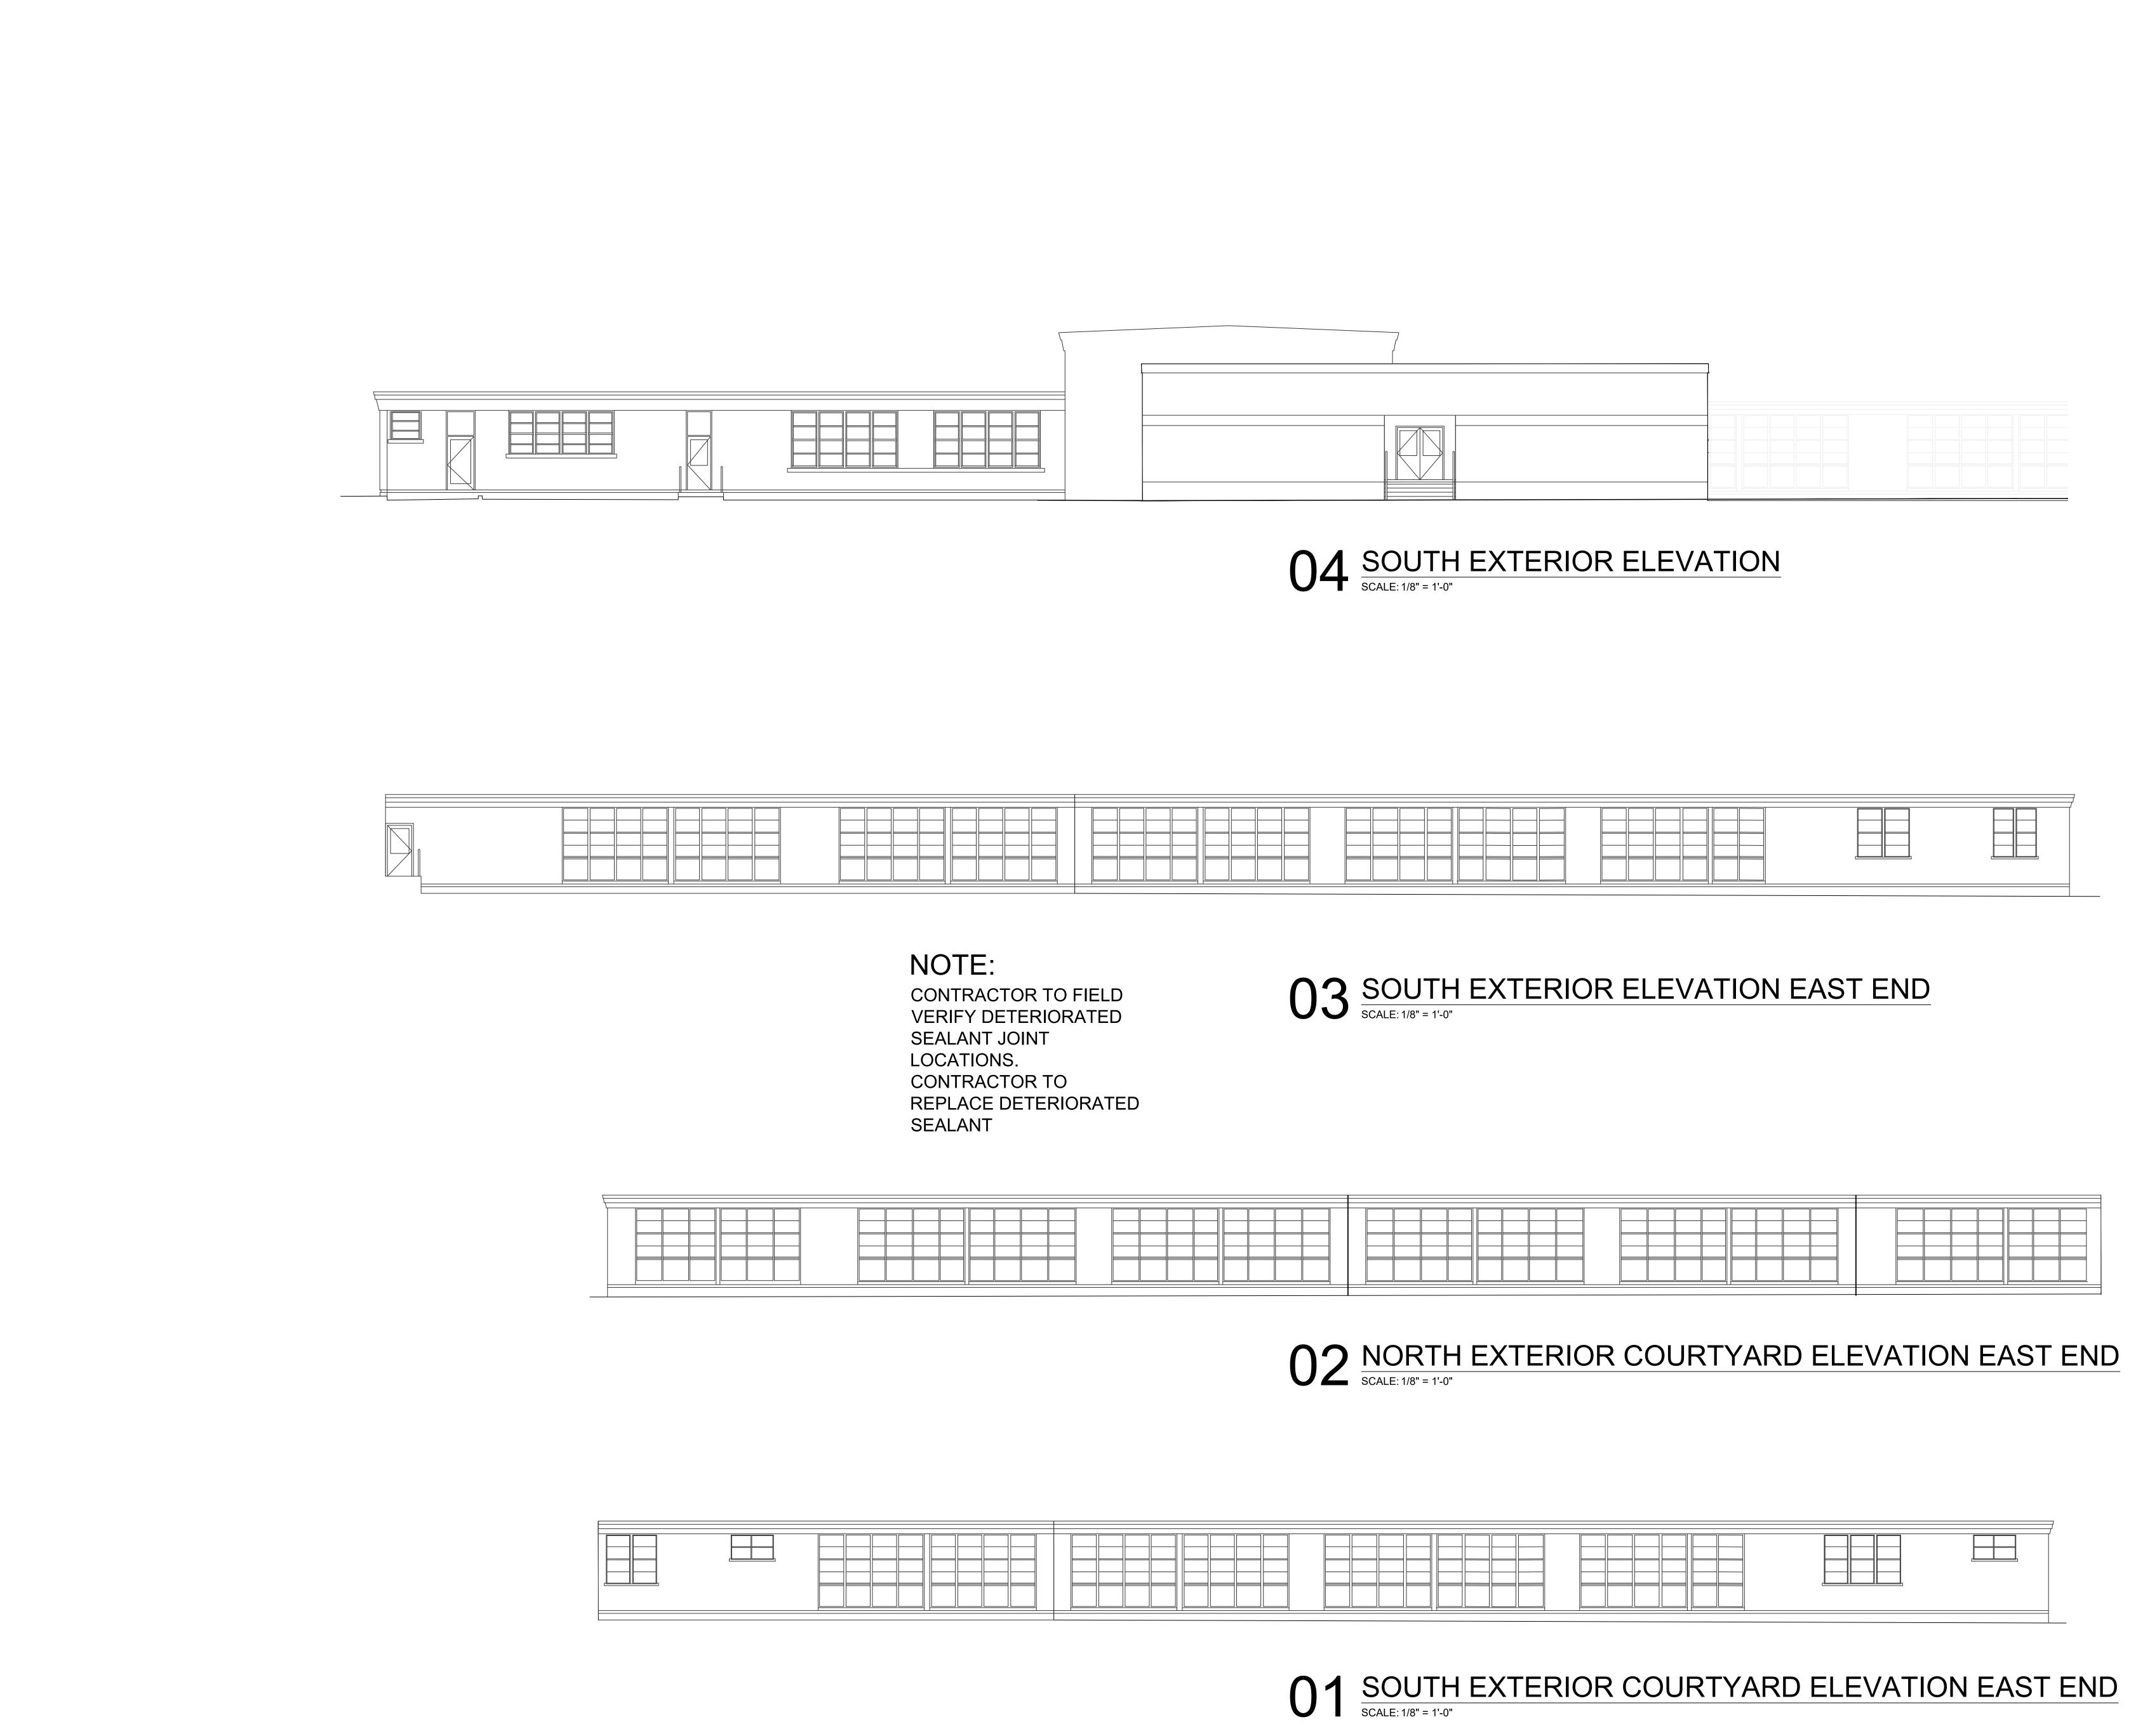
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CEILING PLAN AREA 'E'

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MATCHLINE B	ARCHITECT: Jina Johnson ARCHITECTS 13355 Noel Rd., Suite 1100, Dallas, Texas 7524 Phone: (214) 745-7070 Web Site - www.jmajohnsonarchitect.com INTERIM REVIEW DOCUMENT THIS DOCUMENT IS PRELIMINARY AND NOT INTENDED FOR REGULATOR APPROVAL, PERMIT OR CONSTRUCTIO PURPOSES. THIS DOCUMENT IS ISSUED
	MICHAEL L. JOHNSON ARCHITECT REGISTRATION NUMBER 12485 CONSULTANT:
04 EAST ELEVATION SOUTH END SCALE: 1/8" = 1'-0"	OWNER'S REPRESENTATIVE: DALLAS ISD CONSTRUCTION BOND SERVICE 9400 NORTH CENTRAL EXPRESSWAY SUITE 800 Dallas, Texas 75231
MATCHLINE B O3 EAST ELEVATION NORTH END	Illas Independent School District 2020 Bond Program ain School for the Talented and Gifted 724 Green Cove Lane - Dallas, Texas 75232
NOTE: CONTRACTOR TO FIELD VERIFY DETERIORATED SEALANT JOINT LOCATIONS. CONTRACTOR TO REPLACE DETERIORATED SEALANT O2 NORTH ELEVATION EAST END REVISED SECURE ENTRY	REVISIONS: NO. DATE ISSUE: Wark LM KEY PLAN
NATCHLINE A O 1 NORTH ELEVATION WEST END SCALE 167 = 1/2	JMA Project Number: Date: Scale: Sheet Title EXTERIOR ELEVATIONS Sheet Number AE100



ARCHITECT:

Jina

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9400 NORTH CENTRAL EXPRESSWAY SUITE 800
Dallas, Texas 75231

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Dallas Independent School District
2020 Bond Program
rk Twain School for the Talented and Gift

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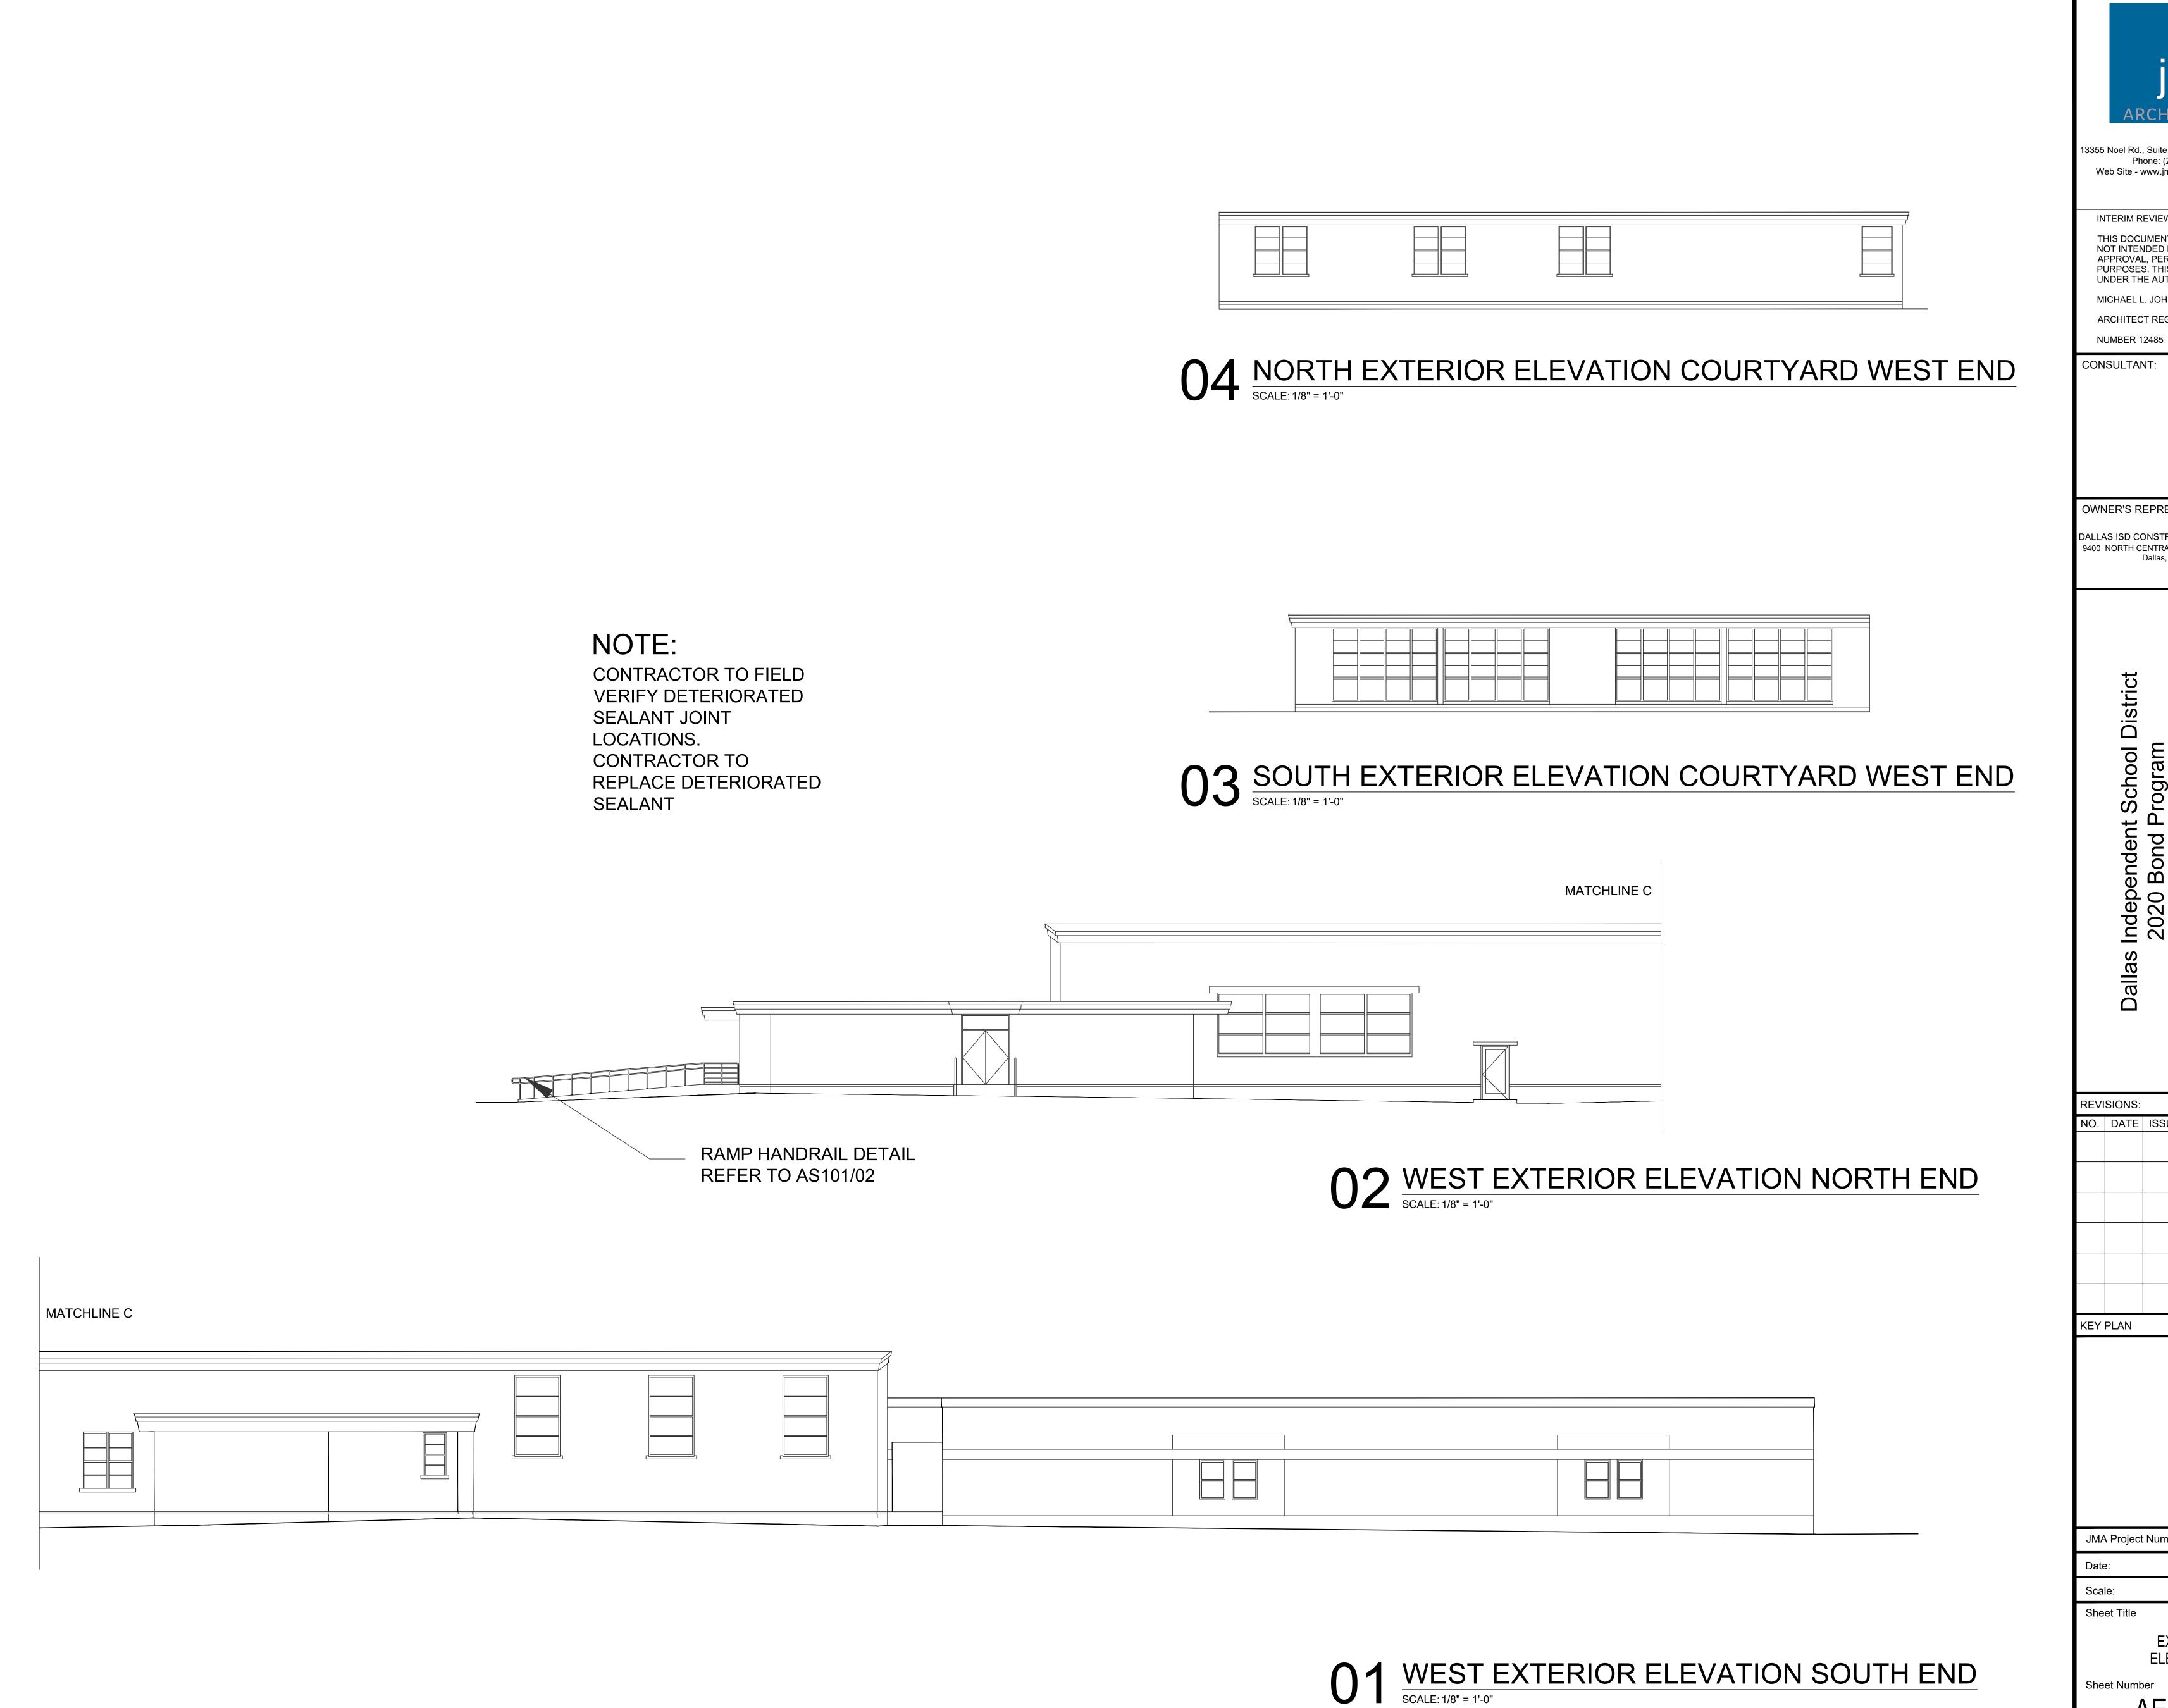
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EXTERIOR ELEVATIONS

Sheet Number
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EXTERIOR ELEVATIONS

AE102

	HVAC LEGEND	MEC	CHANICAL — GENERAL NOTES:
12X10	SHEET METAL DUCTWORK AND TRANSITION. 1ST DIMENSION	1.	ALL MECHANICAL INSTALLATIONS SHALL BE IN STRICT COMPLIANCE WITH THE 2021 INTERNATIONAL MECHANICAL CODE, INTERNATIONAL CODE, INTE
(E) 12X10 Z	NOTED IS SIDE SHOWN. EXISTING DUCTWORK.		ENERGY CONSERVATION CODE 2021, AND ALL LOCAL GOVERNING AUTHORITIES HAVING JURISDICTION.
	HIDDEN DUCTWORK.	2.	ENERGY CONSERVATION CODE 2021. EQUIPMENT EFFICIENCIES SHALL MEET MINIMUM REQUIREMENTS. DUCT INSULATION IN UNCONDITIONED SPACES SHALL HAVE A MINIMUM R5 VALUE.
==	BRANCH TAKEOFF FROM DUCT W/ VOLUME DAMPER AT EA TAKEOFF, EVEN IF VOLUME DAMPER IS NOT SHOWN.	3.	DUCT INSULATION OUTSIDE THE BUILDING INSULATION ENVELOPE SHALL HAVE MINIMUM R8 VALUE. THE MECHANICAL SYSTEM DESIGN CRITERIA ARE PER ASHRAE
₩ 🔀	DUCTWORK: CEILING S/A DIFFUSERS.		FUNDAMENTALS HANDBOOK — 2013, ASHRAE 55 — 2013, AND ASHRAE 62.1 — 2013 STANDARDS.
	THROW IS FOUR-WAY UON. DUCTWORK ELBOW UP.	4.	CONTRACTOR SHALL FIELD VERIFY EXACT SIZE AND LOCATION OF EXISTING MECHANICAL EQUIPMENT, DUCTWORK, AND ALL OTHER MECHANICAL SYSTEMS.
101	DUCTWORK ELBOW DOWN.	5.	REFER TO ARCHITECTS REFLECTED CEILING PLAN FOR EXACT CEILING DIFFUSER LOCATIONS AND ELEVATIONS.
	HVAC EQUIPMENT.	6.	ALL THERMOSTATS, SENSORS, CONTROLS, AND CONTROL WIRING (50 VOLTS OR LESS) SHALL BE FURNISHED AND INSTALLED BY THE CONTRACTOR.
K	WALL SUPPLY AIR REGISTER	7.	MOTOR DISCONNECTS AND STARTERS SHALL BE FURNISHED AND INSTALLED BY THE CONTRACTOR. COORDINATE WITH ELECTRICAL.
<u></u>	WALL RETURN AIR GRILLE	8.	CONDENSATE DRAIN PIPING SHALL BE COPPER AND SHALL BE
	CEILING SUPPLY AIR DIFFUSER. CEILING RETURN OR EXHAUST AIR DEVICE.		SLOPED 1/8 INCH PER FOOT MINIMUM AND BE INSTALLED BY MECHANICAL CONTRACTOR. INTERIOR CONDENSATE PIPING SHALL BE INSULATED.
\boxtimes	SUPPLY OR OUTSIDE AIR DUCTWORK SECTION.	9.	VENTILATION FLUES FOR ALL COMBUSTION EQUIPMENT BY
	RETURN AIR DUCTWORK SECTION.	10.	CONTRACTOR. PROVIDE FIRE/SMOKE DAMPERS AS REQUIRED PER APPLICABLE
ZED Z	EXHAUST AIR DUCTWORK SECTION.	11.	CODES AT RATED FLOORS, CEILINGS, WALLS, AND CHASES. ALL DUCTWORK DIMENSIONS ARE CLEAR, INSIDE DIMENSIONS.
∇FD → TSO	FIRE DAMPER		DUCTWORK SHALL BE GALVANIZED STEEL AND SHALL MEET MINIMUM S.M.A.C.N.A. CONSTRUCTION STANDARDS.
▼SD → TESD	SMOKE DAMPER		FLEXIBLE DUCT SHALL NOT EXCEED 5'-0". MAINTAIN ALL DUCTWORK CLEARANCES REQUIRED BY THE
▼FSD →	COMB. FIRE/SMOKE DAMPER	4.4	NATIONAL ELECTRIC CODE ABOVE ALL ELECTRICAL PANELS. COORDINATE WITH CONTRACTOR.
	MOTORIZED DAMPER.	14.	DUCTWORK LAYOUT ON DRAWINGS IS SCHEMATIC IN NATURE. FIELD VERIFY ALL STRUCTURAL SUPPORTS AND BEAMS AND AVOID DUCTWORK CONFLICTS.
© ®	FLEXIBLE DUCTWORK CO2 SENSOR CO SENSOR	15.	OUTSIDE AIR INTAKES SHALL BE A MINIMUM OF 10'-0" FROM ALL EXHAUST SOURCES.
(H)	THERMOSTAT TEMPERATURE SENSOR HUMIDITY SENSOR	16.	SMOKE DETECTORS SHALL BE INSTALLED IN THE SUPPLY AND RETURN DUCTS OF SHALL UNITS GREATER THAN 2,000 CFM.
(F) (SD)	DUCT MOUNTED UL LISTED SMOKE DETECTOR. FURNISHED BY DIV. 28, INSTALLED		SMOKE DETECTORS SHALL BE FURNISHED AND WIRED BY THE CONTRACTOR. SMOKE DETECTORS SHALL BE INSTALLED BY THE CONTRACTOR.
(A,150)	BY MECHANICAL CONTRACTOR. AIR DEVICE TYPE, CFM ("" IN PLACE OF CFM INDICATES RA OR	17.	CONTRACTOR SHALL INSTALL ALL EQUIPMENT AND SYSTEMS PER MANUFACTURER'S INSTRUCTIONS. MAINTAIN REQUIRED ACCESS
A, 8"Ø NK	ÈXH GRILLE W/NO BALANCING REQUIREMENTS) TOP ROW — AIR DEVICE TYPE, NECK		PER MECHANICAL CODE AND MANUFACTURER'S SERVICE RECOMMENDATIONS.
150 24X24	SIZE (OPTIONAL) BOTTOM ROW — CFM, LENGTH X WIDTH. SEE SCHEDULE. POINT OF CONNECTION, NEW TO EXIST	18.	CONTRACTOR SHALL PROVIDE GUARDS FOR ANY EQUIPMENT LOCATED WITHIN 10 FEET OF A ROOF EDGE OR OPEN WALKING SURFACE PER THE REQUIREMENTS OF THE INTERNATIONAL
•	DUCT/PIPE. ABBREVIATIONS	19	MECHANICAL CODE. MECHANICAL LAYOUT IS DIAGRAMMATIC IN NATURE AND DOES NOT
AFF AFG	ABOVE FINISHED FLOOR ABOVE FINISHED GRADE	13.	REPRESENT A SET OF SHOP DRAWINGS. THE CONTRACTOR SHALL BE RESPONSIBLE FOR FURNISHING AND INSTALLING A
AMB AMP ARCH	AMBIENT AMPERES ARCHITECT, ARCHITECTURAL	=	COMPLETE, FUNCTIONING MECHANICAL SYSTEM COORDINATED WITH ARCHITECTURAL AND STRUCTURAL FIELD CONDITIONS.
BOD BOP BFF	BOTTOM OF DUCT BOTTOM OF PIPE BELOW FINISHED FLOOR		HVAC UNITS SHALL NOT BE RUN WITHOUT FILTERS. CONTRACTOR SHALL INSTALL A NEW SET OF FILTERS ON ALL
BFP BFV BTUH	BACK FLOW PREVENTER BUTTERFLY VALVE BRITISH THERMAL UNITS / HR.		HVAC UNITS A WEEK PRIOR TO SUBSTANTIAL COMPLETION AND ANOTHER NEW SET OF FILTERS ONE WEEK PRIOR TO THE SIX MONTH WARRANTY WALK—THRU.
BV BYP CD CFM	BALL VALVE BYPASS CONDENSATE DRAIN LINE, EQUIP. DRAIN CUBIC FEET PER MINUTE		
CHWR/CHWS CO CONT	CHILLED WATER RETURN / SUPPLY CLEANOUT CONTINUATION		
COORD CWR/CWS dB	COORDINATE CONDENSER WATER RETURN / SUPPLY		
DB DDC DEG F	DECIBEL(S) DRY BULB TEMPERATURE DIRECT DIGITAL CONTROL DEGREES FAHRENHEIT		
DIA DN (E) EA	DIAMETER DOWN EXISTING		
ĖĄ I			
EAT EDB	EACH ENTERING AIR TEMPERATURE ENTERING DRY BULB TEMPERATURE		
EAT EDB EER EFF EL	EACH ENTERING AIR TEMPERATURE ENTERING DRY BULB TEMPERATURE ENERGY EFFICIENCY RATIO EFFICIENCY ELEVATION		SUPPLY AIR FLOW AMARK RANGE CFM
EAT EDB EER EFF EL ELEC EWB EWT	EACH ENTERING AIR TEMPERATURE ENTERING DRY BULB TEMPERATURE ENERGY EFFICIENCY RATIO EFFICIENCY ELEVATION ELECTRICAL ENTERING WET BULB TEMPERATURE ENTERING WATER TEMPERATURE		
EAT EDB EER EFF EL ELEC EWB EWT EXIST EXH F&I	EACH ENTERING AIR TEMPERATURE ENTERING DRY BULB TEMPERATURE ENERGY EFFICIENCY RATIO EFFICIENCY ELEVATION ELECTRICAL ENTERING WET BULB TEMPERATURE ENTERING WATER TEMPERATURE EXISTING EXHAUST FURNISH AND INSTALL		MARK RANGE CFM AP-A 0 - 6,000 NOTES:
EAT EDB EEFF EL ELEC EWB EWT EXIST EXIST EXIST F&I FLEX FPM FPS	EACH ENTERING AIR TEMPERATURE ENTERING DRY BULB TEMPERATURE ENERGY EFFICIENCY RATIO EFFICIENCY ELEVATION ELECTRICAL ENTERING WET BULB TEMPERATURE ENTERING WATER TEMPERATURE EXISTING EXHAUST FURNISH AND INSTALL FLEXIBLE DUCT FEET PER MINUTE FEET PER SECOND		MARK RANGE CFM AP-A 0 - 6,000
EAT EDB EER EFF ELLEC EWB EXIST EXH FLEX FPS FLEX FPS FC GPM	EACH ENTERING AIR TEMPERATURE ENTERING DRY BULB TEMPERATURE ENERGY EFFICIENCY RATIO EFFICIENCY ELEVATION ELECTRICAL ENTERING WET BULB TEMPERATURE ENTERING WATER TEMPERATURE EXISTING EXHAUST FURNISH AND INSTALL FLEXIBLE DUCT FEET PER MINUTE FEET PER SECOND FEET GENFEAL CONTRACTOR		MARK RANGE CFM AP-A 0 - 6,000 NOTES: 1. FURNISH WITH CONTROL BOX
EAT EDB EEFF EL EC EWST EXST EXST EXST EXST EXST EXST EXST EX	EACH ENTERING AIR TEMPERATURE ENTERING DRY BULB TEMPERATURE ENERGY EFFICIENCY RATIO EFFICIENCY ELEVATION ELECTRICAL ENTERING WET BULB TEMPERATURE ENTERING WATER TEMPERATURE EXISTING EXHAUST FURNISH AND INSTALL FLEXIBLE DUCT FEET PER MINUTE FEET PER SECOND FEET GENERAL CONTRACTOR GALLON PER MINUTE HORSE POWER HOUR HUMIDISTAT		MARK RANGE CFM AP-A 0 - 6,000 NOTES: 1. FURNISH WITH CONTROL BOX 2. MOUNT BI-POLAR ION GENERA 3. IF CONTRACTOR SUBSTITUTES
EAT BEEFF LECEWITST EXEMPS FLEW FLEX FLEX FLEX FLEX FLEX FLEX FLEX FLEX	EACH ENTERING AIR TEMPERATURE ENTERING DRY BULB TEMPERATURE ENERGY EFFICIENCY RATIO EFFICIENCY ELEVATION ELECTRICAL ENTERING WET BULB TEMPERATURE ENTERING WATER TEMPERATURE EXISTING EXHAUST FURNISH AND INSTALL FLEXIBLE DUCT FEET PER MINUTE FEET PER SECOND FEET GENERAL CONTRACTOR GALLON PER MINUTE HORSE POWER HOUR HUMIDISTAT HEATING, VENTILATION AND AIR CONDITIONING HEATING WATER HEATING WATER		MARK RANGE CFM AP-A 0 - 6,000 NOTES: 1. FURNISH WITH CONTROL BOX 2. MOUNT BI-POLAR ION GENERA 3. IF CONTRACTOR SUBSTITUTES ALL ELECTRICAL AND MECHA 4. BI-POLAR IONIZATION SYSTEM
EAT EDB EEFF ELEWITST EXIST EX	EACH ENTERING AIR TEMPERATURE ENTERING DRY BULB TEMPERATURE ENERGY EFFICIENCY RATIO EFFICIENCY ELEVATION ELECTRICAL ENTERING WET BULB TEMPERATURE ENTERING WATER TEMPERATURE EXISTING EXHAUST FURNISH AND INSTALL FLEXIBLE DUCT FEET PER MINUTE FEET PER SECOND FEET GENERAL CONTRACTOR GALLON PER MINUTE HORSE POWER HOUR HUMIDISTAT HEATING, VENTILATION AND AIR CONDITIONING HEATING WATER HEATING WATER HEATING WATER RETURN INDOOR AIR QUALITY INCHES KITCHEN EQUIPMENT CONTRACTOR		MARK RANGE CFM AP-A 0 - 6,000 NOTES: 1. FURNISH WITH CONTROL BOX 2. MOUNT BI-POLAR ION GENERA 3. IF CONTRACTOR SUBSTITUTES ALL ELECTRICAL AND MECHA 4. BI-POLAR IONIZATION SYSTEM 5. ALL MANUFACTURERS MUST
EAT BREFF LCBWTSTH XEN SCHOOL FLEW FLEN STANDER FLEW FLEN STANDER FLEN FLEN STANDER	EACH ENTERING AIR TEMPERATURE ENTERING DRY BULB TEMPERATURE ENERGY EFFICIENCY RATIO EFFICIENCY ELEVATION ELECTRICAL ENTERING WET BULB TEMPERATURE ENTERING WATER TEMPERATURE EXISTING EXHAUST FURNISH AND INSTALL FLEXIBLE DUCT FEET PER MINUTE FEET PER SECOND FEET GENERAL CONTRACTOR GALLON PER MINUTE HORSE POWER HOUR HUMIDISTAT HEATING, VENTILATION AND AIR CONDITIONING HEATING WATER HEATING WATER HEATING WATER HEATING WATER HEATING WATER KILOWATT KILOWATT KILOWATT KILOWATT KILOWATT KILOWATT FOUNDS		MARK RANGE CFM AP-A 0 - 6,000 NOTES: 1. FURNISH WITH CONTROL BOX 2. MOUNT BI-POLAR ION GENERA 3. IF CONTRACTOR SUBSTITUTES ALL ELECTRICAL AND MECHA 4. BI-POLAR IONIZATION SYSTEM 5. ALL MANUFACTURERS MUST
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EAT BEEFF LE BEWIST FLEX MS FOR SET HER STEEL ELEWENT FOR SET	EACH ENTERING AIR TEMPERATURE ENTERING DRY BULB TEMPERATURE ENERGY EFFICIENCY RATIO EFFICIENCY ELEVATION ELECTRICAL ENTERING WET BULB TEMPERATURE ENTERING WATER TEMPERATURE EXISTING EXHAUST FURNISH AND INSTALL FLEXIBLE DUCT FEET PER MINUTE FEET PER SECOND FEET GENERAL CONTRACTOR GALLON PER MINUTE HORSE POWER HOUR HUMIDISTAT HEATING, VENTILATION AND AIR CONDITIONING HEATING WATER HEATING WATER HEATING WATER HEATING WATER KITCHEN EQUIPMENT CONTRACTOR KILOWATT KILOWATT KILOWATT HOUR POUNDS LEAVING DRY BULB TEMPERATURE LEAVING WATER TEMPERATURE LEAVING WATER TEMPERATURE MIXED AIR TEMPERATURE MIXED AIR TEMPERATURE MIXED AIR TEMPERATURE MIXED AIR TEMPERATURE		MARK RANGE CFM AP-A 0 - 6,000 NOTES: 1. FURNISH WITH CONTROL BOX 2. MOUNT BI-POLAR ION GENERA 3. IF CONTRACTOR SUBSTITUTES ALL ELECTRICAL AND MECHA 4. BI-POLAR IONIZATION SYSTEM 5. ALL MANUFACTURERS MUST
EAT BREFF CBST STANDERS STANDE	EACH ENTERING AIR TEMPERATURE ENTERING DRY BULB TEMPERATURE ENERGY EFFICIENCY RATIO EFFICIENCY ELEVATION ELECTRICAL ENTERING WET BULB TEMPERATURE ENTERING WATER TEMPERATURE EXISTING EXHAUST FURNISH AND INSTALL FLEXIBLE DUCT FEET PER MINUTE FEET PER SECOND FEET GENERAL CONTRACTOR GALLON PER MINUTE HORSE POWER HOUR HUMIDISTAT HEATING, VENTILATION AND AIR CONDITIONING HEATING WATER HEATING WATER HEATING WATER HEATING WATER KITCHEN EQUIPMENT CONTRACTOR KILOWATT KILOWATT KILOWATT KILOWATT KILOWATT KILOWATT LEAVING DRY BULB TEMPERATURE LEAVING WET BULB TEMPERATURE LOUVER LEAVING WATER TEMPERATURE MIXED AIR TEMPERAT		MARK RANGE CFM AP-A 0 - 6,000 NOTES: 1. FURNISH WITH CONTROL BOX 2. MOUNT BI-POLAR ION GENERA 3. IF CONTRACTOR SUBSTITUTES ALL ELECTRICAL AND MECHA 4. BI-POLAR IONIZATION SYSTEM 5. ALL MANUFACTURERS MUST 6. FURNISH WITH BAS ALARM CO
EAT BREFF LEBENSTER STEPFFFGGPPRISTAL LEBENSTER STEPFFFGGPPRISTAL LEBENSTER STEPFFFGGPPRISTAL LEBENSTER STEPFFFGGPPRISTAL LEBENSTER STEPFFFGGPPRISTAL LEBENSTER STEPFFFGGPPRISTAL LEBENSTER STEPFFGGPPRISTAL LEBENSTER STEPFFGFFGFFGFFGFFGFFGFFGFFGFFGFFGFFGFFGFFG	EACH ENTERING AIR TEMPERATURE ENTERING DRY BULB TEMPERATURE ENERGY EFFICIENCY RATIO EFFICIENCY ELEVATION ELECTRICAL ENTERING WET BULB TEMPERATURE ENTERING WATER TEMPERATURE EXISTING EXHAUST FURNISH AND INSTALL FLEXIBLE DUCT FEET PER MINUTE FEET PER SECOND FEET GENERAL CONTRACTOR GALLON PER MINUTE HORSE POWER HOUR HUMIDISTAT HEATING, VENTILATION AND AIR CONDITIONING HEATING WATER HEATING WATER RETURN INDOOR AIR QUALITY INCHES KITCHEN EQUIPMENT CONTRACTOR KILOWATT KILOWATT HOUR POUNDS LEAVING DRY BULB TEMPERATURE LEAVING WET BULB TEMPERATURE LEAVING WATER TEMPERATURE LOUVER LEAVING WATER TEMPERATURE MIXED AIR TEMPERATURE MIXED AIR TEMPERATURE MAXIMUM BTU/HR X 1,000 MECHANICAL MOTORIZED VOLUME DAMPER NOT APPLICABLE NOT IN CONTRACT NOT TO SCALE OUTSIDE AIR		MARK RANGE CFM AP-A 0 - 6,000 NOTES: 1. FURNISH WITH CONTROL BOX 2. MOUNT BI-POLAR ION GENERA 3. IF CONTRACTOR SUBSTITUTES ALL ELECTRICAL AND MECHA 4. BI-POLAR IONIZATION SYSTEM 5. ALL MANUFACTURERS MUST
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AT BREFLUEN TO A TACK TO A TACK TO A TO	EACH ENTERING AIR TEMPERATURE ENTERING DRY BULB TEMPERATURE ENERGY EFFICIENCY RATIO EFFICIENCY ELEVATION ELECTRICAL ENTERING WET BULB TEMPERATURE ENTERING WATER TEMPERATURE EXISTING EXHAUST FURNISH AND INSTALL FLEXIBLE DUCT FEET PER MINUTE FEET PER SECOND FEET GENERAL CONTRACTOR GALLON PER MINUTE HORSE POWER HOUR HUMIDISTAT HEATING, VENTILATION AND AIR CONDITIONING HEATING WATER HEAVING WATER HEAVING WATER HOUR POUNDS LEAVING WATER TEMPERATURE LEAVING WATER TEMPERATURE LEAVING WATER TEMPERATURE MIXED AIR TEMPERATURE MAXIMUM BTU/HR X 1,000 MECHANICAL MOTORIZED VOLUME DAMPER NOT APPLICABLE NOT IN CONTRACT NOT O SCALE OUTSIDE AIR PHASE (ELECTRIC) POINT OF CONNECTION POUNDS PER SQUARE INCH POLYVINYL CHLORIDE RETURN AIR RELATIVE HUMIDITY		MARK RANGE CFM AP-A 0-6,000 NOTES: 1. FURNISH WITH CONTROL BOX 2. MOUNT BI-POLAR ION GENERA 3. IF CONTRACTOR SUBSTITUTES ALL ELECTRICAL AND MECHA 4. BI-POLAR IONIZATION SYSTEM 5. ALL MANUFACTURERS MUST 6. FURNISH WITH BAS ALARM CO MARK LOCATION TYPE
EAT BERF LEUWS TELEUWS	EACH ENTERING AIR TEMPERATURE ENTERING DRY BULB TEMPERATURE ENERGY EFFICIENCY ELEVATION ELECTRICAL ENTERING WET BULB TEMPERATURE ENTERING WATER TEMPERATURE ENTERING WATER TEMPERATURE ENTERING WATER TEMPERATURE EXISTING EXHAUST FURNISH AND INSTALL FLEXIBLE DUCT FEET PER MINUTE FEET PER SECOND FEET GENERAL CONTRACTOR GALLON PER MINUTE HORSE POWER HOUR HUMIDISTAT HEATING, VENTILATION AND AIR CONDITIONING HEATING WATER HEATING WATER HEATING WATER HEATING WATER KITCHEN EQUIPMENT CONTRACTOR KILOWATT KILOWAT KILOWATT KILOWATT KILOWATT KILOWAT KILOWAT KILOWAT KILOWAT KILO		MARK RANGE CFM AP-A 0-6,000 NOTES: 1. FURNISH WITH CONTROL BOX 2. MOUNT BI-POLAR ION GENERA 3. IF CONTRACTOR SUBSTITUTES ALL ELECTRICAL AND MECHA 4. BI-POLAR IONIZATION SYSTEM 5. ALL MANUFACTURERS MUST 6. FURNISH WITH BAS ALARM CO
EAT BERF CENTER FOR CONTROL OF POSICE AT MENT OF THE STANDER FOR THE STANDER F	EACH ENTERING AIR TEMPERATURE ENTERING DRY BULB TEMPERATURE ENERGY EFFICIENCY RATIO EFFICIENCY ELEVATION ELECTRICAL ENTERING WET BULB TEMPERATURE ENTERING WATER TEMPERATURE EXISTING EXHAUST FURNISH AND INSTALL FLEXIBLE DUCT FEET PER MINUTE FEET PER SECOND FEET GENERAL CONTRACTOR GALLON PER MINUTE HOUR HUMIDISTAT HEATING, VENTILATION AND AIR CONDITIONING HEATING WATER RETURN INDOOR AIR QUALITY INCHES KITCHEN EQUIPMENT CONTRACTOR KILOWATT KILOWATT HOUR POUNDS LEAVING DRY BULB TEMPERATURE LEAVING WET BULB TEMPERATURE LEAVING WET BULB TEMPERATURE MIXED AIR TEMPERATURE M		MARK RANGE CFM AP-A 0-6,000 NOTES: 1. FURNISH WITH CONTROL BOX 2. MOUNT BI-POLAR ION GENERA 3. IF CONTRACTOR SUBSTITUTES ALL ELECTRICAL AND MECHA 4. BI-POLAR IONIZATION SYSTEM 5. ALL MANUFACTURERS MUST 6. FURNISH WITH BAS ALARM CO MARK LOCATION TYPE AS-1 MECH. ROOM ASME CLA

ALL ELECTRICAL AND MECHANICAL CHANGES.

FURNISH WITH BAS ALARM CONTACTS.

(NOIL.	ALL	SIMBOLS	SHOWIN	AILE	NOI	NECESSANIET	USED	ON	DIVAMINGS

EXISTING TO REMAIN

VACUUM VARIABLE AIR VOLUME

VOLUME DAMPER (MANUAL)
WATT

		RO	OOFTOP UNIT	SCHEDULE			
	DESIGNATION	RTU-A1	RTU-2	RTU-6	RTU-A2	RTU-CA1	RTU-C1 & C2
	RECOMMENDED MANUFACTURER	AAON	AAON	AAON	AAON	AAON	AAON
J	MODEL NO.	RQ-003	RN-007	RQ-004	RQ-005	RNA-013	RN-008
GENERAL	NOMINAL TONS	3	6	4	5	12.5	7.5
	TOTAL DESIGN CFM	1,200	2,400	1,600	2,000	5,000	3,000
_	EER/SEER	18.2 SEER	12.2 EER	17.1 SEER	16.75 SEER	11.56 EER	11.4 EER
	APPROXIMATE DIMENSIONS (INCHES)	90X45X51	90X79X44	90X45X51	90X45X51	110X96X51	90X79X44
	APPROXIMATE WEIGHT (LBS.)	900	1,150	1,000	1,000	1,900	1,250
	EAT - DB/WB, DEG. F.	80/67	80/67	80/67	80/67	80/67	80/67
	MAX. AMBIENT TEMP., DEG. F.	105	105	105	105	105	105
<u> </u>	TOTAL COOLING, BTUH	34,800	75,000	49,500	57,900	153,800	91,200
OLII	SENSIBLE COOLING, BTUH	31,750	57,000	38,700	46,500	141,400	69,400
9	MIN. COIL FACE AREA, SQ. FT.	5.3	8.5	5.3	5.3	14.6	8.5
	MIN. ROWS/MAX, FPI.	3/14	3/14	4/14	4/14	4/14	3/14
	EAT/LAT, DEG. F.	65/90	65/90	N/A	65/90	61/90	60/97
DQ N	MIN. AMBIENT TEMP., DEG. F.	17	17	N/A	17	17	17
ATI	GAS INPUT (BTU/HR)	60,000	90,000	N/A	100,000	195,000	150,000
閚	MODELNO. RQ-003 RN-007 RQ-004 I NOMINAL TONS 3 6 4 TOTAL DESIGN CFM 1,200 2,400 1,600 EER/SEER 18.2 SEER 12.2 EER 17.1 SEER 16 APPROXIMATE DIMENSIONS (INCHES) 90X45X51 90X79X44 90X45X51 90 APPROXIMATE WEIGHT (LBS.) 900 1,150 1,000	81,000	156,000	120,000			
APPROXIMATI EAT - DB/WB, I MAX. AMBIEN TOTAL COOLIN SENSIBLE COOL MIN. COIL FAC MIN. ROWS/MA EAT/LAT, DEG. MIN. AMBIENT GAS INPUT (BT HEAT OUTPUT AFUE % EXT. S.P., IN W. DRIVE TYPE FAN MOTOR, FI VOLTS/PHASE	AFUE%	81	81	N/A	80	80	80
ÂN	EXT. S.P., IN W.G.	1.6	1.6	1.6	2.4	1.4	2.4
AP. I	DRIVE TYPE	DIRECT	DIRECT	DIRECT	DIRECT	DIRECT	DIRECT
ΕV	FAN MOTOR, HP	1	2	2	2	5	3
	VOLTS/PHASE	460/3	460/3	460/3	460/3	460/3	460/3
	NO. OF COMPRESSORS	1	1	1	1	2	1
ÄL	COMPRESSOR RLA	5.7	9.9	6.4	7.6	9.5 EACH	12
IRIC	NO. OF COND. FANS	1	1	1	1	2	2
ELECTRICAL	COND. FAN FLA	1.6	1.6	1.6	1.6	3.6 EACH	1.6
田	EVAP. FAN FLA	3.5	3.4	3.4	3.4	7.6	4.8
	MCA	12	17	13	15	36	23
_	МОСР	15	25	15	20	45	25
	REMARKS	NOTES 1-10	NOTES 1-10	NOTES 1-10	NOTES 1-10	NOTES 1-10	NOTES 1-10

FURNISH W/ 5 YEAR COMPRESSOR WARRANTY.

FURNISH W/ CONTROLLER AND NEW SENSOR COMPATIBLE WITH THE EXISTING BMS.

FURNISH W/ MOTORIZED OUTSIDE AIR DAMPERS. FURNISH W/ 10 YEAR HEAT EXCHANGER WARRANTY.

FURNISH W/ HAIL GUARDS ON CONDENSER COIL. FURNISH UNIT SCHEDULED OR EQUAL BY AAON.

FURNISH W/ DOWNFLOW ROOF CURBS, MIN. 14 IN. HIGH, MEETING NRCA REQUIREMENTS.

FURNISH W/ DRYBULB 55 DEG. F. (A DJUSTA BLE) CONTROLLED ECONOMIZER WITH BAROMETRIC RELIEF DAMPER. FURNISH W/ ECONOMIZER FAULT DETECTION AND DIA GNOSTICS (FDD)

9. FURNISH W/ HOT GAS REHEAT.

AIR PURIFICATION SCHEDULE

MOUNT BI-POLAR ION GENERATOR PER MANUFACTURER RECOMMENDATIONS AND WHERE INDICATED ON PLANS.

IF CONTRACTOR SUBSTITUTES BASIS IOF DESIGN WITH OTHER MANUFACTURER, THEN CONTRACTOR SHALL COORDINATE

BI-POLAR IONIZATION SYSTEMS REQUIRING PERISHABVLE GLASS TUBES ARE UNACCEPTABLE AND SHALL BE REJECTED.

VAC WATTS

24 BIOCLIMATIC ACTIVEOX #AOXR05-24

AIR FLOW | DROP | VOLTAGE |

FURNISH WITH CONTROL BOX #AOXBMS AND INSTALL PER MANUFACTURER RECOMMENDATIONS.

ALL MANUFACTURERS MUST PASS UL-867-2007 OZONE CHAMBER TESTING BUY EITHER UL OR ETL.

AIR SEPARATOR SCHEDULE

SQ. IN.

FURNISH AND INSTALL AIR SEPARATOR PER MANUFACTURER RECOMMENDATIONS.

EXPANSION TANK SCHEDULE

FURNISH AND INSTALL TANK IN VERTICAL POSITION ONLY PER MANUFACTURER RECOMMENDATIONS.

TANK FLOODED WORKING

LBS.

VOLUME WEIGHT

GAL.

SCREEN SHIPPING WORKING FREE AREA | WEIGHT | PRESS.

LBS.

PRESS.

PSI

REMARKS

ELBI HTL-1200, NOTE 1

0.05

CFM IN. W.C.

10. FURNISH WITH DUCT SMOKE DETECTOR IN THE SUPPLY AND RETURN END OF THE UNIT. DUCT SMOKE DETECTOR SHALL BE POWERD FROM THE FIRE ALARM SYSTEM AND NOT THE UNIT.

				DI	FFUSER & GRI	LLE SCI	HEDULE	
	CFM					DUCT CONN.		
MARK	RANGE	S	R	Е	TYPE	SIZE	PATTERN	REMARKS
A	0 - 150	X			LA Y-IN OR SURFACE	6	NOTE 2	TITUS TMS, 24X24 MODULE
В	151 - 250	X			LA Y-IN OR SURFACE	8	NOTE 2	TITUS TMS, 24X24 MODULE
С	251 - 400	X			LA Y-IN OR SURFACE	10	NOTE 2	TITUS TMS, 24X24 MODULE
D	401 - 600	X			LA Y-IN OR SURFACE	12	NOTE 2	TITUS TMS, 24X24 MODULE
F	601 - 800	X			LA Y-IN OR SURFACE	14	NOTE 2	TITUS TMS, 24X24 MODULE
G	801 - 1050	X			LA Y-IN OR SURFACE	15	NOTE 2	TITUS TMS, 24X24 MODULE
Н	0 -150	X			LA Y-IN OR SURFACE	6	NOTE 2	TITUS TMS, 12X12 MODULE
L	0 - 1175	X			SIDEWALL	18X12	2-WAY	TITUS 271FS W/ OBD
M	1176 - 1500	X			SIDEWALL	24X12	2-WAY	TITUS 271FS W/ OBD
N	1501 - 2100	X			SIDEWALL	34X12	2-WAY	TITUS 271FS W/ OBD
Q	0 - 1200		X	X	SIDEWALL	24X12	N.A.	TITUS 350FL W/ OBD
R	0 - 1480		X	X	SIDEWALL	30X12	N.A.	TITUS 350FL W/ OBD
S	0 - 1750		X	X	SIDEWALL	36X12	N.A.	TITUS 350FL W/ OBD
T	0 - 2000		X	X	SIDEWALL	24X24	N.A.	TITUS 350FL W/ OBD
U	0 - 2025		X	X	SIDEWALL	36X14	N.A.	TITUS 350FL W/ OBD
V	0 - 3010		X	X	SIDEWALL	48X16	N.A.	TITUS 350FL W/ OBD
X	0 - 450		X	X	SURFACE	10X10	N.A.	TITUS 350FL W/ OBD
Y	451 - 1000		X	X	SURFACE	16X16	N.A.	TITUS 350FL W/ OBD
Z	0 - 400		X		DOOR	24X12	N.A.	TITUS T700

- ALL AIR FLOWS ARE LISTED IN CFM; ALL SIZES IN INCHES.
- PATTERN IS FOUR-WAY UON ON PLANS.
- FURNISH WITH A FRAME COMPATIBLE WITH THE CEILING OR WALL IN WHICH THE DEVICE IS MOUNTED. (APPLIES TO ALL MAKE RUNOUT AND FLEX OR HARD DUCT CONNECTION TO AIR DEVICE SAME SIZE AS SCHEDULED DUCT CONNECTION SIZE
- FOR SLOT DIFFUSERS FURNISH AND INSTALL MANUFACTURER'S PLENUM EQUAL TO TITUS FBP. FURNISH AND INSTALL "MUD-IN" TYPE 55 BORDER FOR HARD CEILINGS AND TYPE 11 FOR A COUSTICAL CEILINGS.
- EQUIVALENT MODELS BY KRUEGER, METALAIRE, OR PRICE MAY BE ACCEPTABLE PENDING SUBMITTAL REVIEW.

SINGLE DUCT VAV TERMINAL UNIT SCHEDULE										
			PRIMARY	Y AIR DATA		HEAT	ΓING COIL			
MARK	ТҮРЕ	INLET SIZE IN.	CFM RANGE MIN./MAX	MAX A.D.P. IN. W.G.	MAX. N.C.	GPM	HEATING CAPACITY MBTUH	REMARKS		
VA V-A	SINGLE DUCT HOT WATER HEAT	8	400/900	.30	30	1.71	19.22	ENVIRO-TEC SDR NOTES 1-7		
VA V-B	SINGLE DUCT HOT WATER HEAT	10	400/1050	.30	30	1.24	17.03	ENVIRO-TEC SDR NOTES 1-7		
VA V-C	SINGLE DUCT HOT WATER HEAT	10	400/1400	.30	30	0.71	15.94	ENVIRO-TEC SDR NOTES 1-7		
VA V-D	SINGLE DUCT HOT WATER HEAT	12	400/1900	.30	30	1.21	19.11	ENVIRO-TEC SDR NOTES 1-7		
VA V-F	SINGLE DUCT HOT WATER HEAT	12	400/2000	.30	30	1.21	19.11	ENVIRO-TEC SDR NOTES 1-7		
VA V-G	SINGLE DUCT HOT WATER HEAT	14	400/3000	.30	30	1.08	20.64	ENVIRO-TEC SDR NOTES 1-7		
		1	111,000							

- BASED ON 20°F WATER TEMP, DIFFERENCE AND 30°F TEMP, RISE ON THE MINIMUM CFM RANGE. FURNISH DDC ROOM SENSOR AND CONNECT ONTO THE BUILDING MANAGEMENT SYSTEM.
- FURNISH WITH 24 VOLT CONTROL TRANSFORMER.
- ALL CONTROL AND POWER WIRING BY THE MECHANICAL CONTRACTOR.
- PROVIDE SOUND ATTENUATOR BOOT. NC LEVEL SCHEDULED IS DISCHARGE SOUND LEVEL WITHOUT SOUND ATTENUATOR.
- CONTROLS SHALL BE FURNISHED AND SHIPPED TO VAVBOX FACTORY BY CONTROLS CONTRACTOR FOR FACTORY MOUNTING AND WIRING. CONTROLS CONTRACTOR SHALL FURNISH AND INSTALL A 2-WAY ELECTRIC MODULATING CONTROL VALVE, UNLESS OTHERWISE NOTED.

						FAN SO	CHEDU	JLE			
MARK	SERVING	TYPE	CFM	STATIC PRESS IN. H20	DRIVE TYPE	MOTOR HP	VOLTS/ PH	MAX. RPM	MAX SONES	INTERLOCK WITH	REMARKS
EF-1	NURSE ISOLATION	INLINE	175	0.380	DIRECT	80 WATTS	120/1	1550	5.9	SEE NOTE 1	EQUAL TO GREENHECK SQ-80, NOTE 2
EF-2	RESTROOM	CEILING CABINET	75	0.380	DIRECT	80 WATTS	120/1	950	1.0	SEE NOTE 1	SIMILAR TO GREENHECK SQ-70-VG, NOTE 3

DESIGNATION

NOMINAL TONS

TOTAL DESIGN CFM

FAN, VOLTS/PHASE

FAN MOTOR FLA

WEIGHT, LBS.

MODEL NO.

REMARKS

DESIGNATION

VOLTS/PHASE

MANUFACTURER

MODEL NO.

WEIGHT, LBS.

MANUFACTURER

TOTAL COOLING, BTUH

TOTAL HEATING, BTUH

- 1. FAN SHALL BE CONTROLLED BY AN OCCUPANCY SENSOR. REFER TO ELECTRICAL DRAWINGS.
- FURNISH WITH MANUFACTURER'S BACKDRAFT DAMPER, SOLID STATE SPEED CONTROLLER, AND INTEGRAL ELECTRICAL DISCONNECT FACTORY MOUNTED.

3. FURNISH WITH MANUFACTURER'S BACKDRAFT DAMPER, SOLID STATE SPEED CONTROLLER, GRILLE, AND INTEGRAL ELECTRICAL DISCONNECT FACTORY MOUNTED.

	AIR HANDLING HOT WATER COIL SCHEDULE											
			-	HEATING C								
		COIL	EAT	MIN. HTG	EWT	HW	MIN#	MIN. FACE				
MARK	SERVING	CFM	°F	BTUH	°F	GPM	ROWS	AREA SF	REMARKS			
HWC-1-	(E) AHU-1	3,000	60	100,390	130	6.8	4	5.9	CARRIER # 28MH , NOTES 1-4			

INSTALL PER MANUFACTURER RECOMMENDATIONS.

FURNISH PUMP WITH VFD.

- 1. UNIT LISTED INDICATES BASIS OF DESIGN. REFER TO SPECIFICATIONS FOR ACCEPTABLE MANUFACTURERS.
- FURNISH W/ FREEZE PROTECTION FOR WATER PIPING AND COILS. FURNISH UNIT WITH STAINLESS STEEL COIL CASINGS.
- REFER TO SPECIFICATIONS FOR MORE INFORMATION.

			Н	IEAT E	XCHAN	NGER SC	HEDUL	LE		
			STEAM	STEAM	STEAM	WATER	WATER	WATER	HEAT	
			INLET	OUTLET	FLOW	FLOW	INLET	OUTLET	LOAD	
MARK	LOCATION	TYPE	TEMP. °F	TEMP. °F	LB/HR	GPM	TEMP. °F	TEMP. °F	BTU/HR	REMARKS
HX-1	MECH. ROOM	SHELL & TUBE	249.7	249.7	3,638	175	140	180	3,440,518	ARMSTRONG W S-0805-200-1

FURNISH AND INSTALL PER MANUFACTURER RECOMMENDATIONS.

				PUMF	SCF	<u>IED</u>	ULE		
			SUCTION X			М	OTOR		
		HEAD	DISCHARGE		PUMP	SIZE	VOLTS/	INTERLOCK	
MARK	GPM	FT. H2O	(INCHES)	TYPE	RPM	НР	PH	W/	REMARKS
HWP-1	175	85	3 X 2.5	BASE-MOUNTED, END SUCTION	1,800	10	460/3	BMS	BELL & GOSSETT E-1510 2.5BB, NOTES 1 & 2
HWP-2	175	85	3 X 2.5	BASE-MOUNTED, END SUCTION	1,800	10	460/3	BMS	BELL & GOSSETT E-1510 2.5BB, NOTES 1 & 2
CHWP-1	360	135	3 X 2.5	BASE-MOUNTED, END SUCTION	3,600	20	460/3	BMS	BELL & GOSSETT E-1510 2.5AC, NOTES 1 & 2
CHWP-2	360	135	3 X 2.5	BASE-MOUNTED, END SUCTION	3,600	20	460/3	BMS	BELL & GOSSETT E-1510 2.5AC, NOTES 1 & 2
NOTES:									

1. FURNISH W/ 10-YEAR PARTS AND COMPRESSOR WARRANTY. 2. FURNISH W/ WALL MOUNTED THERMOSTAT.

3. FURNISH FACTORY DISCONNECT FOR INDOOR UNIT 4. FURNISH CONDENSING UNIT W/ HAIL GUARDS.

5. FURNISH INDOOR AIR HANDLING UNIT W/ CONDENSATE PUMP. FURNISH CONDENSATE LINE WITH TRAP OR INLINE CHECK VALVE PER IMC REQUIREMENTS.

MINI-SPLIT SYSTEM SCHEDULE

AC - 101 & 101A

CEILING CASSETTE

600

18.000

23,000

208/1

0.28

14 4

9.2

TRANE

TPLA0A0181EA80A

CU- 101 & 101A

208/1

TRANE

TRUZA0181KA70NA

AC-VEST

CEILING CASSETTE

400

12,000

14,000

208/1

0.19

21.3

10.2

TRANE

TPLA0A0121EA80A

CU-VEST

208/1

28

TPUZA 12NKA 7

AC-MDF

920

36,000

N/A

208/1

0.57

18.8

N/A

50

TRANE

T'PKA0A0361KA7

CU-MDF

208/1

TRANE

TRUYA 0361KA 70NA

WALL MOUNTED


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					SUP	PLY FA	N				RETUI	RN FAN	1				ELEC	TRICA	L					(COOLING C	OIL (CHI	ILLED	WATE	₹)			I	HEATING	COIL (HEATII	NG WAT	ER)		
			WEIGHT	TOT. AIR	OA AIR	TSP	# OF	г МОТ	OR I	RA	TSP	# OF	MOTOI	₹	CIRC	ЛТ 1		CIF	RCUIT	2		COI	L EDB	EWB	SENSIBLE	TOTAL	EWT	CHW	MIN. #	MIN. FACI	ECOII	EAT	MIN. HT	G EW	HW	MIN #	# MIN.	FACE	
M	ARK	SERVING	LBS	CFM	CFM	IN. H2	O FANS	S H	P C	CFM II	N. H2O	FANS	HP	FLA	MCA	FUSE S	IZE FL	A MC	A FU	JSE SIZE	VOLT/P	H CFM	м°F	°F	BTUH	BTUH	°F	GPM	ROWS	AREA SF	CFM	f °F	BTUH	°F	GPM	1 ROW	S ARE	A SF	REMARKS
Α	HU-5 C	LASSROOMS	3,940	6,000	600	4.6	1	7	5 6	5,000	1.9	1	8	8.13	10.16	15	1	1 13.	75	20	460/3	6,000	0 80	67	165,350	227,570	42	30.24	6	12.3	6,000	45	179,650	180	17.94	1	11.	.25	TRANE CSAA012 PERFORMANCE CLIMATE CHANGER, NOTES 1-11
																																						·	

MECH. ROOM | BLADDER

- 1. UNIT LISTED INDICATES BASIS OF DESIGN. REFER TO SPECIFICATIONS FOR ACCEPTABLE MANUFACTURERS.
- FURNISH W/ 14" MINIMUM HEIGHT ROOF CURB. FURNISH W/ FACTORY DISCONNECT SWITCH.

FURNISH WITH STAINLESS STEEL STRAINER.

- 4. FURNISH W/ 2-INCH / 4" FILTER RACK WITH MERV 8 / MERV 11 FILTERS OR EQUIVALENT.
- FURNISH W/ DOUBLE WALL CONSTRUCTION.
- FURNISH W/ FREEZE PROTECTION FOR WATER PIPING AND COILS.
- 7. FURNISH FANS WITH SPRING ISOLATORS. 8. ALL UNITS SHALL BE FURNISHED WITH A 120-V CONVINIENCE OUTLET WIRED SEPARATE FROM THE UNIT.
- 9. EACH FAN MOTOR SHALL BE FURNISHED WITH A VFD. 10. FURNISH UNIT WITH STAINLESS STEEL COIL CASINGS.
- 11. REFER TO SPECIFICATIONS FOR MORE INFORMATION.

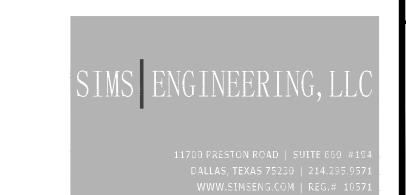

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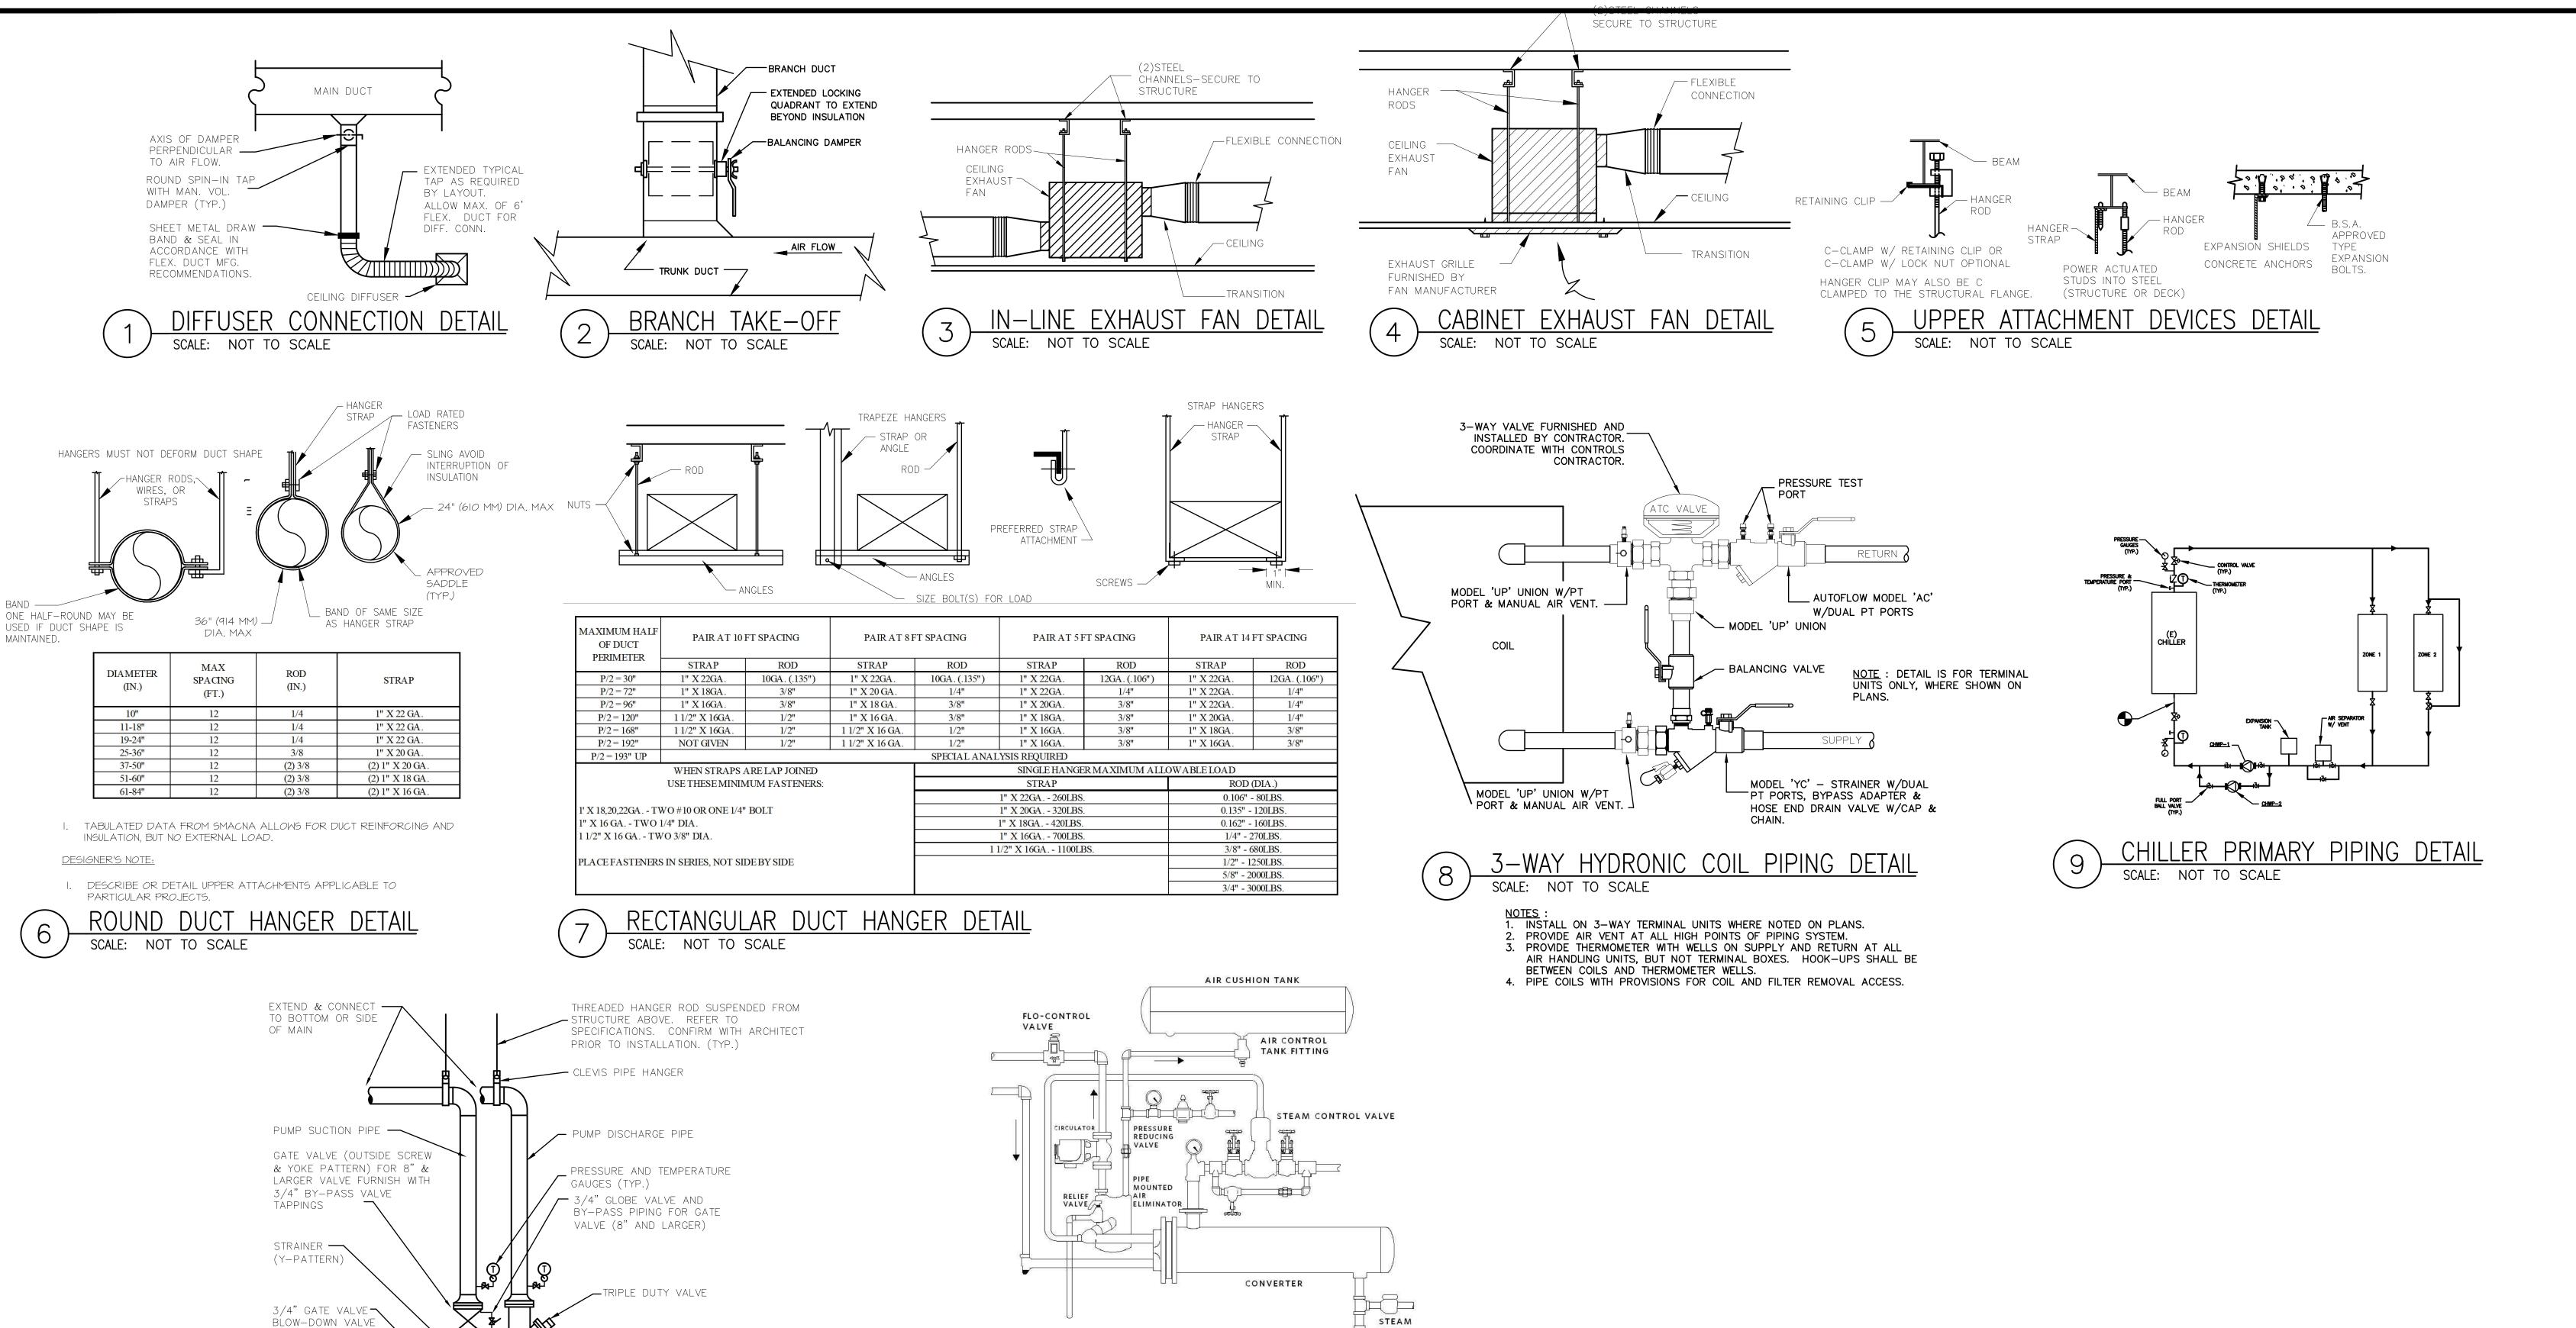
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DETAILS & SCHEDULES MECHANICAL

Sheet Number



SHELL & TUBE HEAT EXCHANGER DETAIL

HOSE ADAPTOR — COUPLING & CAP

SUCTION DIFFUSER -

FIELD FABRICATED SUPPORT ____ PIPE WELD TO ELBOW HEEL

COMBINE GALV. CASING SEAL LEAK-OFF AND BEDPLATE DRAINS

W/STRAINER

& BASE PLATE

SCALE: NOT TO SCALE

BASE TO BE SHIMMED

LEVELED, BOLTED & GROUTED TO INERTIA

INERTIA BASE

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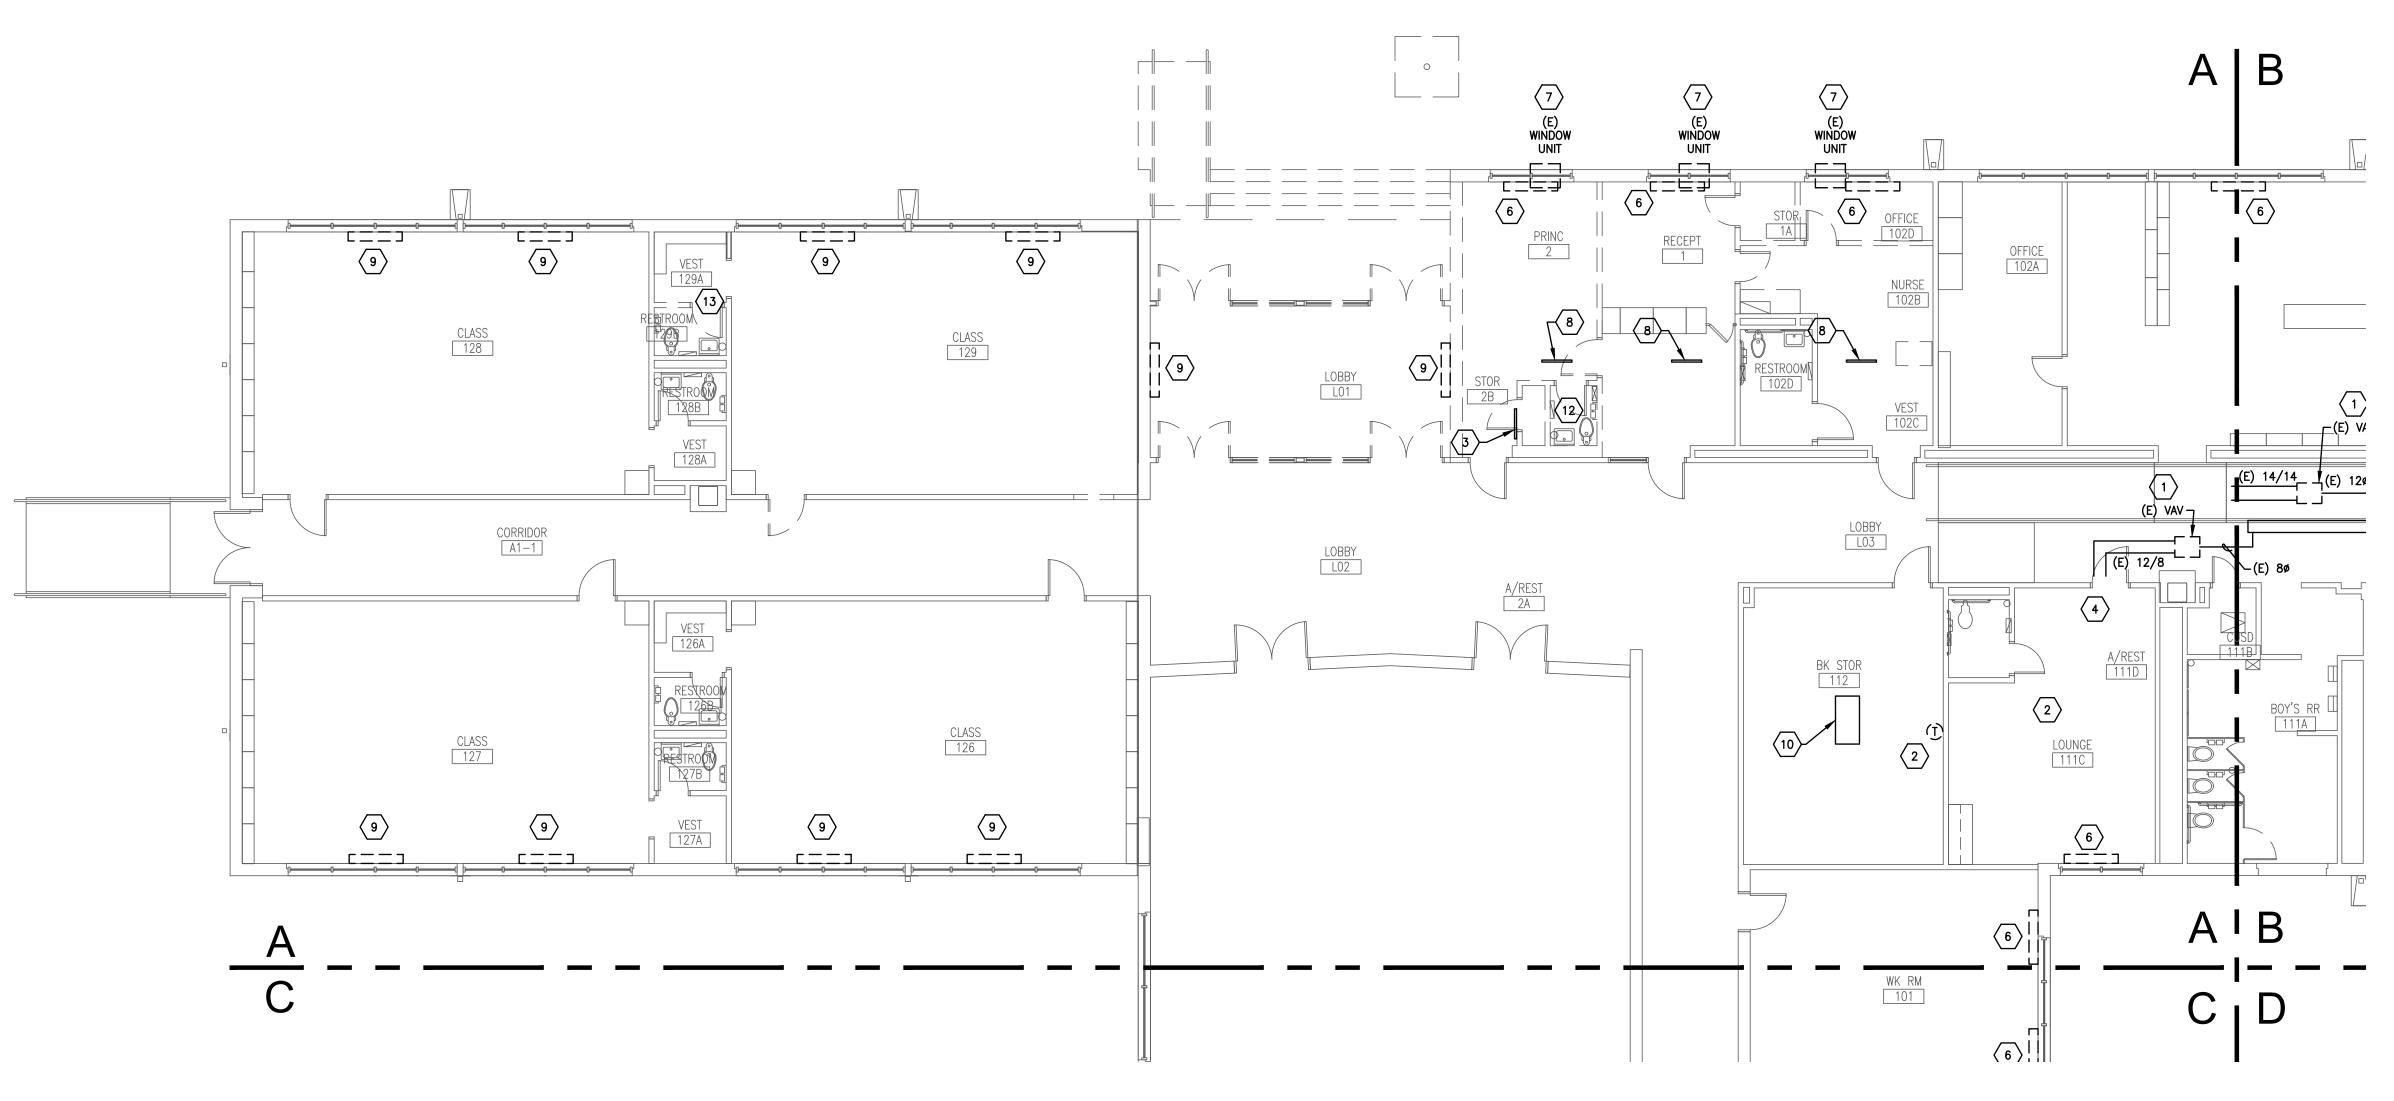
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MECHANICAL

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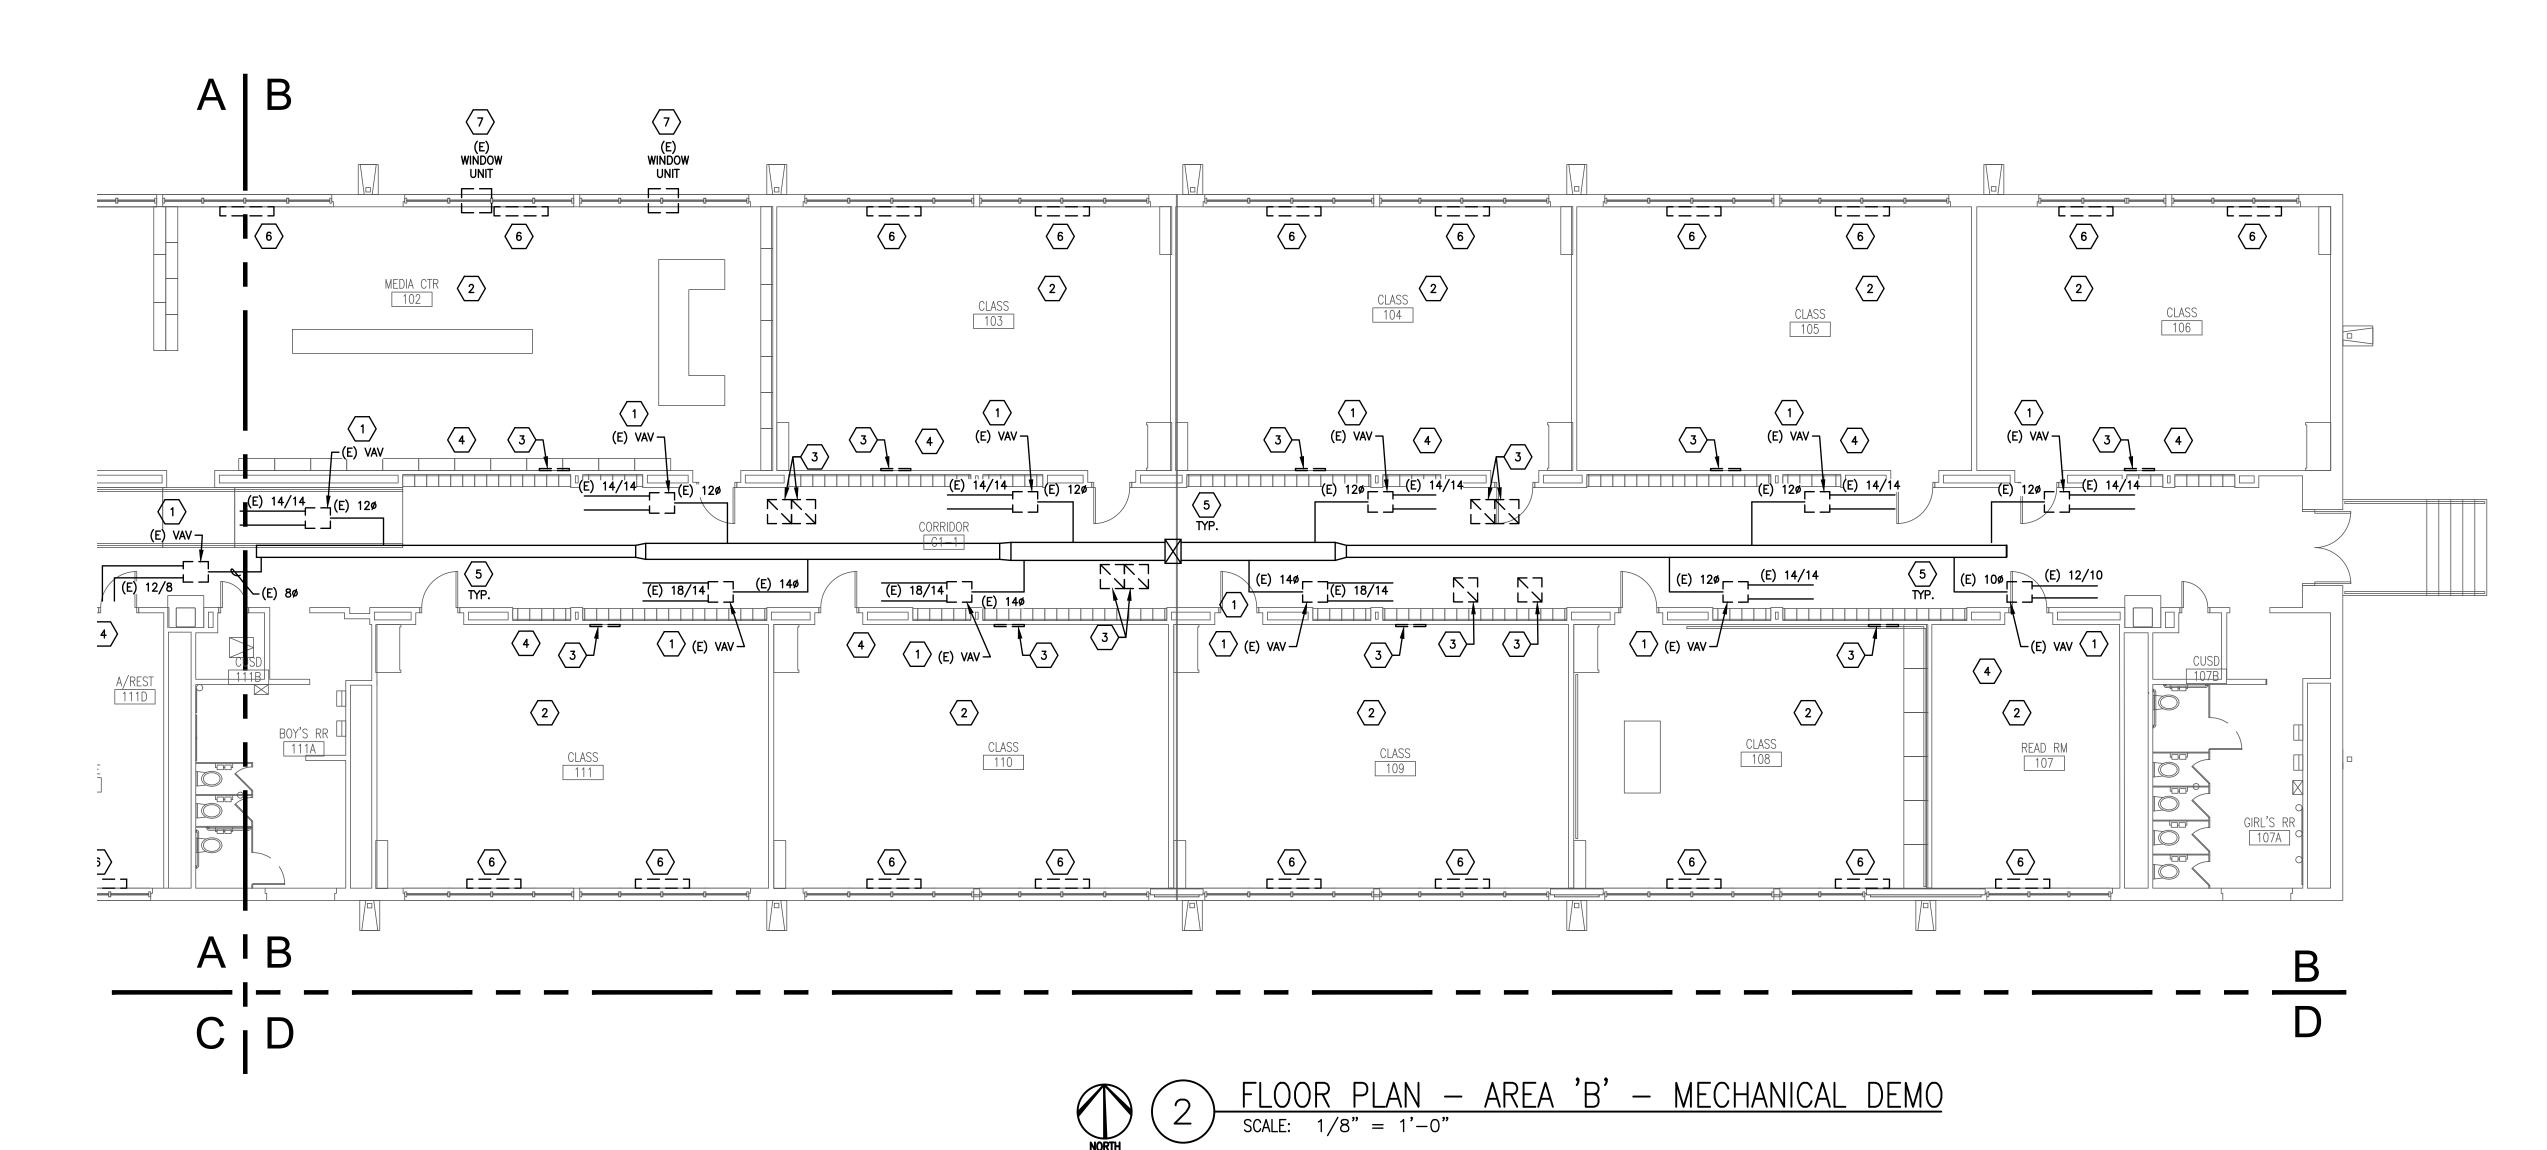
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FLOOR PLAN - AREA 'A' - MECHANICAL DEMO

SCALE: 1/8" = 1'-0"



GENERAL MECHANICAL NOTES

- 1. EVERY NOTE INDICATED BY SYMBOL IS NOT NECESSARILY USED ON THIS SHEET.
- 2. CONTRACTOR SHALL PATCH AND FILL ROOF, CEILING, AND WALLS AS NEEDED.
- 3. THE DISTRICT SHALL HAVE THE RIGHT TO RETAIN POSSESSION OF ALL REMOVED OR DEMOLISHED ITEMS FOR REUSE OR SALVAGE. COORDINATE WITH THE DISTRICT
- NOTES INDICATED BY SYMBOL , #
- 1. REMOVE EXISTING VAV BOX. PREPARE EXISTING DUCTWORK FOR RECONNECTION TO NEW VAV BOX AS SHOWN ON THE NEW MECHANICAL PLANS ON THE M2XX SERIES SHEETS.

REPRESENTATIVE ON THE PROJECT TO DETERMINE WHAT TO DO WITH THESE ITEMS.

- 2. REMOVE EXISTING THERMOSTAT IN THIS ROOM.
- 3. REMOVE EXISTING RETURN AIR GRILLE.
- 4. EXISTING SIDEWALL SUPPLY AIR GRILLE SHALL REMAIN.
- 5. EXISTING DUCTWORK MAIN SHALL REMAIN. EXISTING DUCT MAIN SHOWN FOR REFERENCE
- 6. REMOVE EXISTING STEAM CONVECTOR. CAP ASSOCIATED STEAM PIPING BELOW FLOOR. CONTRACTOR SHALL PATCH EXITING STEAM PIPING PENETRATIONS TO MATCH EXISTING CONDITIONS AS NEEDED. REFER TO ARCHITECTURAL FOR MORE INFORMATION ON MATCHING
- 7. REMOVE EXISTING WINDOW UNIT. THE DISTRICT SHALL HAVE THE RIGHT TO RETAIN POSSESSION OF THIS UNIT FOR REUSE OR SALVAGE. COORDINATE WITH THE DISTRICT REPRESENTATIVE ON THE PROJECT TO DETERMINE WHAT TO DO WITH THIS UNIT.
- 8. REMOVE EXISTING SIDEWALL SUPPLY AIR GRILLE.
- 9. REMOVE EXISTING UNIT VENTILATOR. CAP ASSOCIATED HYDRONIC PIPING BELOW FLOOR. CONTRACTOR SHALL PATCH EXITING PIPING PENETRATIONS TO MATCH EXISTING CONDITIONS
- 10. EXISTING CONCENTRIC DIFFUSER AND ASSOCIATED DUCTWORK SHALL REMAIN. PREPARE EXISTING DUCTWORK FOR CONNECTION TO NEW ROOFTOP UNIT.
- 11. REMOVE EXISTING CONCENTRIC DIFFUSER AND ASSOCIATED DUCTWORK.
- 12. REMOVE EXISTING EXHAUST FAN AND ASSOCIATED DUCTWORK. THE DISTRICT SHALL HAVE THE RIGHT TO RETAIN POSSESSION OF THIS FAN FOR REUSE OR SALVAGE. COORDINATE WITH THE DISTRICT REPRESENTATIVE ON THE PROJECT TO DETERMINE WHAT TO DO WITH

13. EXISTING EXHAUST FAN SHALL REMAIN.

- 14. REMOVE EXISTING CHWS/R PIPING TO THIS POINT AND PREPARE FOR CONNECTION TO NEW CHWS/R PIPING AS SHOWN ON 1/M213.
- 15. EXISTING CHILLER SHALL REMAIN.
- 16. REMOVE EXISTING INLINE HYDRONIC PUMP AND PREPARE FOR CONNECTION TO NEW CHWS/R PIPING AS SHOWN ON 1/M213.
- 17. REMOVE EXISTING AIR SEPARATOR AND EXISTING EXPANSION TANK. PREPARE FOR CONNECTION TO NEW CHWS/R PIPING AS SHOWN ON 1/M213.
- 18. DEMO EXISTING BOILER, ASSOCIATED PUMP, ASSOCIATED EXPANSION THANK AND OTHER ASSOCIATED ACCESSORIES. DEMO EXISTING HEATING WATER SUPPLY AND RETURN PIPING TO THE POINT WHERE THEY EXIT THE BOILER ROOM. PREPARE HEATING WATER PIPING FOR CONNECTION TO NEW HEATING WATER SYSTEM. REFER TO M2.X SERIES DRAWINGS FOR MORE INFORMATION REGARDING THE NEW SYSTEM. DEMO EXISTING GAS LINE BACK TO MAIN AND CAP. CAP THE FLUE FOR THIS AND THE NEARBY LOCHINVAR DOMESTIC WATER BOILER BEING REMOVED AS A PART OF THE PLUMBING SCOPE.
- 19. DEMO EXISTING ABANDONED STEAM PIPING BACK TO HEADER AS SHOWN.

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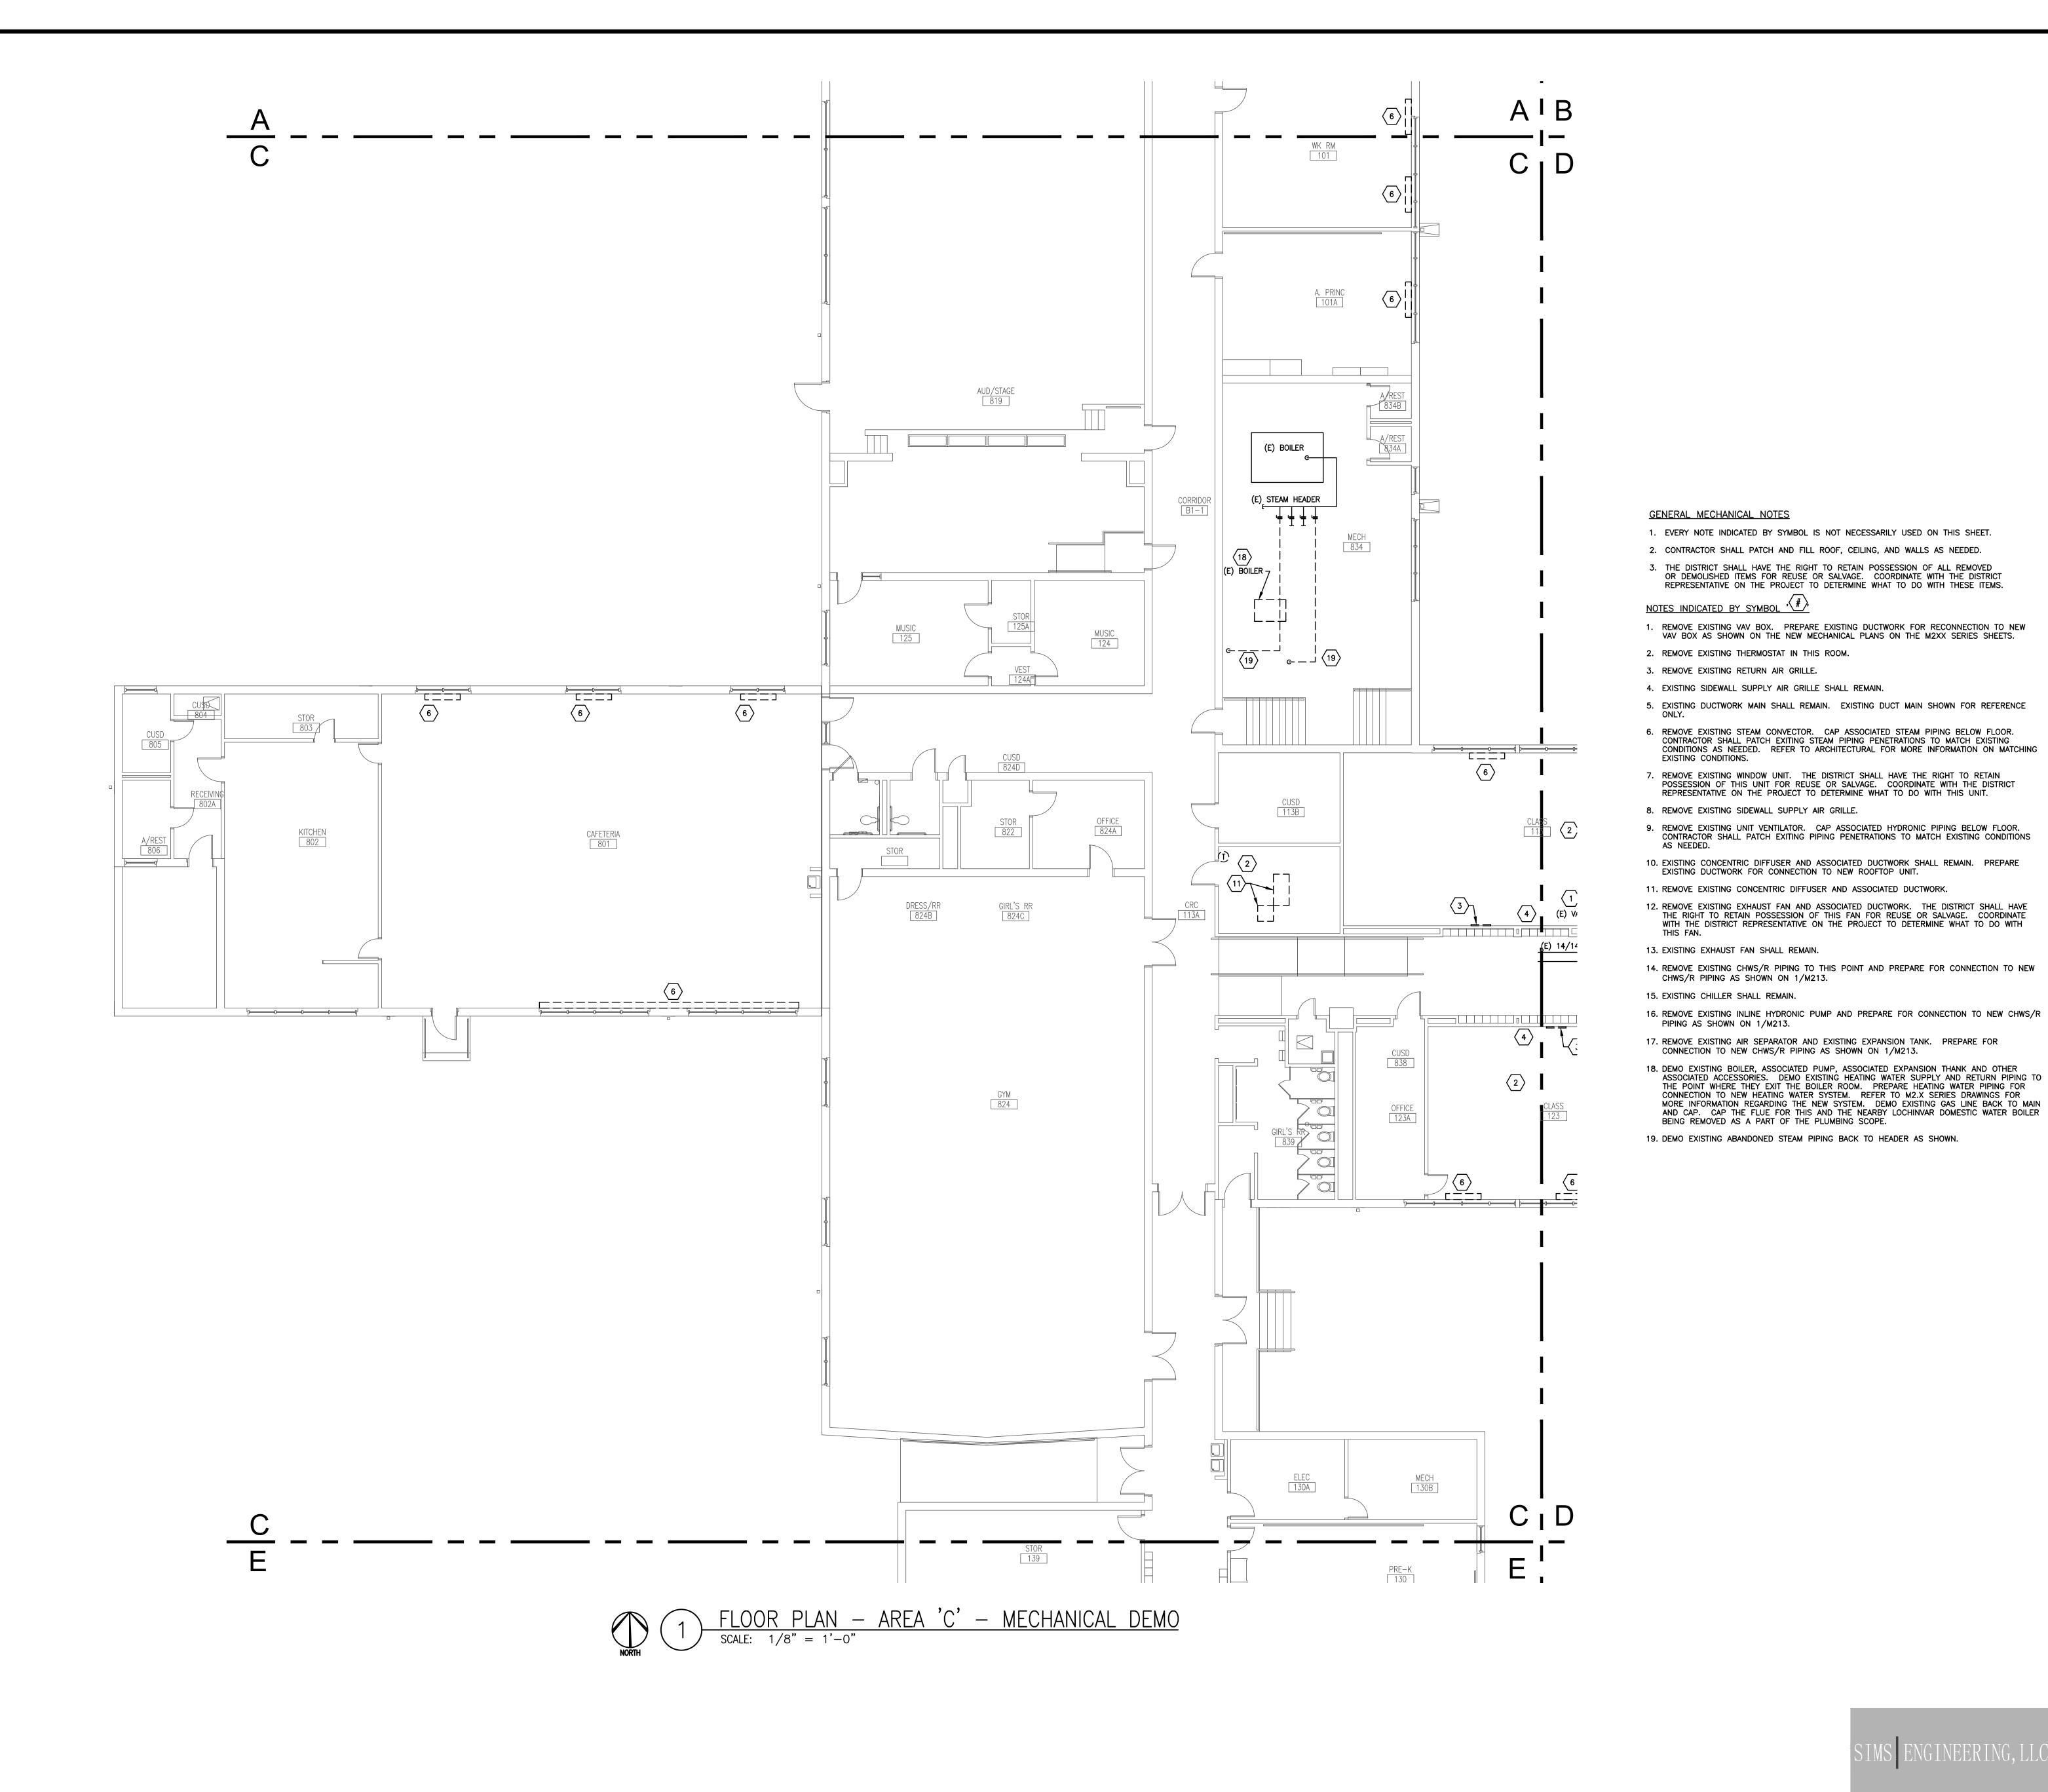
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FLOOR PLAN MECHANICAL DEMO

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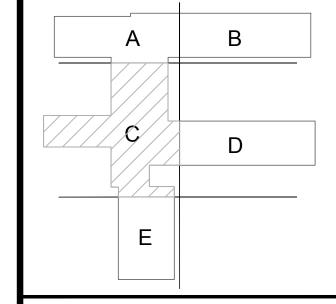
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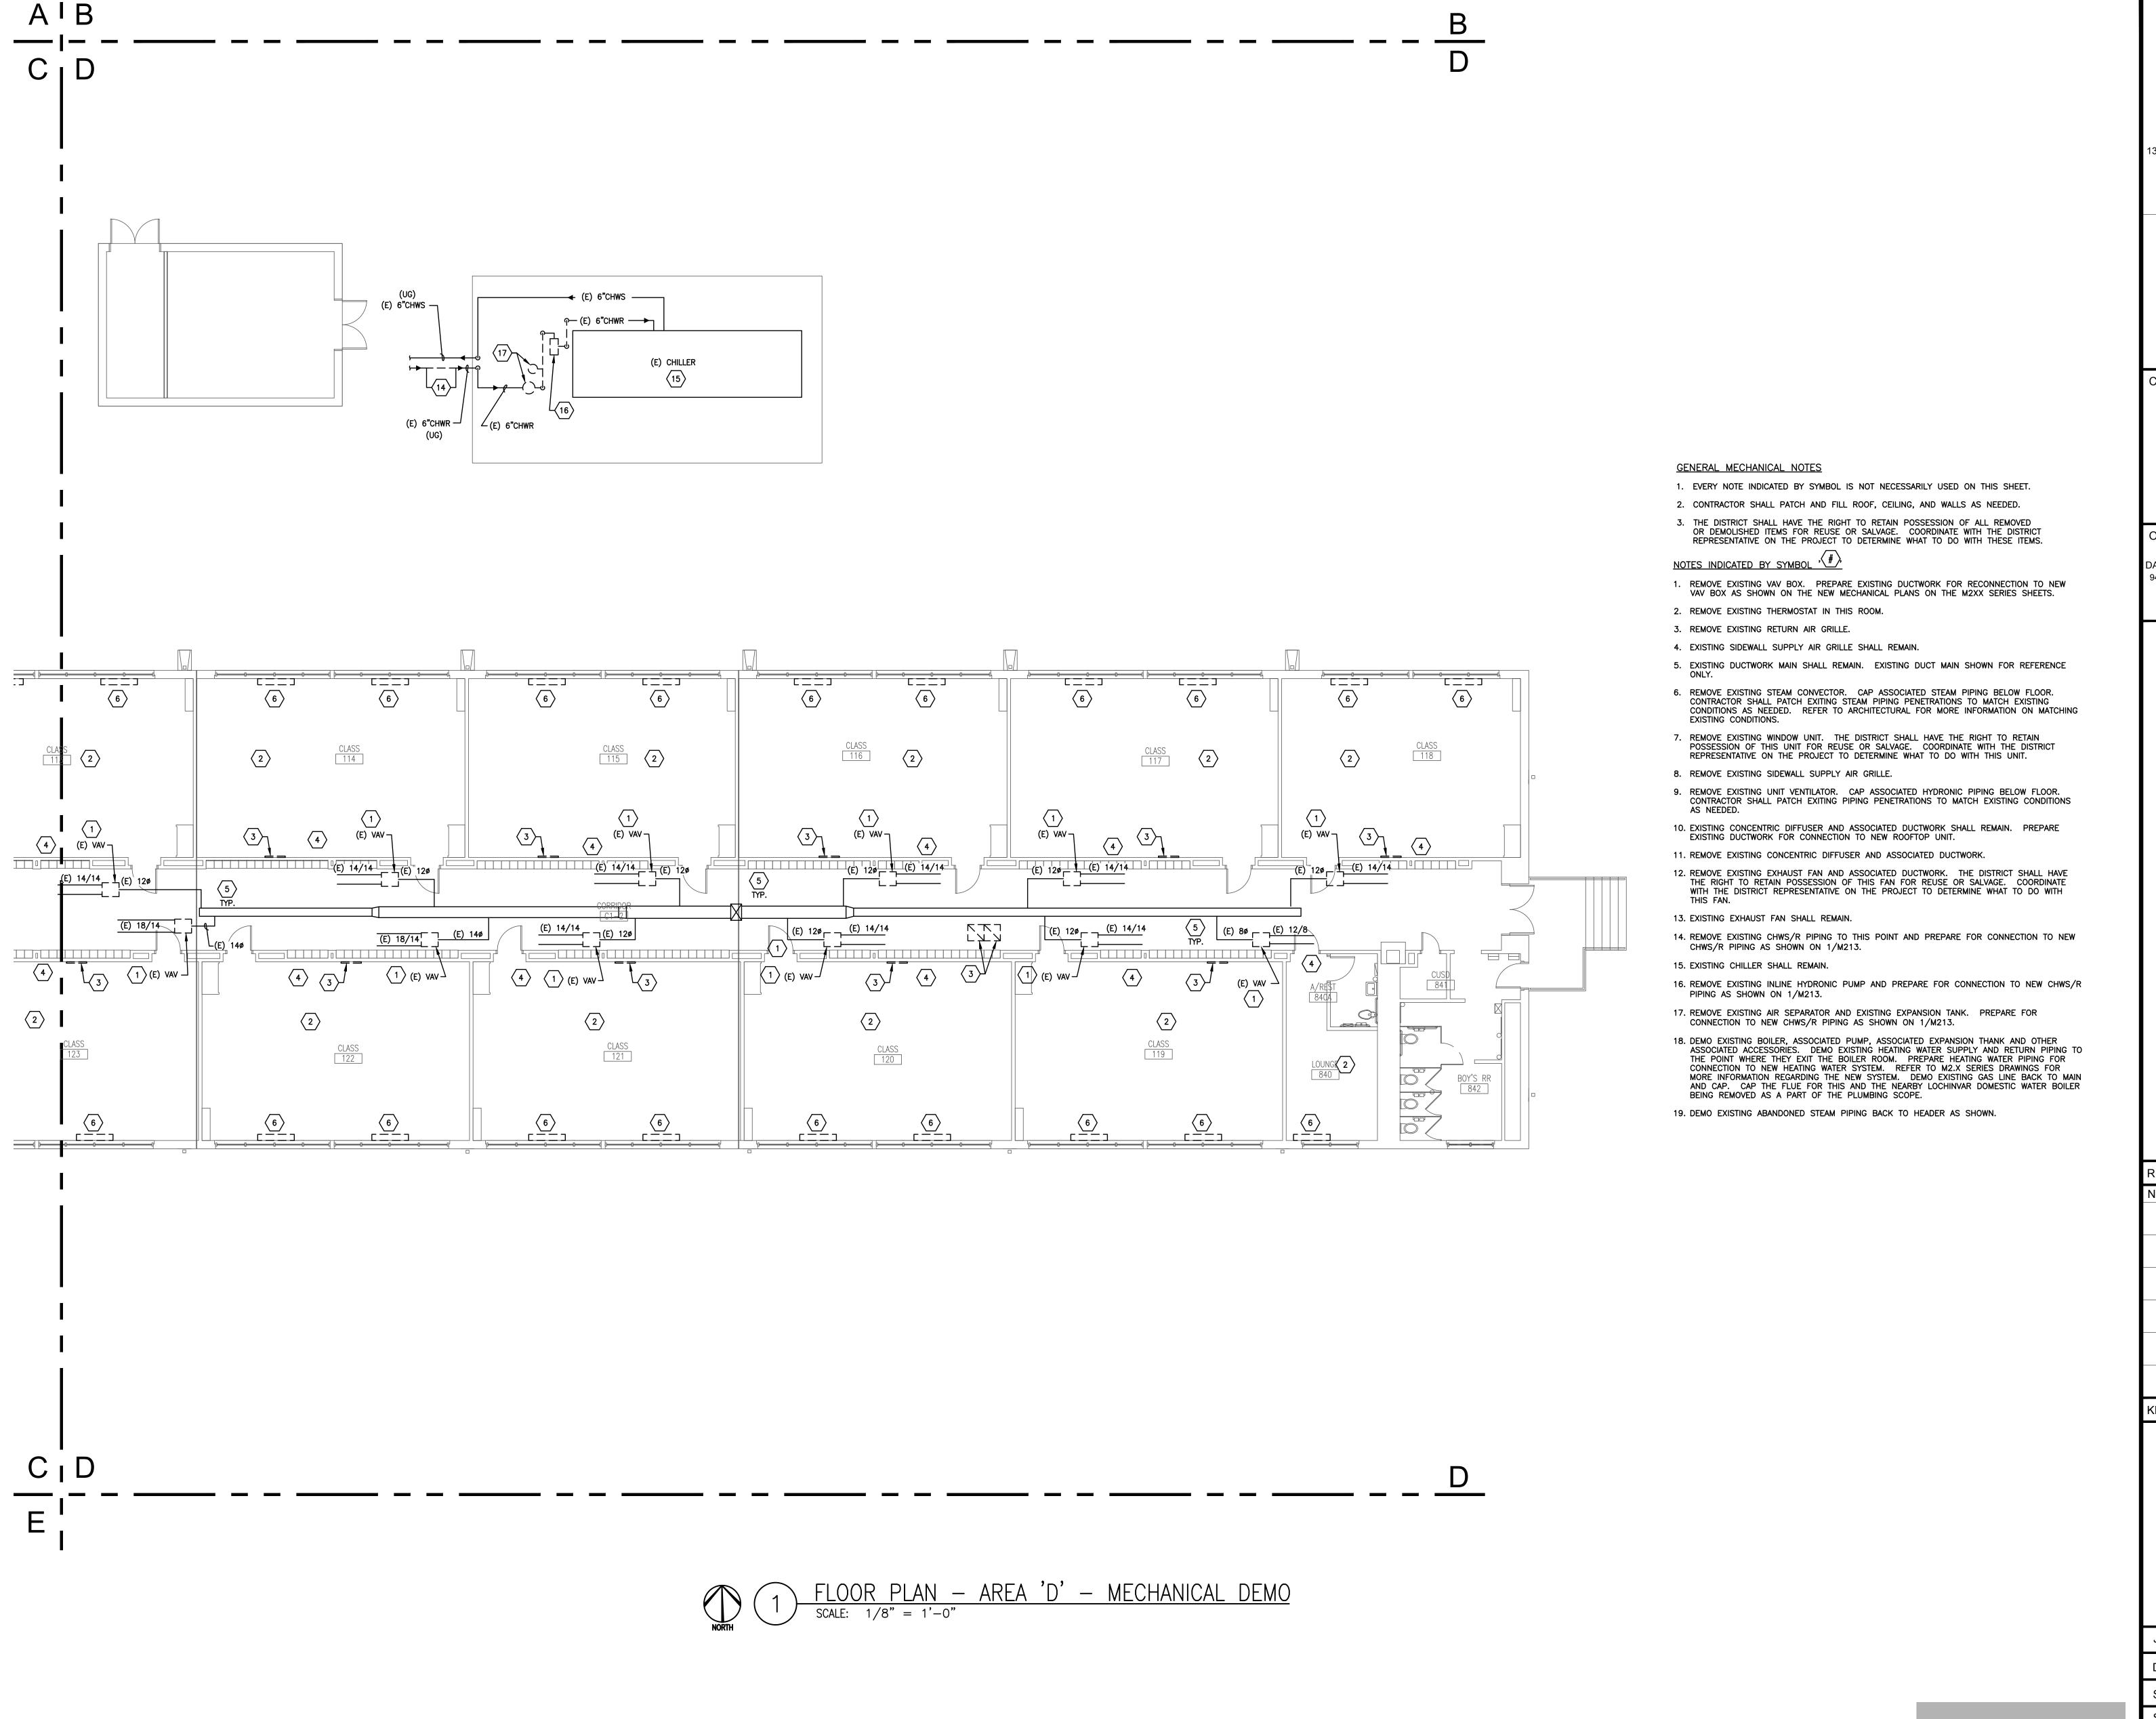
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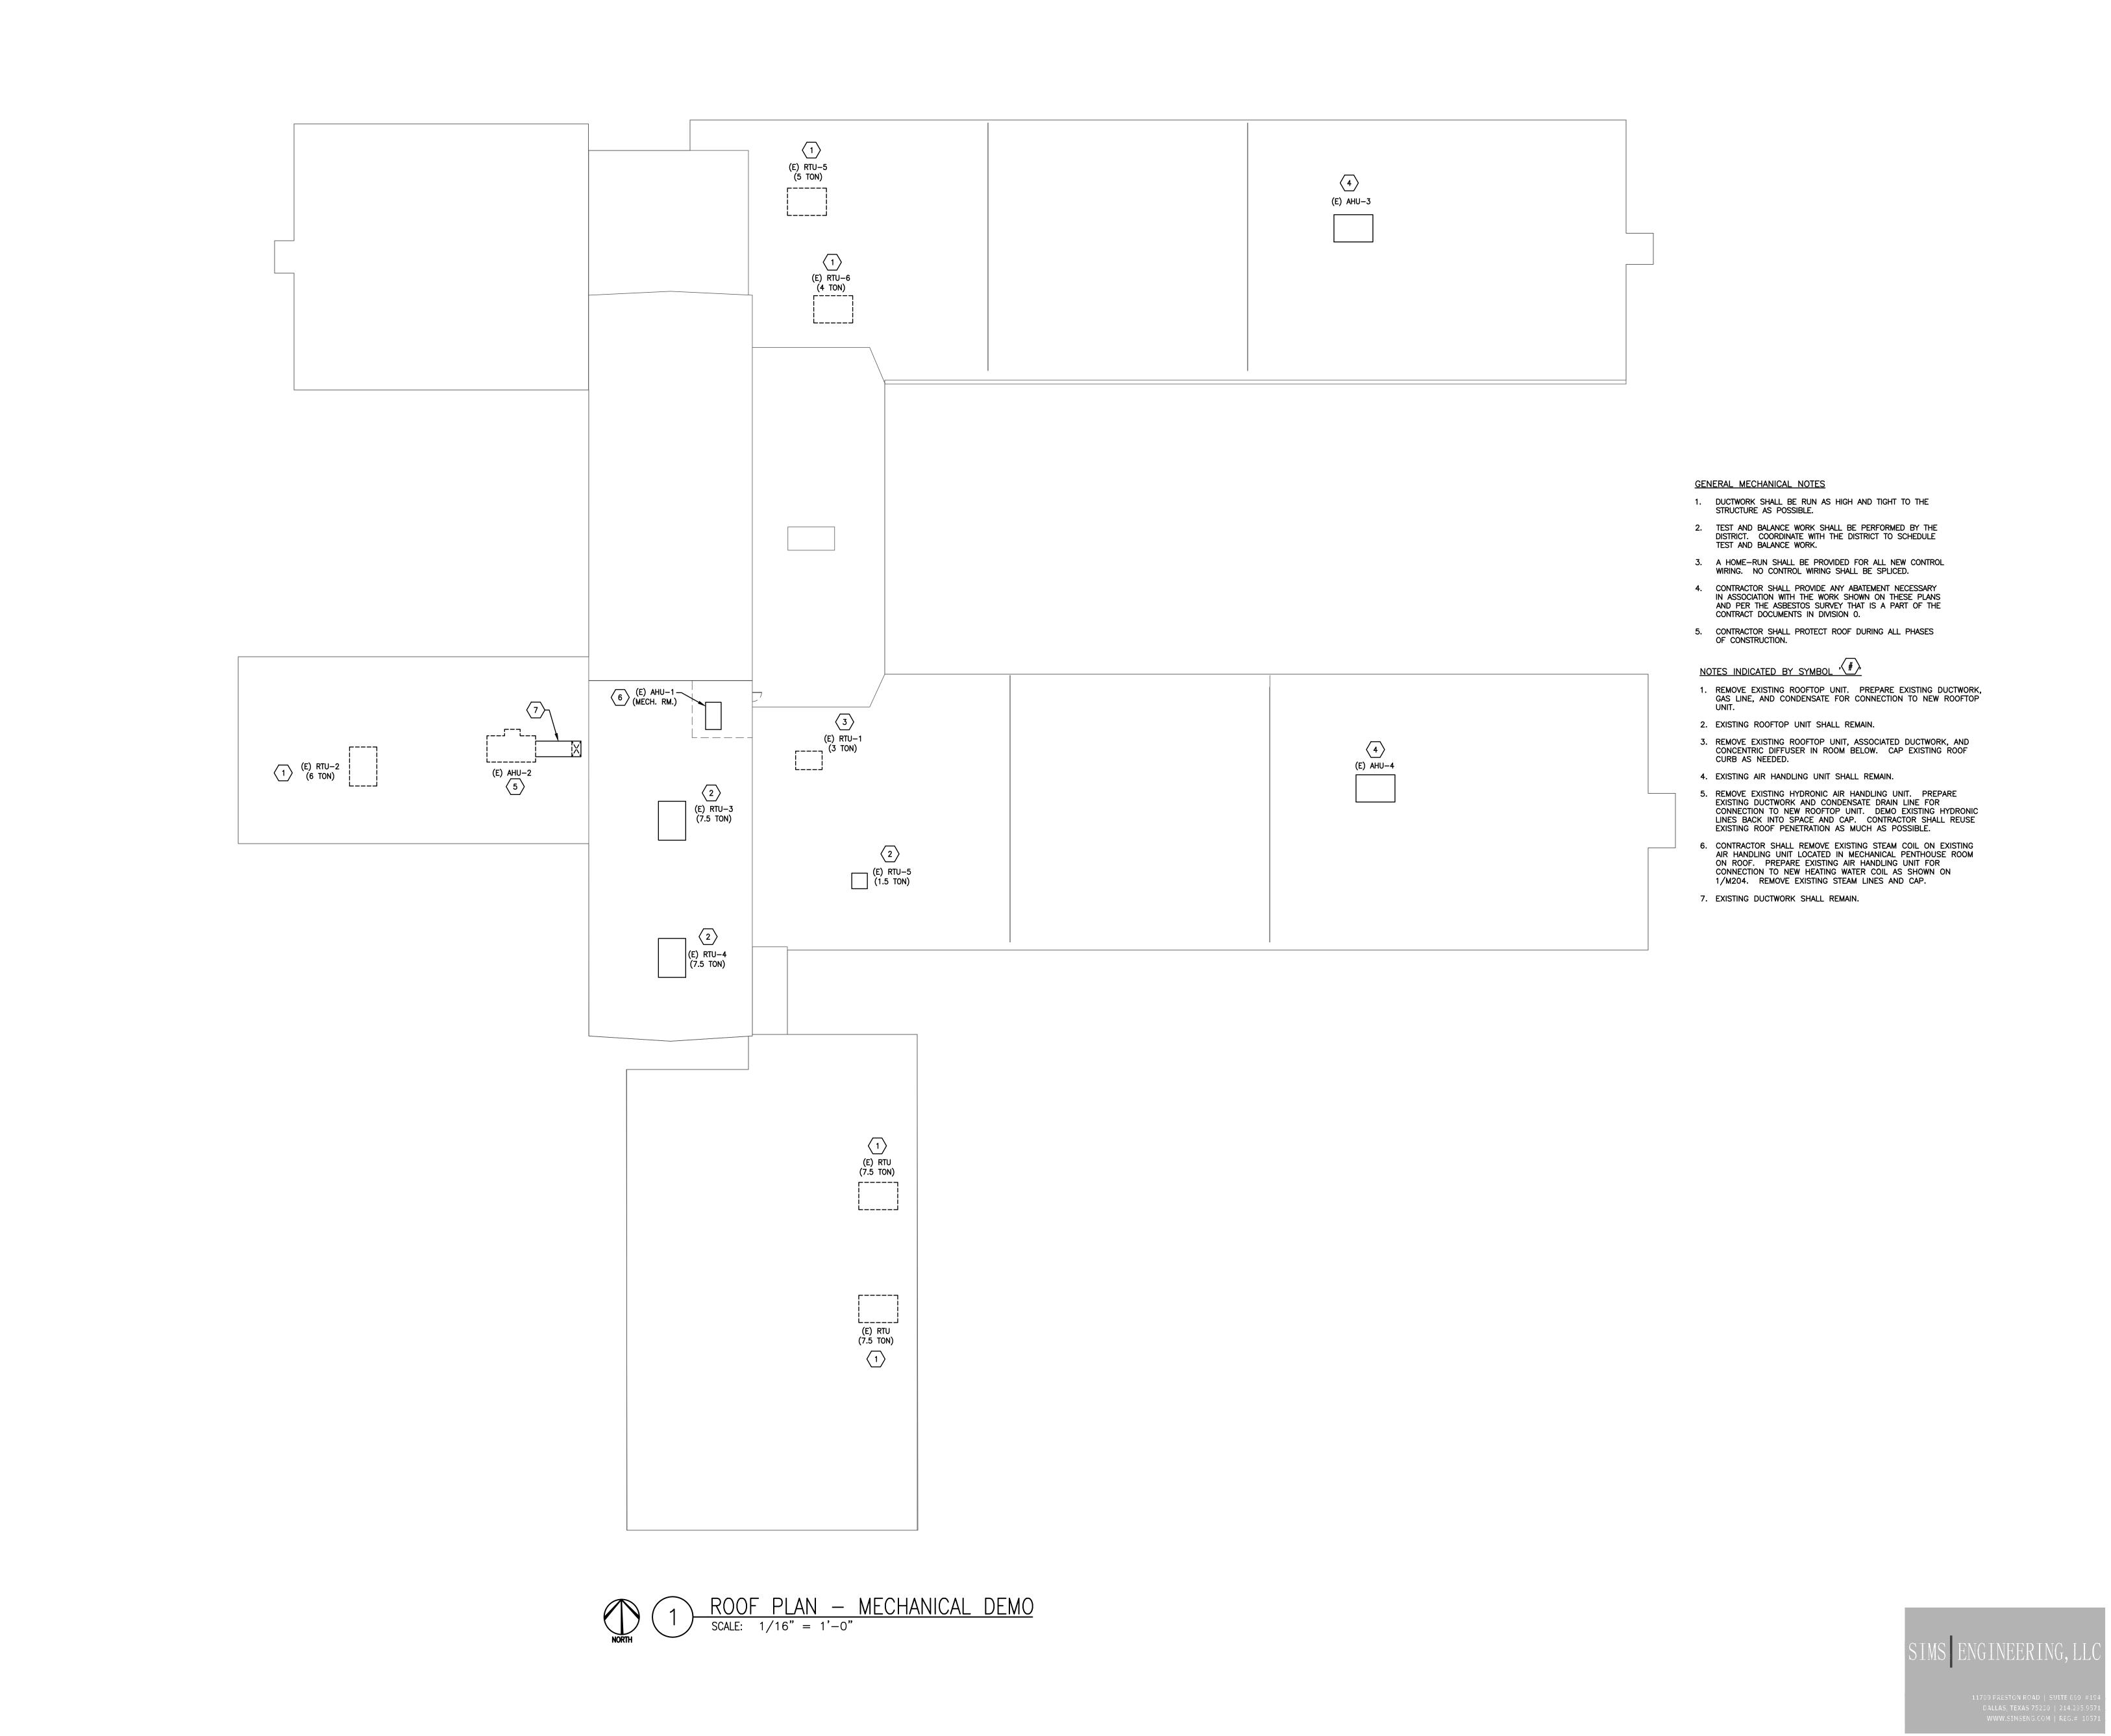
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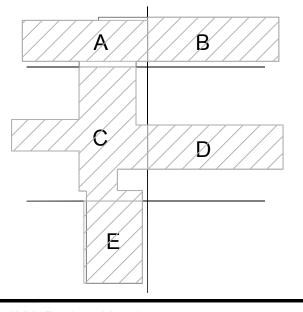
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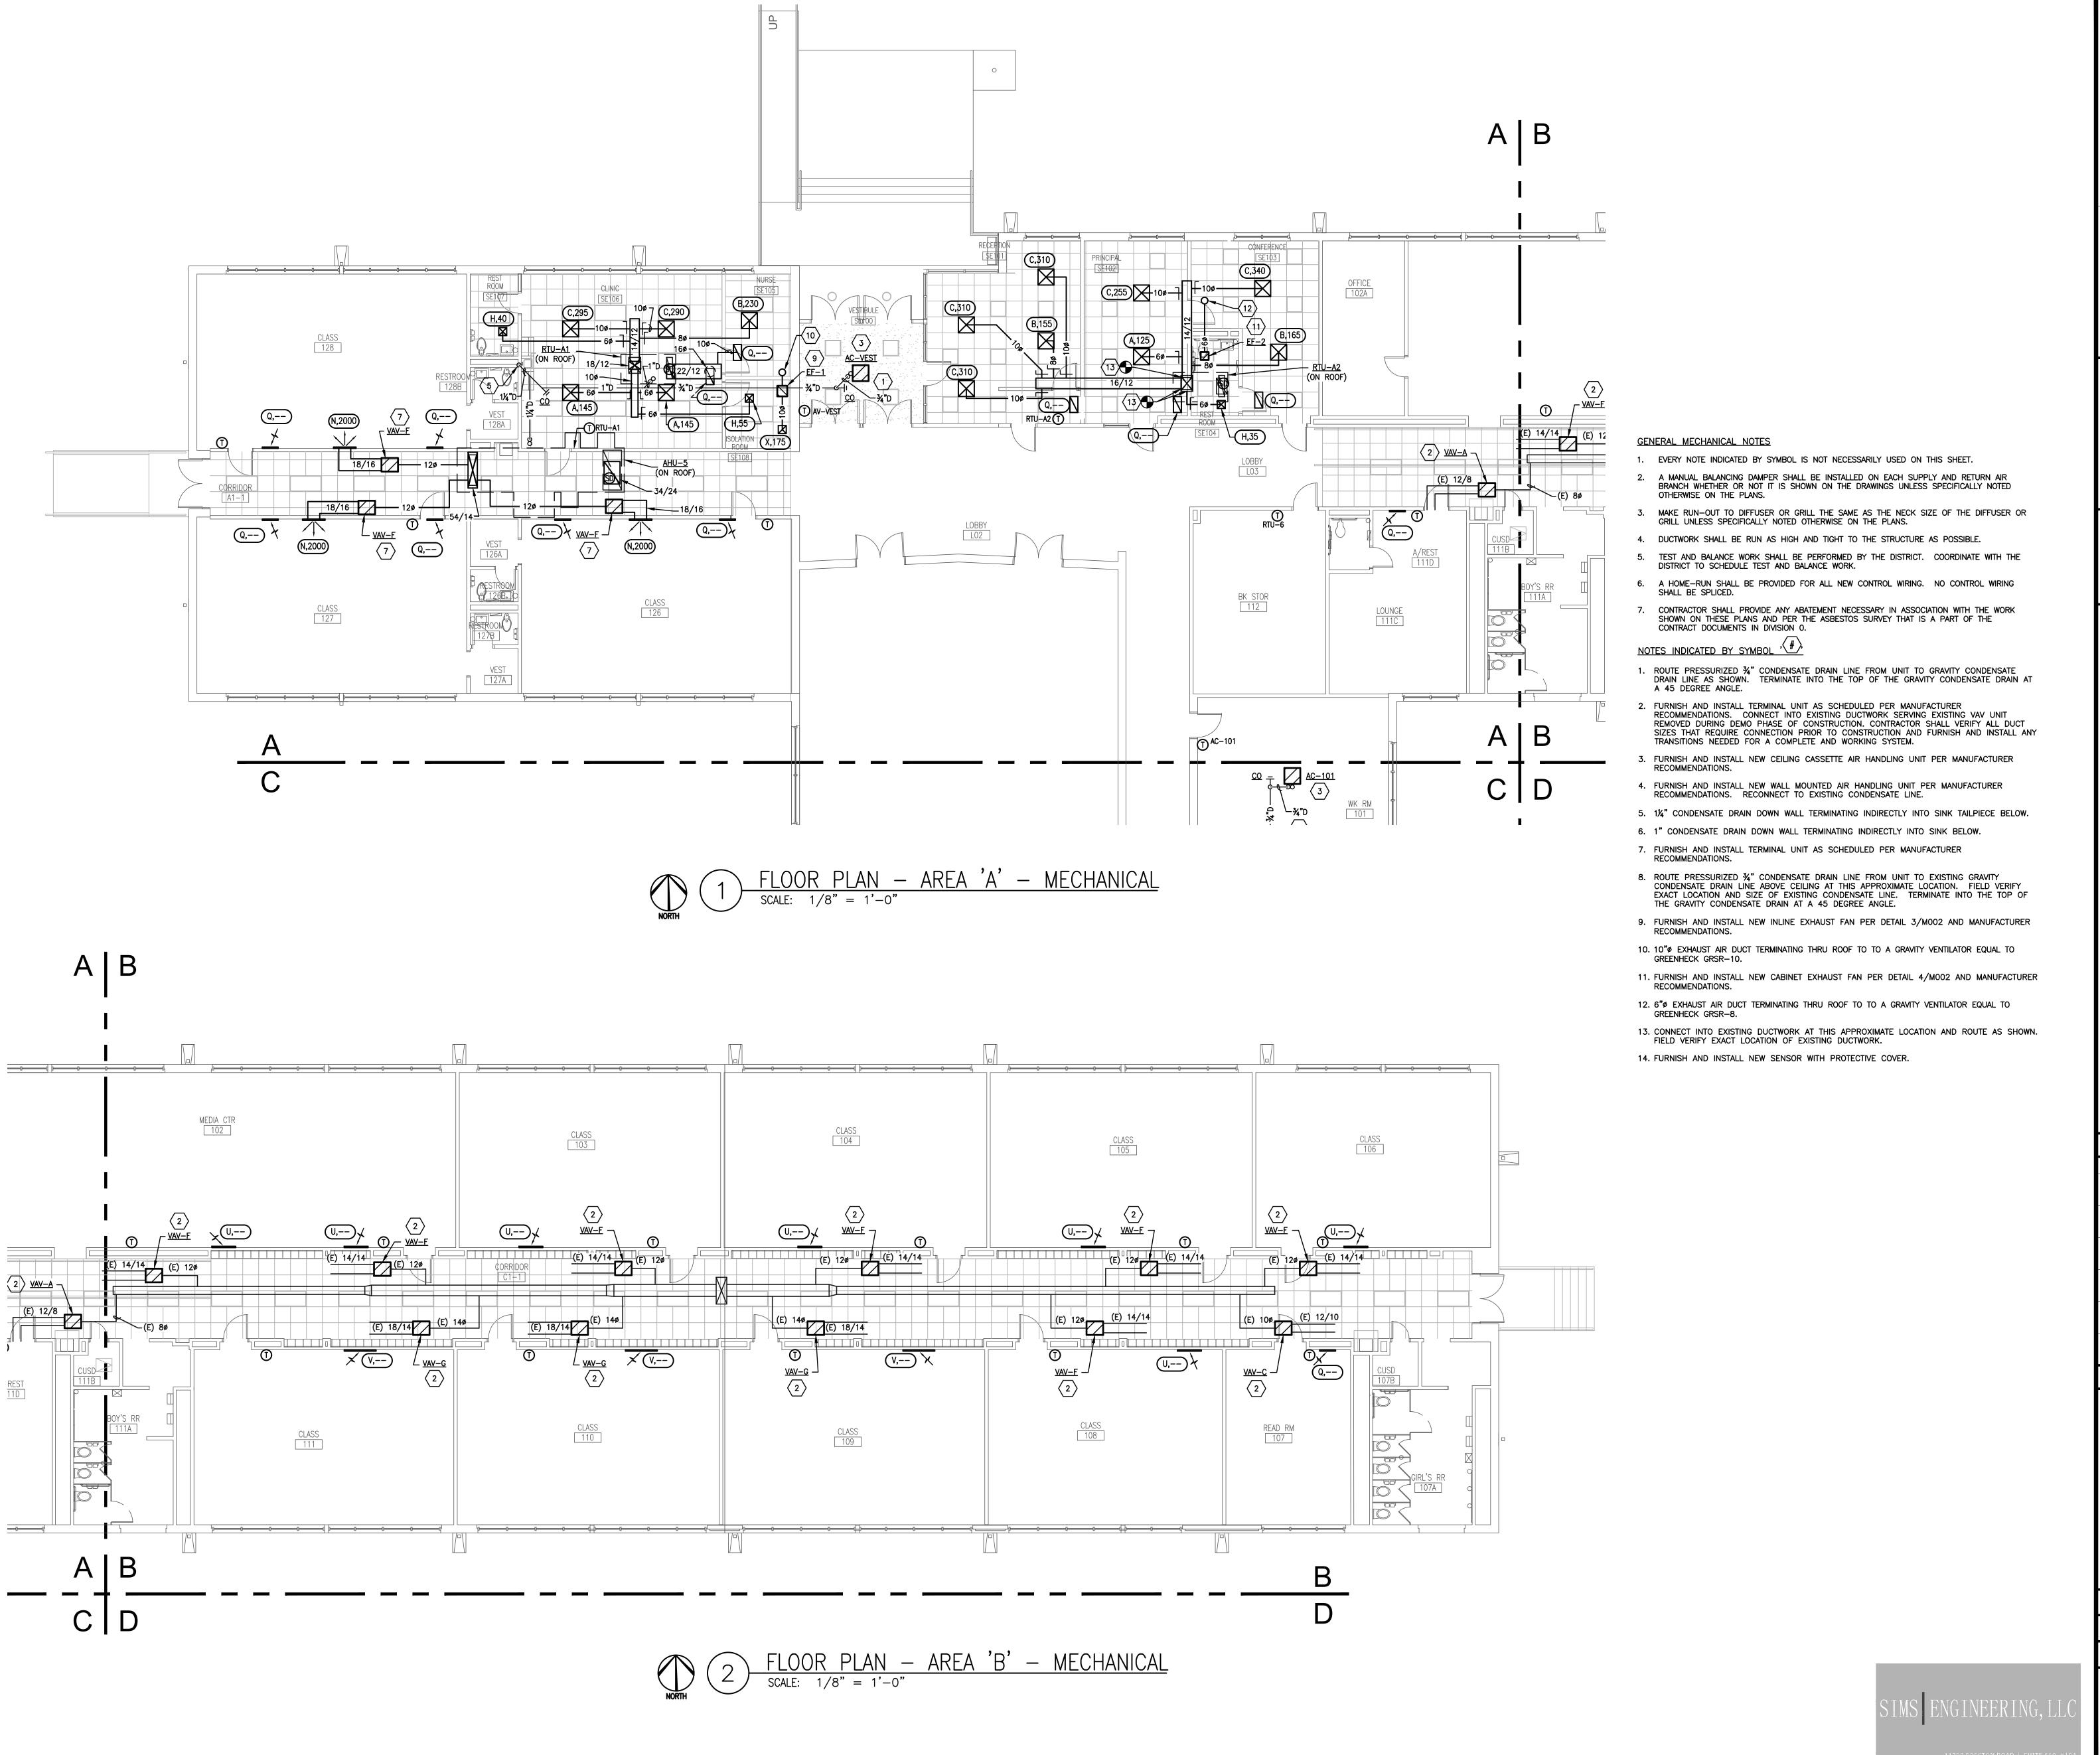
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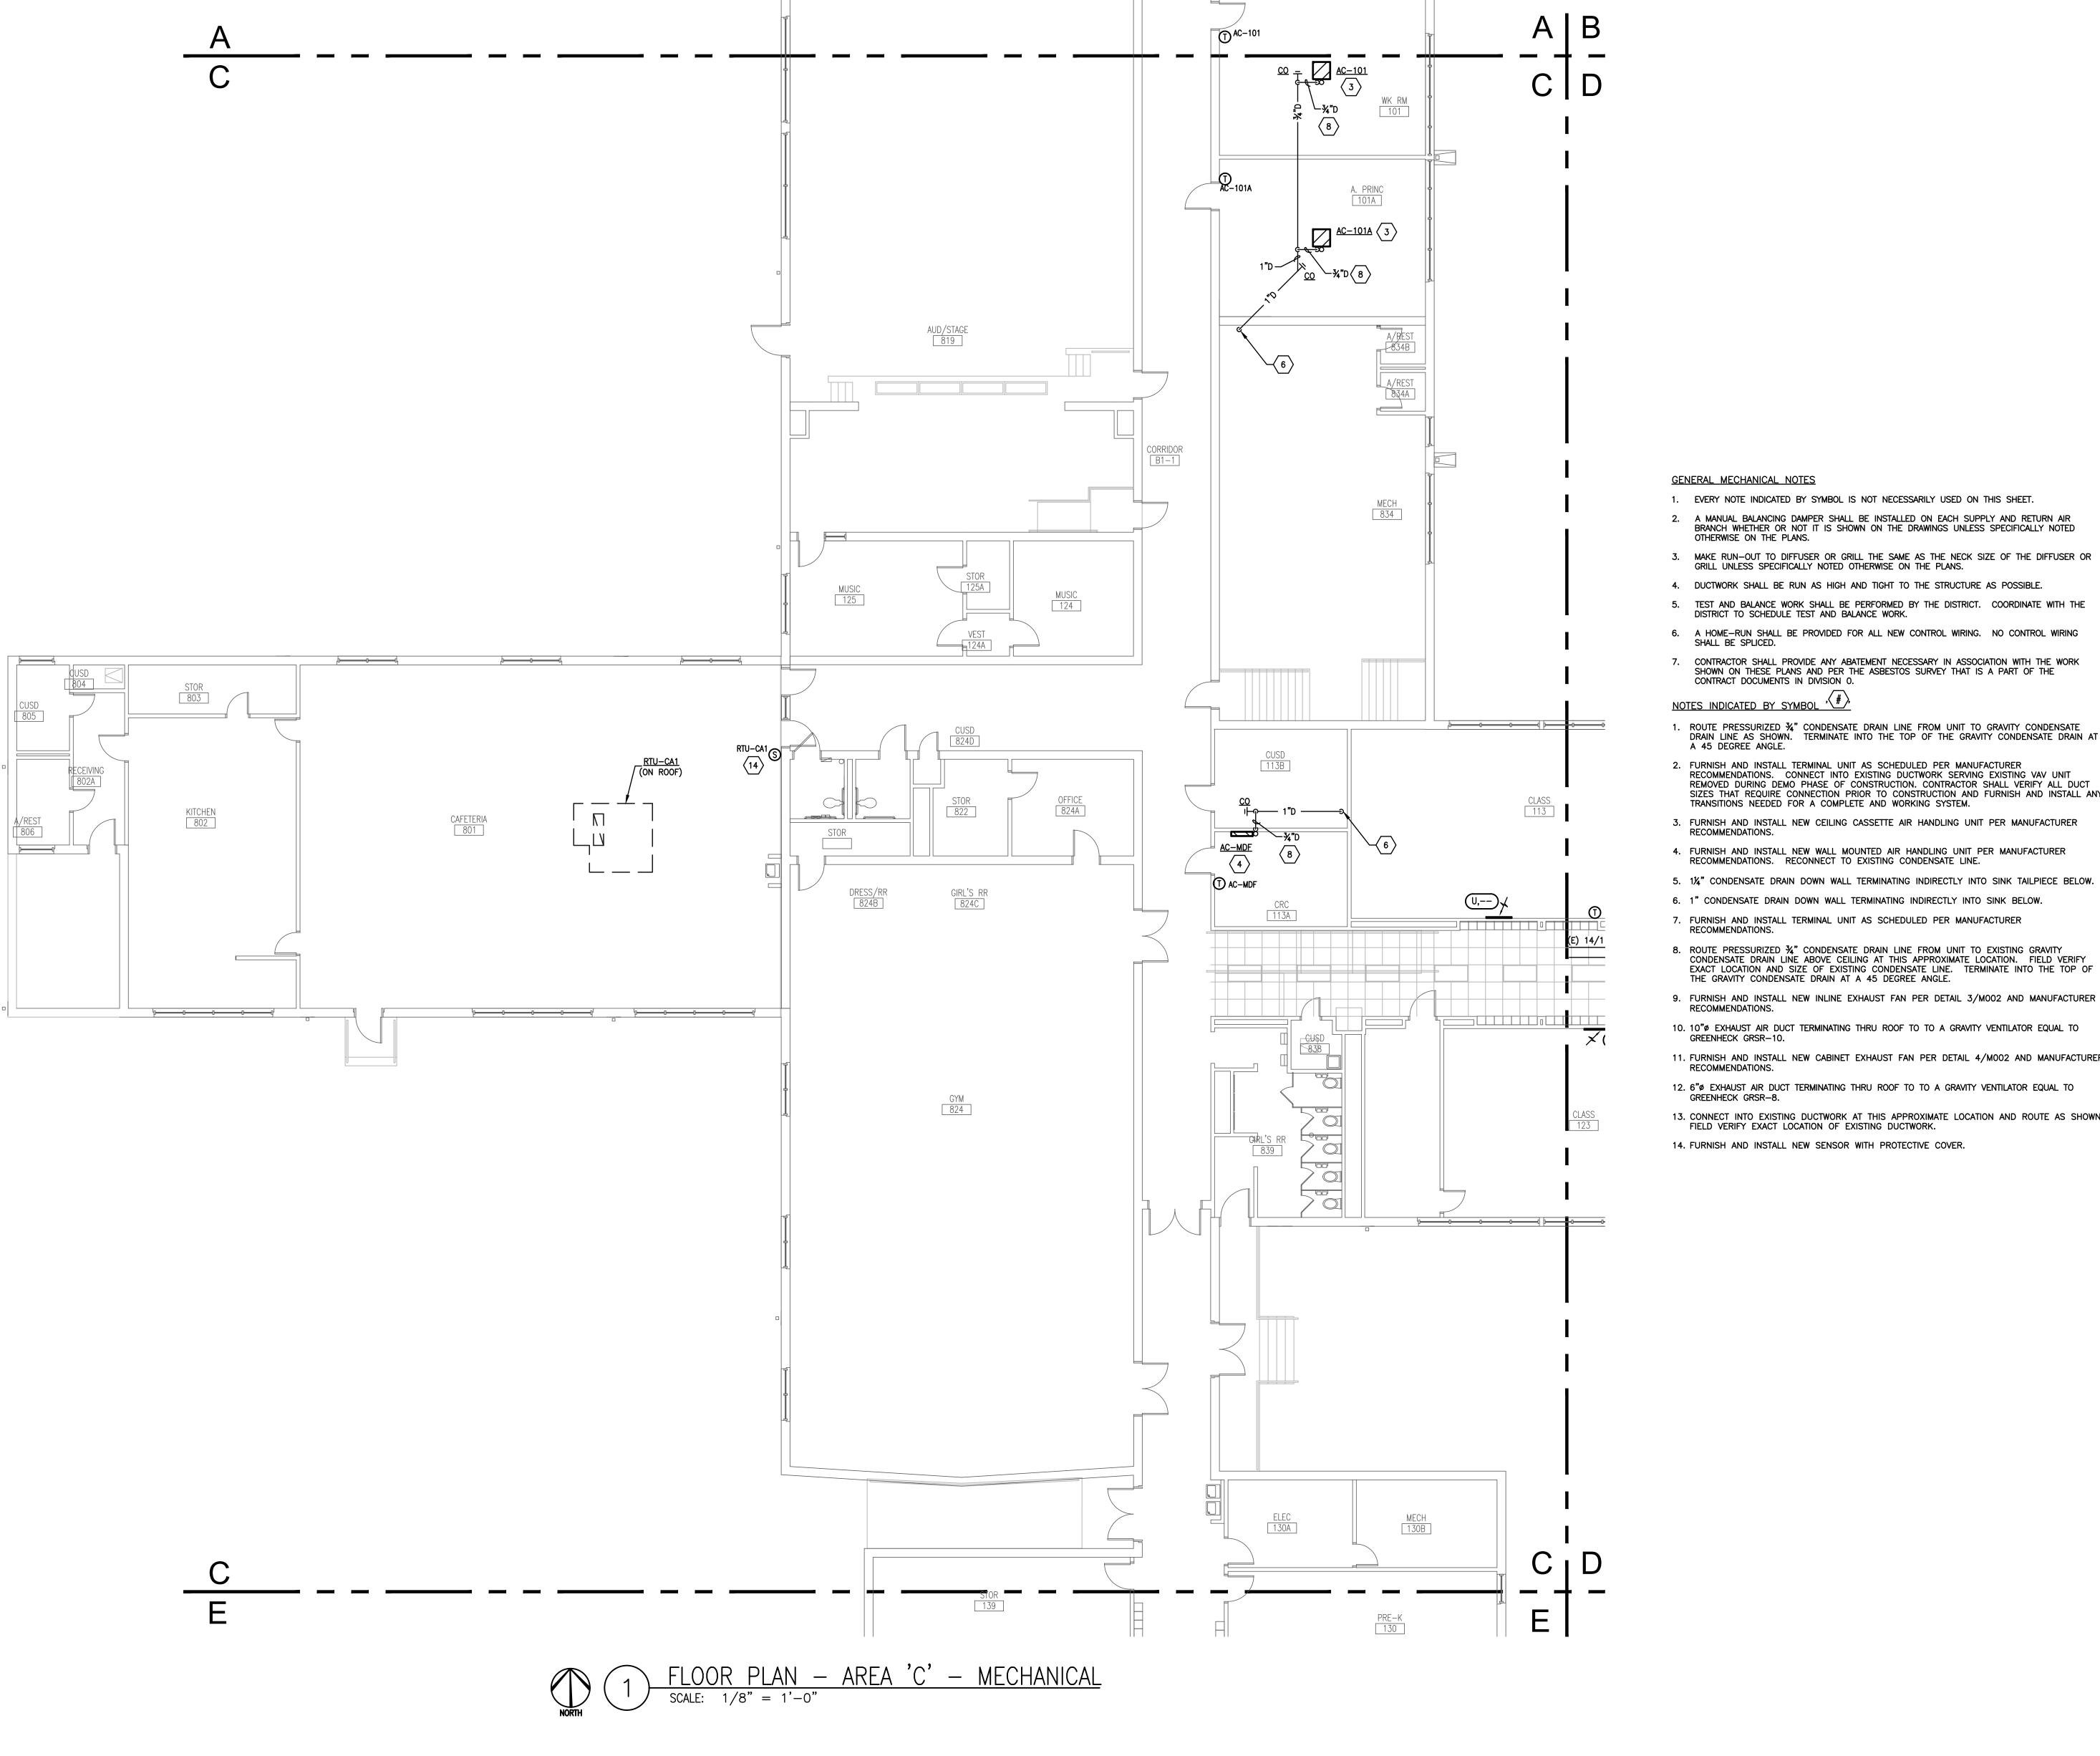
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1. ROUTE PRESSURIZED 3/4" CONDENSATE DRAIN LINE FROM UNIT TO GRAVITY CONDENSATE DRAIN LINE AS SHOWN. TERMINATE INTO THE TOP OF THE GRAVITY CONDENSATE DRAIN AT A 45 DEGREE ANGLE.

SHOWN ON THESE PLANS AND PER THE ASBESTOS SURVEY THAT IS A PART OF THE

2. FURNISH AND INSTALL TERMINAL UNIT AS SCHEDULED PER MANUFACTURER RECOMMENDATIONS. CONNECT INTO EXISTING DUCTWORK SERVING EXISTING VAV UNIT REMOVED DURING DEMO PHASE OF CONSTRUCTION. CONTRACTOR SHALL VERIFY ALL DUCT SIZES THAT REQUIRE CONNECTION PRIOR TO CONSTRUCTION AND FURNISH AND INSTALL ANY TRANSITIONS NEEDED FOR A COMPLETE AND WORKING SYSTEM.

OTHERWISE ON THE PLANS.

SHALL BE SPLICED.

GRILL UNLESS SPECIFICALLY NOTED OTHERWISE ON THE PLANS.

DISTRICT TO SCHEDULE TEST AND BALANCE WORK.

CONTRACT DOCUMENTS IN DIVISION O.

3. FURNISH AND INSTALL NEW CEILING CASSETTE AIR HANDLING UNIT PER MANUFACTURER RECOMMENDATIONS.

4. FURNISH AND INSTALL NEW WALL MOUNTED AIR HANDLING UNIT PER MANUFACTURER RECOMMENDATIONS. RECONNECT TO EXISTING CONDENSATE LINE.

5. 1¼" CONDENSATE DRAIN DOWN WALL TERMINATING INDIRECTLY INTO SINK TAILPIECE BELOW.

6. 1" CONDENSATE DRAIN DOWN WALL TERMINATING INDIRECTLY INTO SINK BELOW.

7. FURNISH AND INSTALL TERMINAL UNIT AS SCHEDULED PER MANUFACTURER RECOMMENDATIONS.

8. ROUTE PRESSURIZED 34" CONDENSATE DRAIN LINE FROM UNIT TO EXISTING GRAVITY CONDENSATE DRAIN LINE ABOVE CEILING AT THIS APPROXIMATE LOCATION. FIELD VERIFY EXACT LOCATION AND SIZE OF EXISTING CONDENSATE LINE. TERMINATE INTO THE TOP OF THE GRAVITY CONDENSATE DRAIN AT A 45 DEGREE ANGLE.

9. FURNISH AND INSTALL NEW INLINE EXHAUST FAN PER DETAIL 3/M002 AND MANUFACTURER

10. 10" Ø EXHAUST AIR DUCT TERMINATING THRU ROOF TO TO A GRAVITY VENTILATOR EQUAL TO GREENHECK GRSR-10.

11. FURNISH AND INSTALL NEW CABINET EXHAUST FAN PER DETAIL 4/M002 AND MANUFACTURER

12. 6"Ø EXHAUST AIR DUCT TERMINATING THRU ROOF TO TO A GRAVITY VENTILATOR EQUAL TO GREENHECK GRSR-8.

13. CONNECT INTO EXISTING DUCTWORK AT THIS APPROXIMATE LOCATION AND ROUTE AS SHOWN. FIELD VERIFY EXACT LOCATION OF EXISTING DUCTWORK.

14. FURNISH AND INSTALL NEW SENSOR WITH PROTECTIVE COVER.

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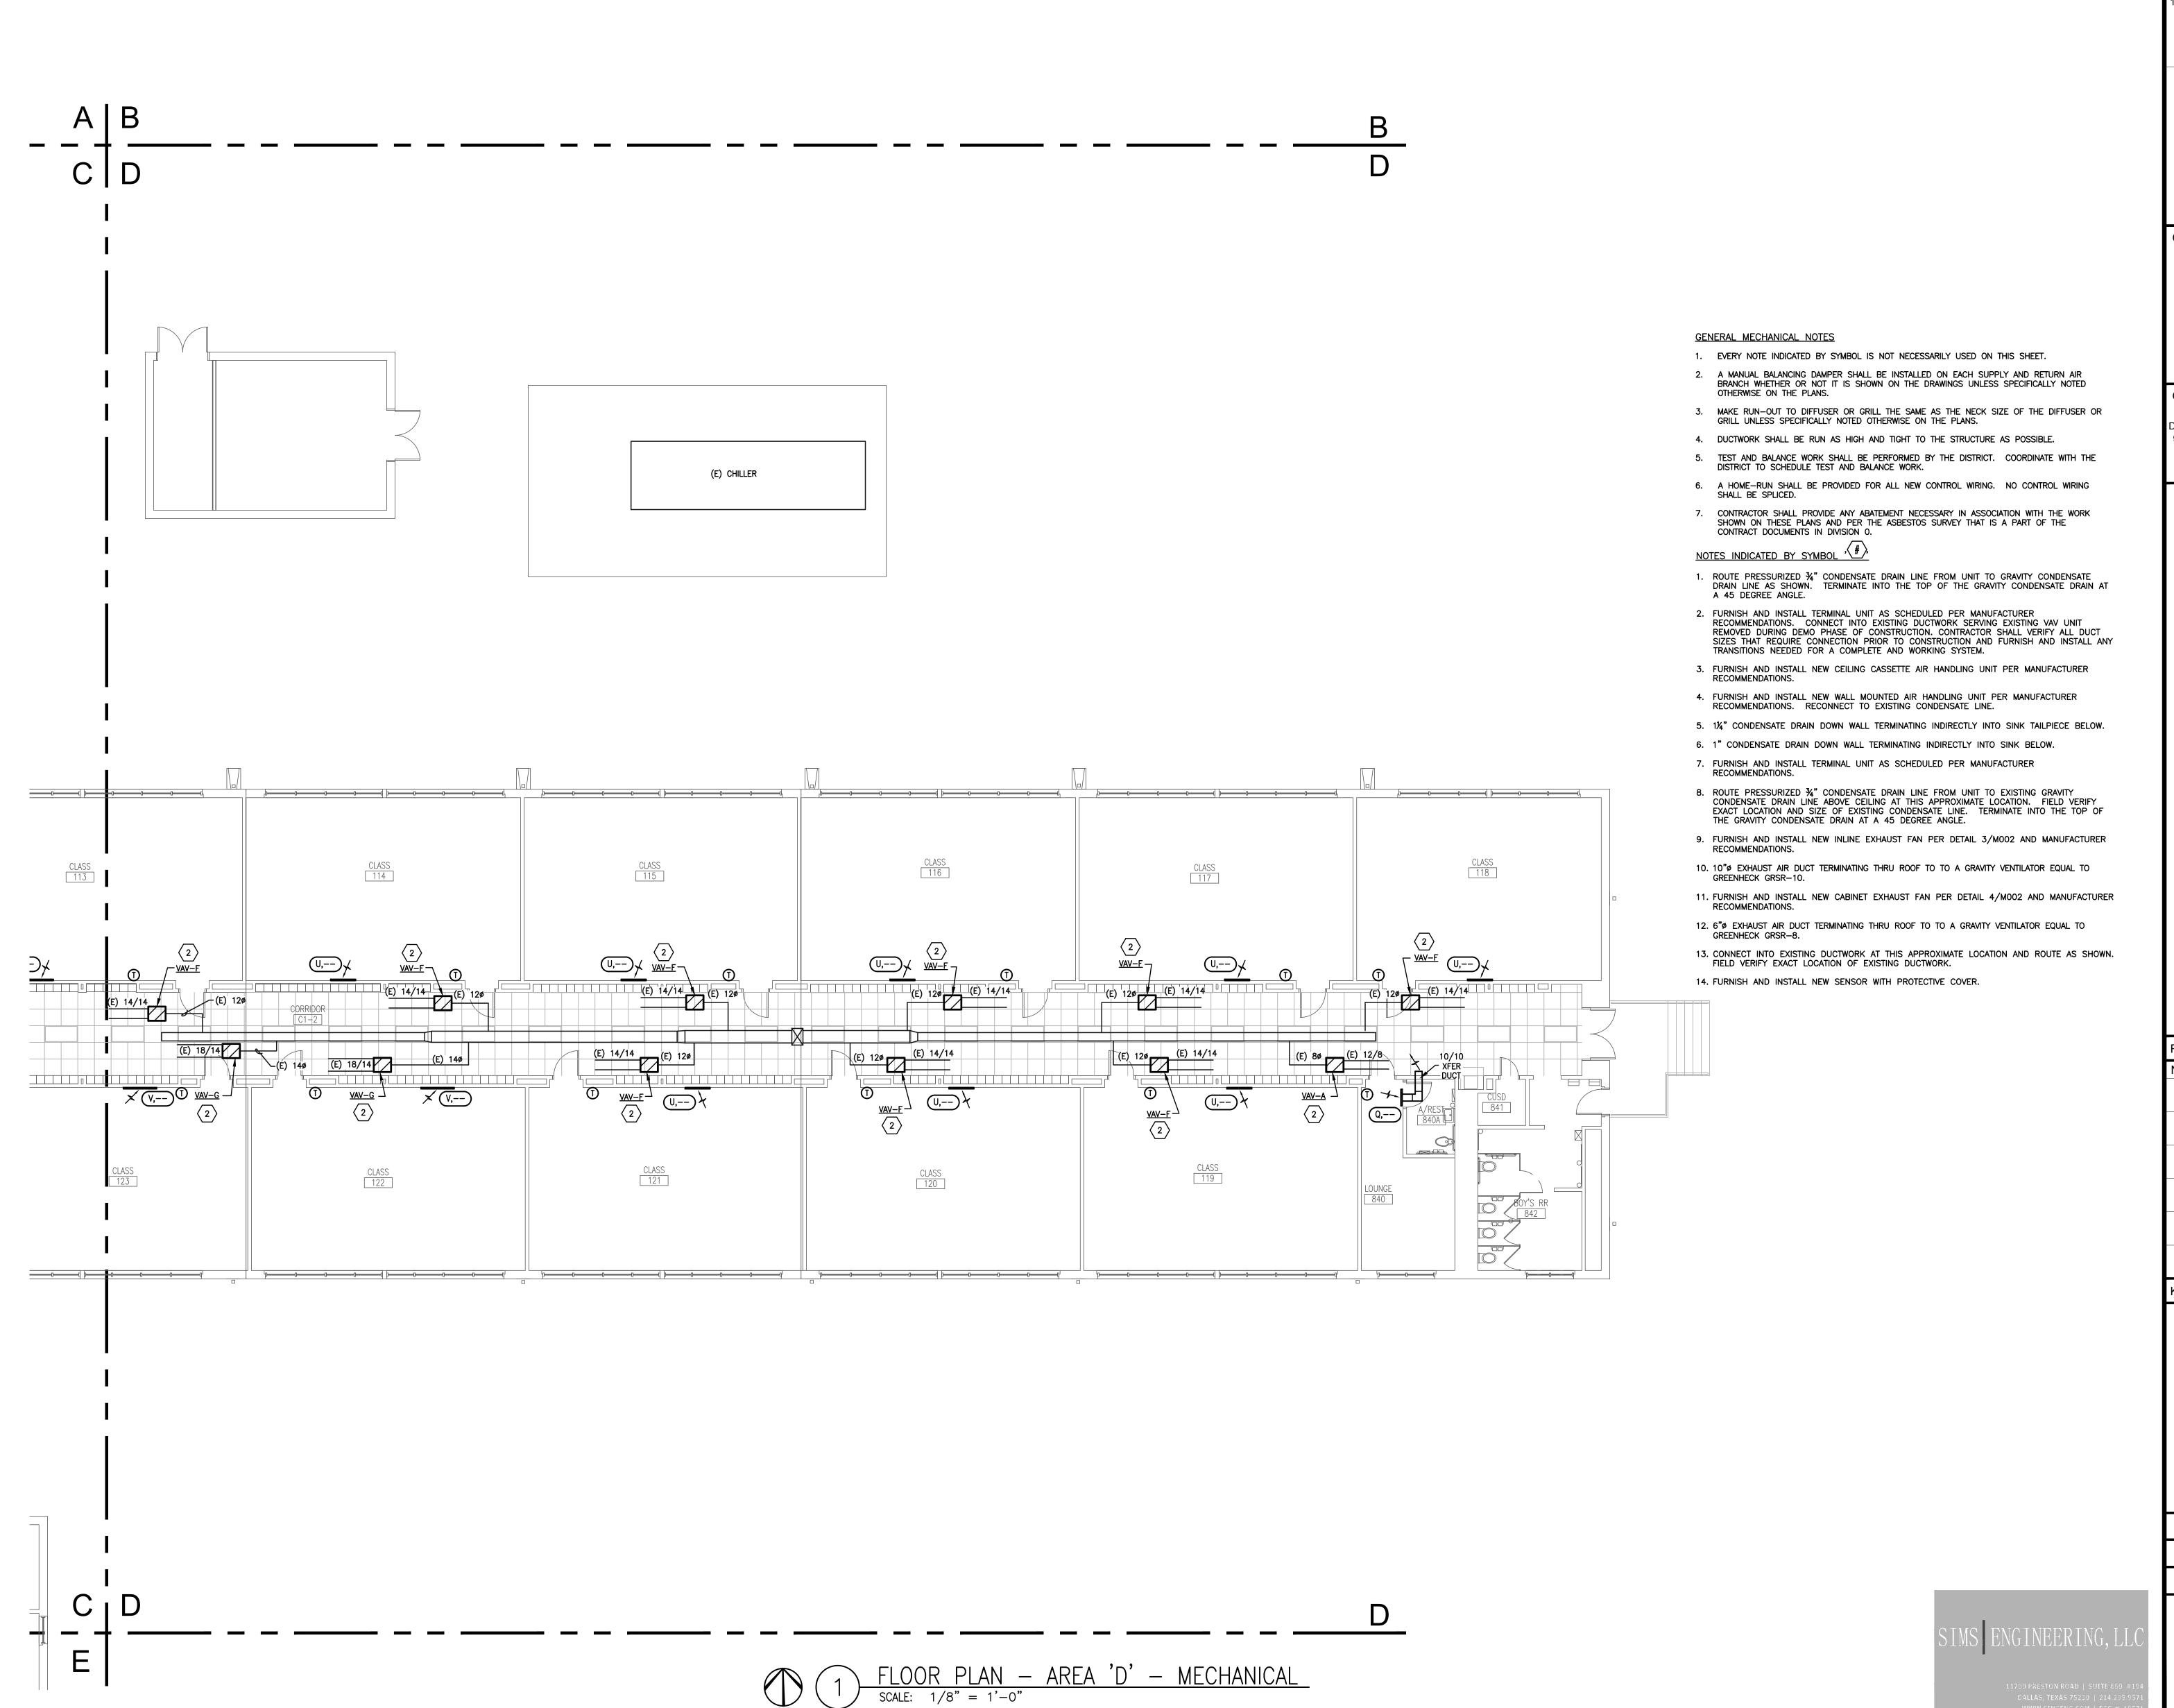
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FLOOR PLAN MECHANICAL





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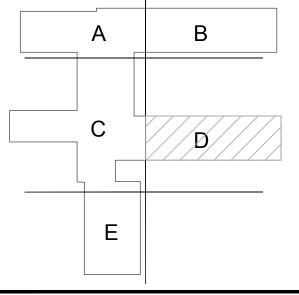
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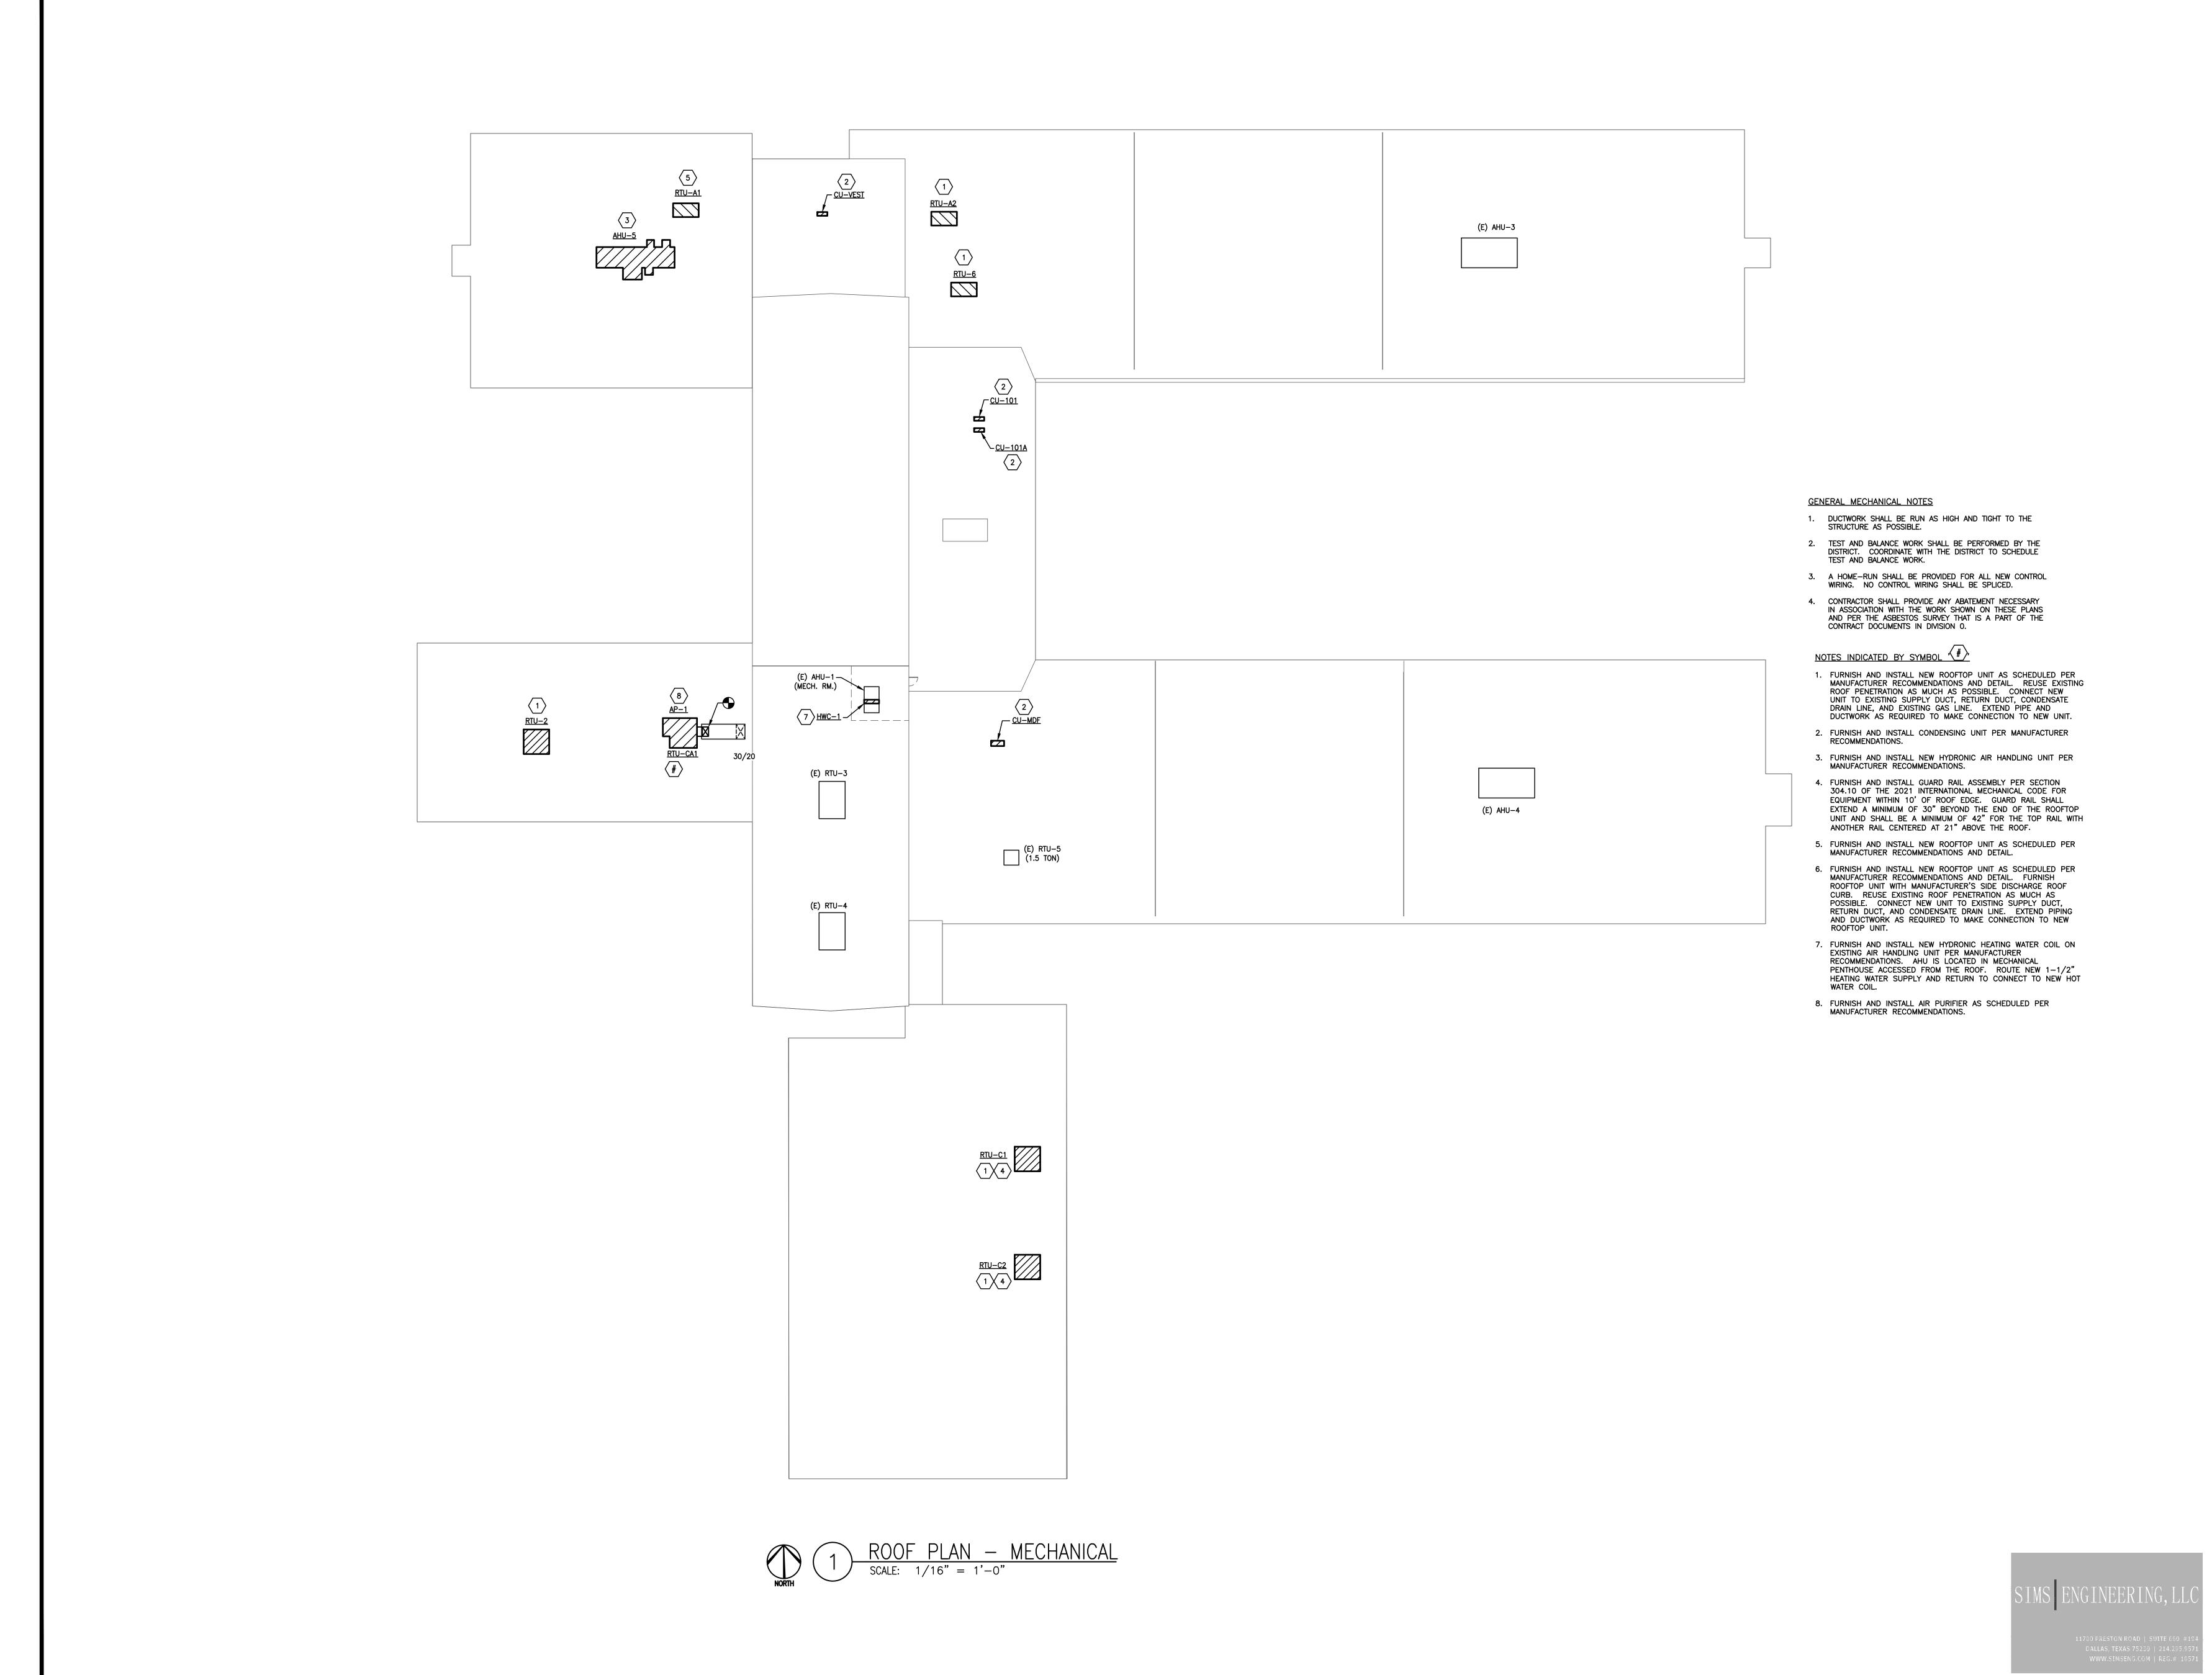
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Sheet Title

FLOOR PLAN MECHANICAL

Sheet Number





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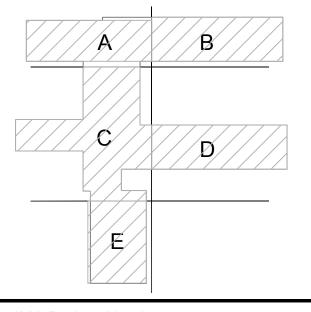
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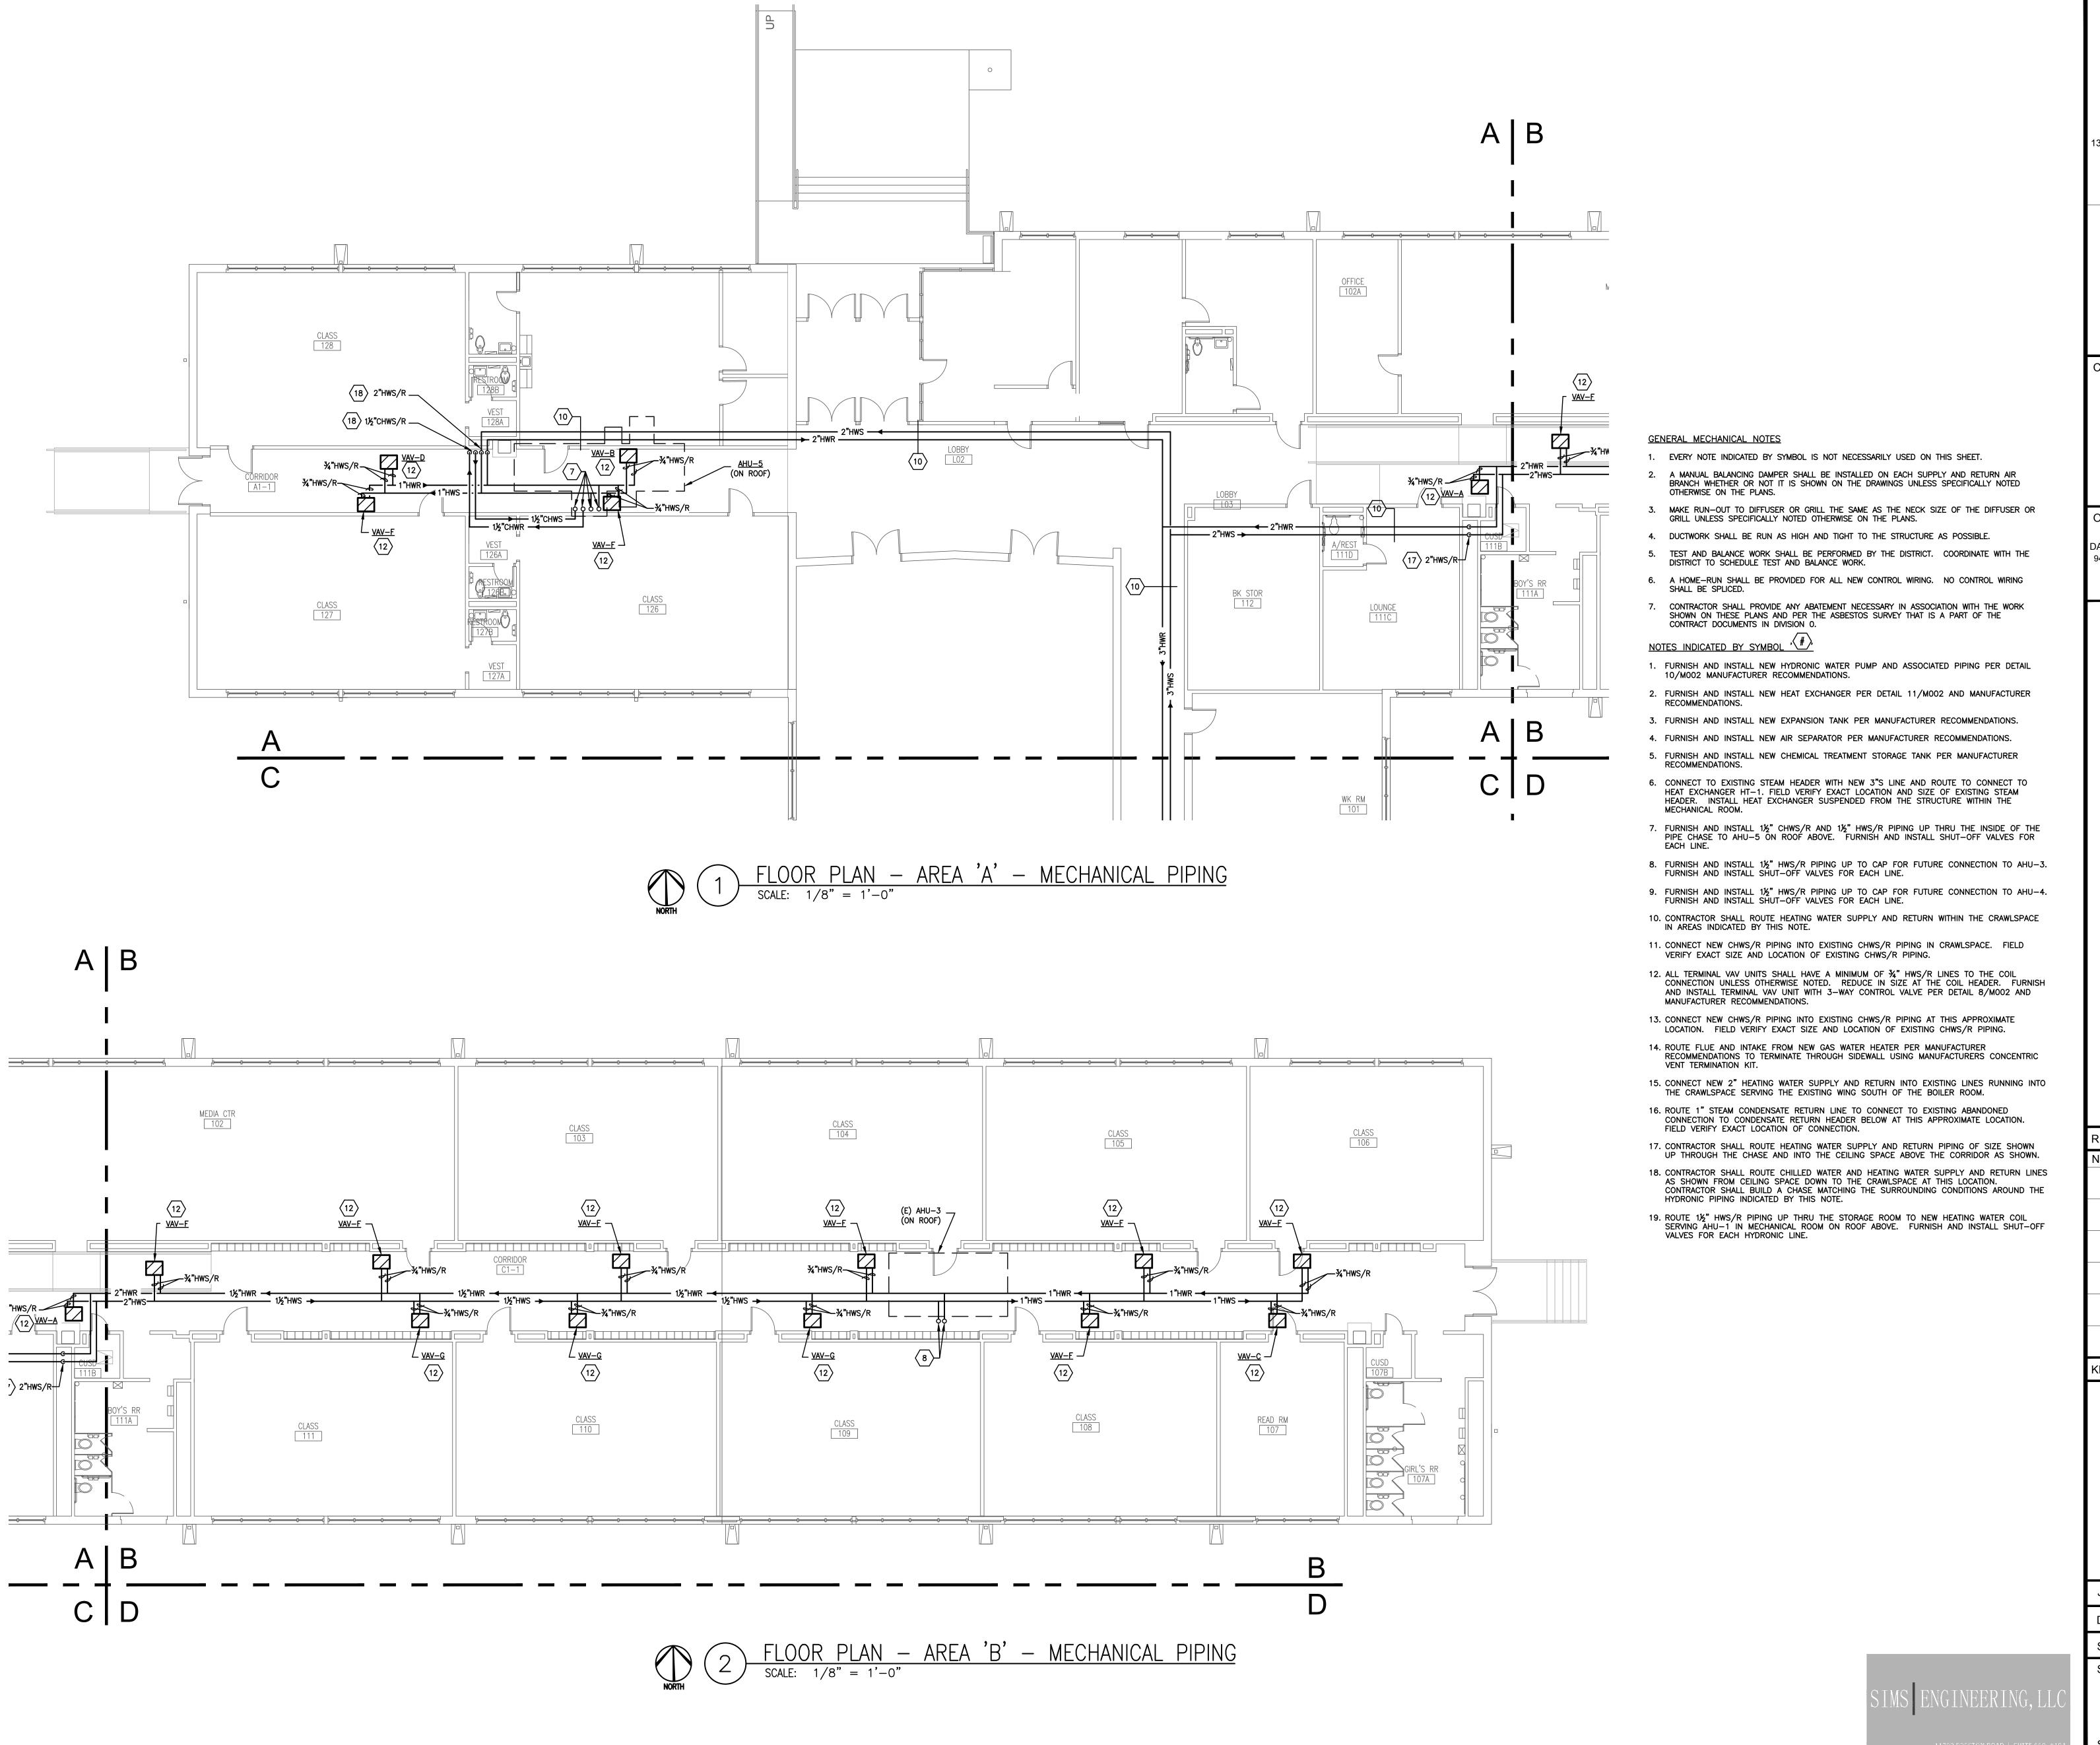


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ROOF PLAN MECHANICAL



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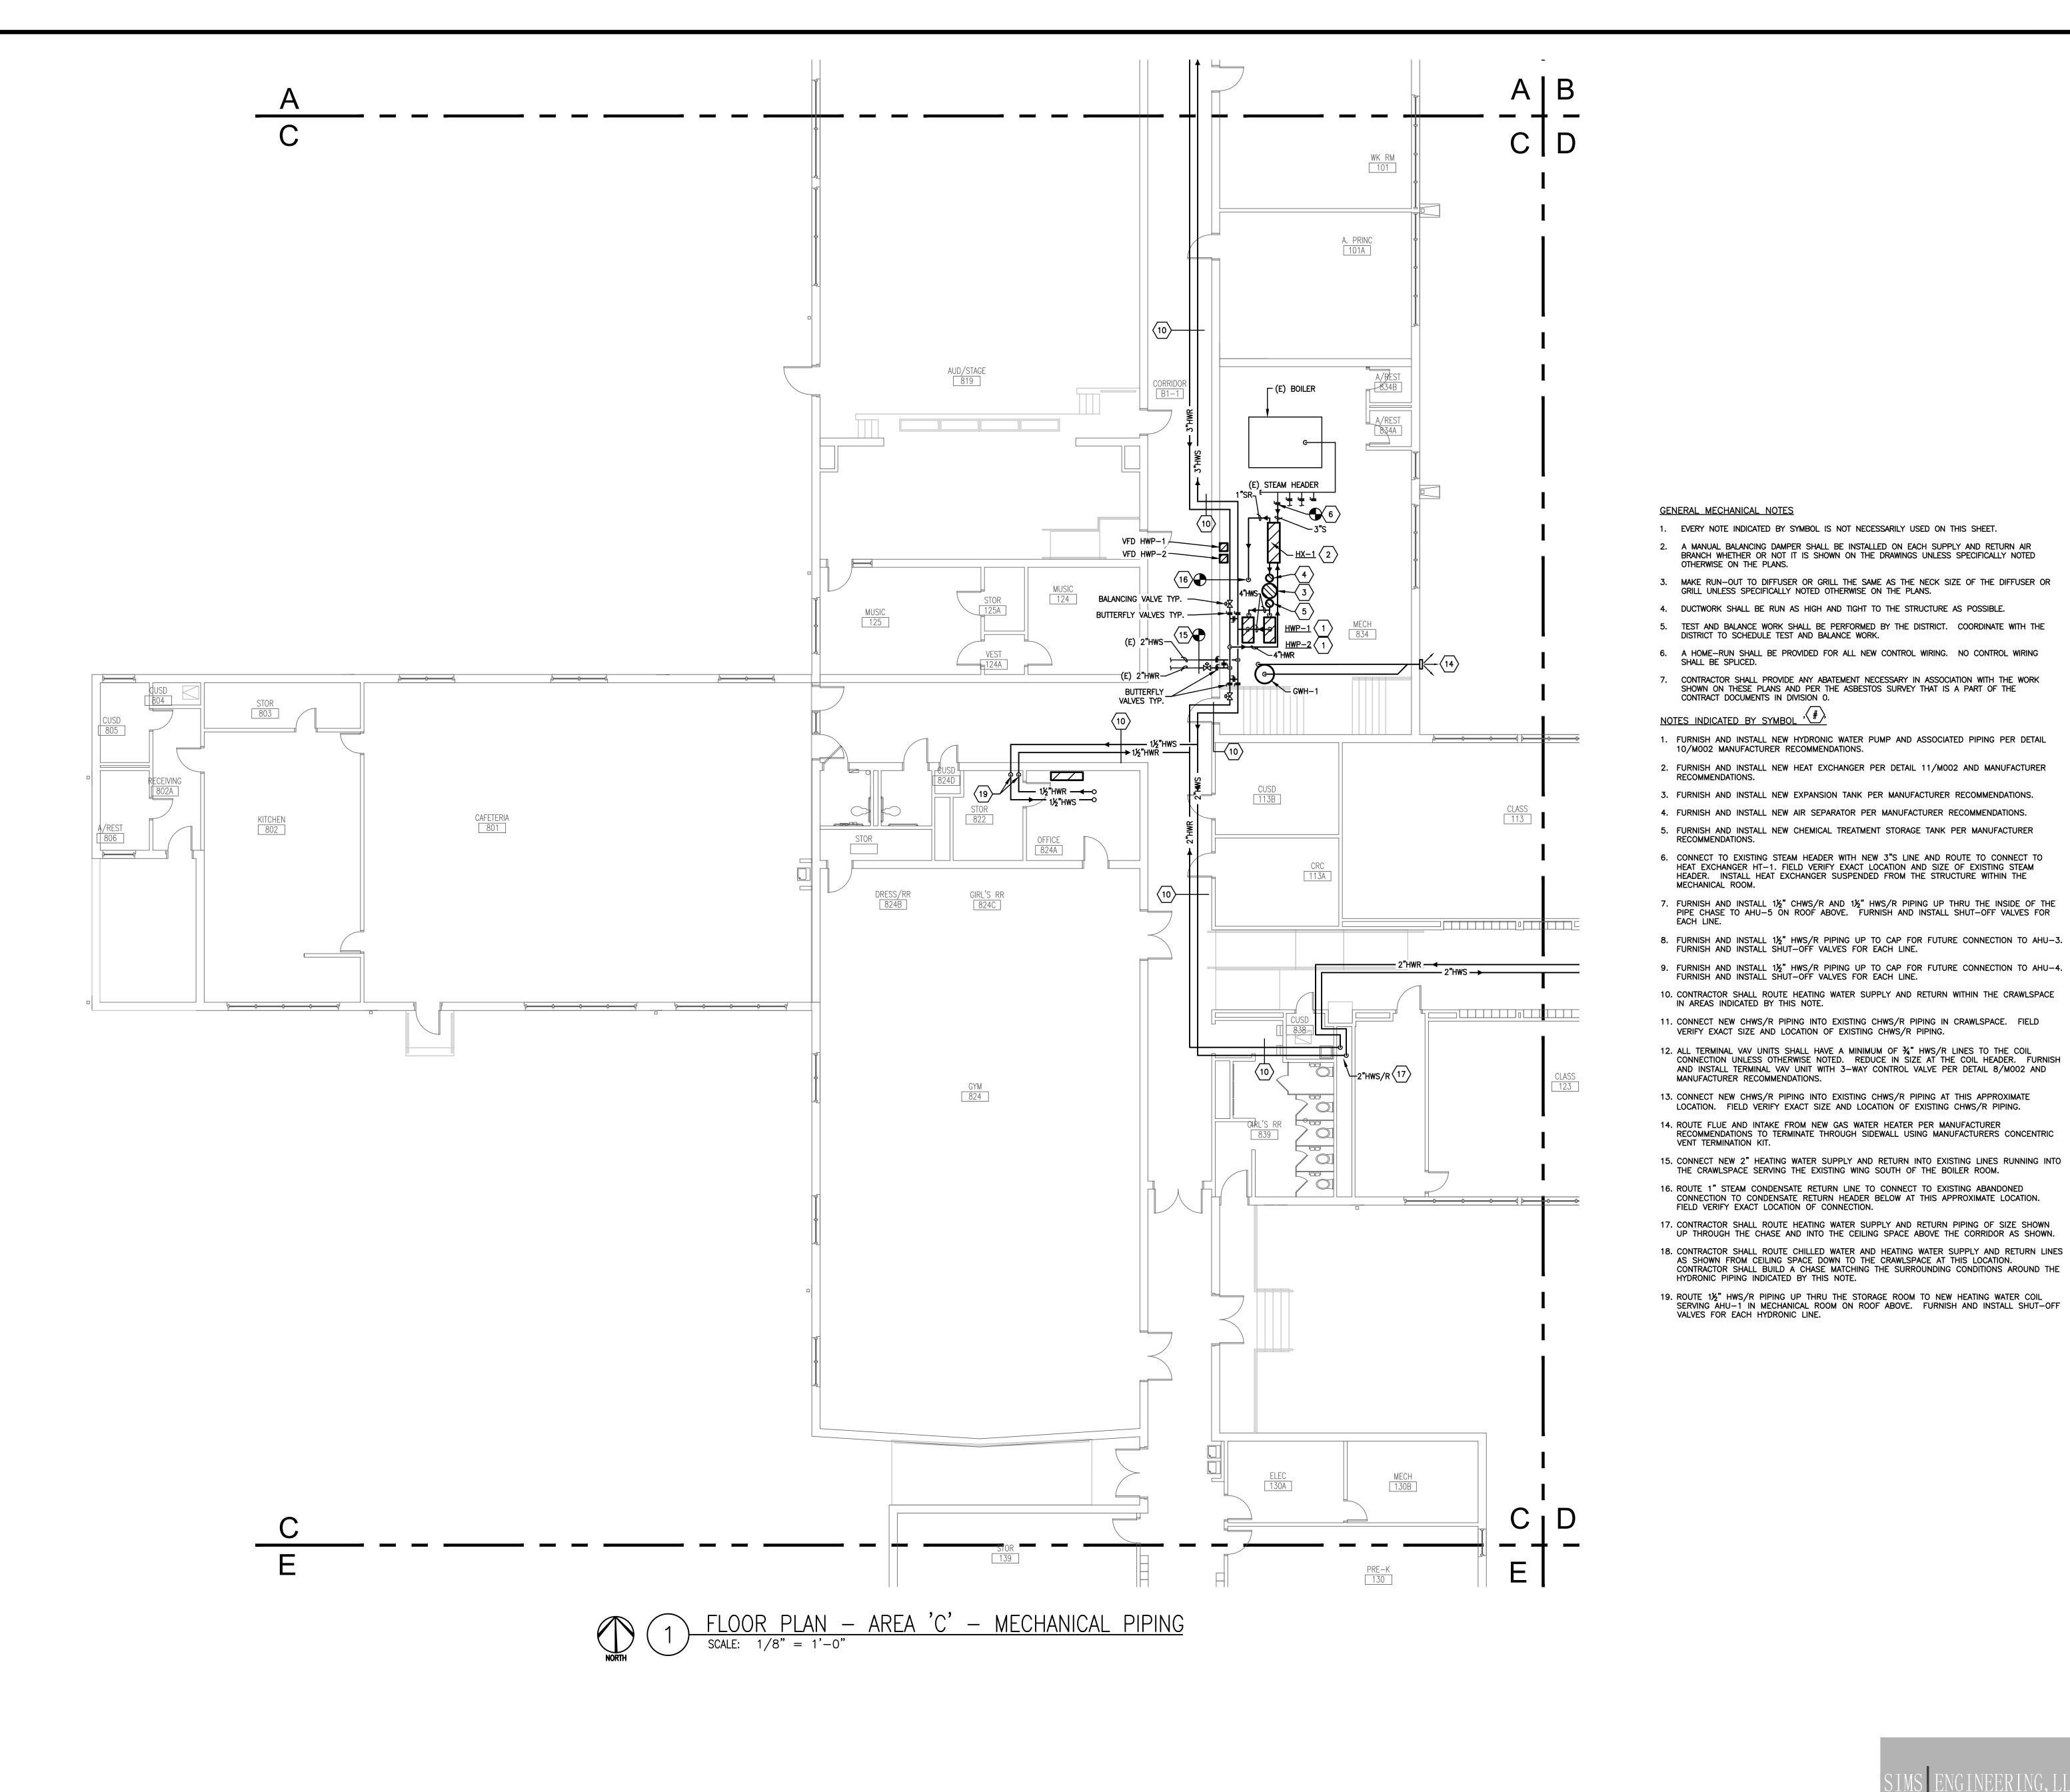
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FLOOR PLAN MECHANICAL PIPING

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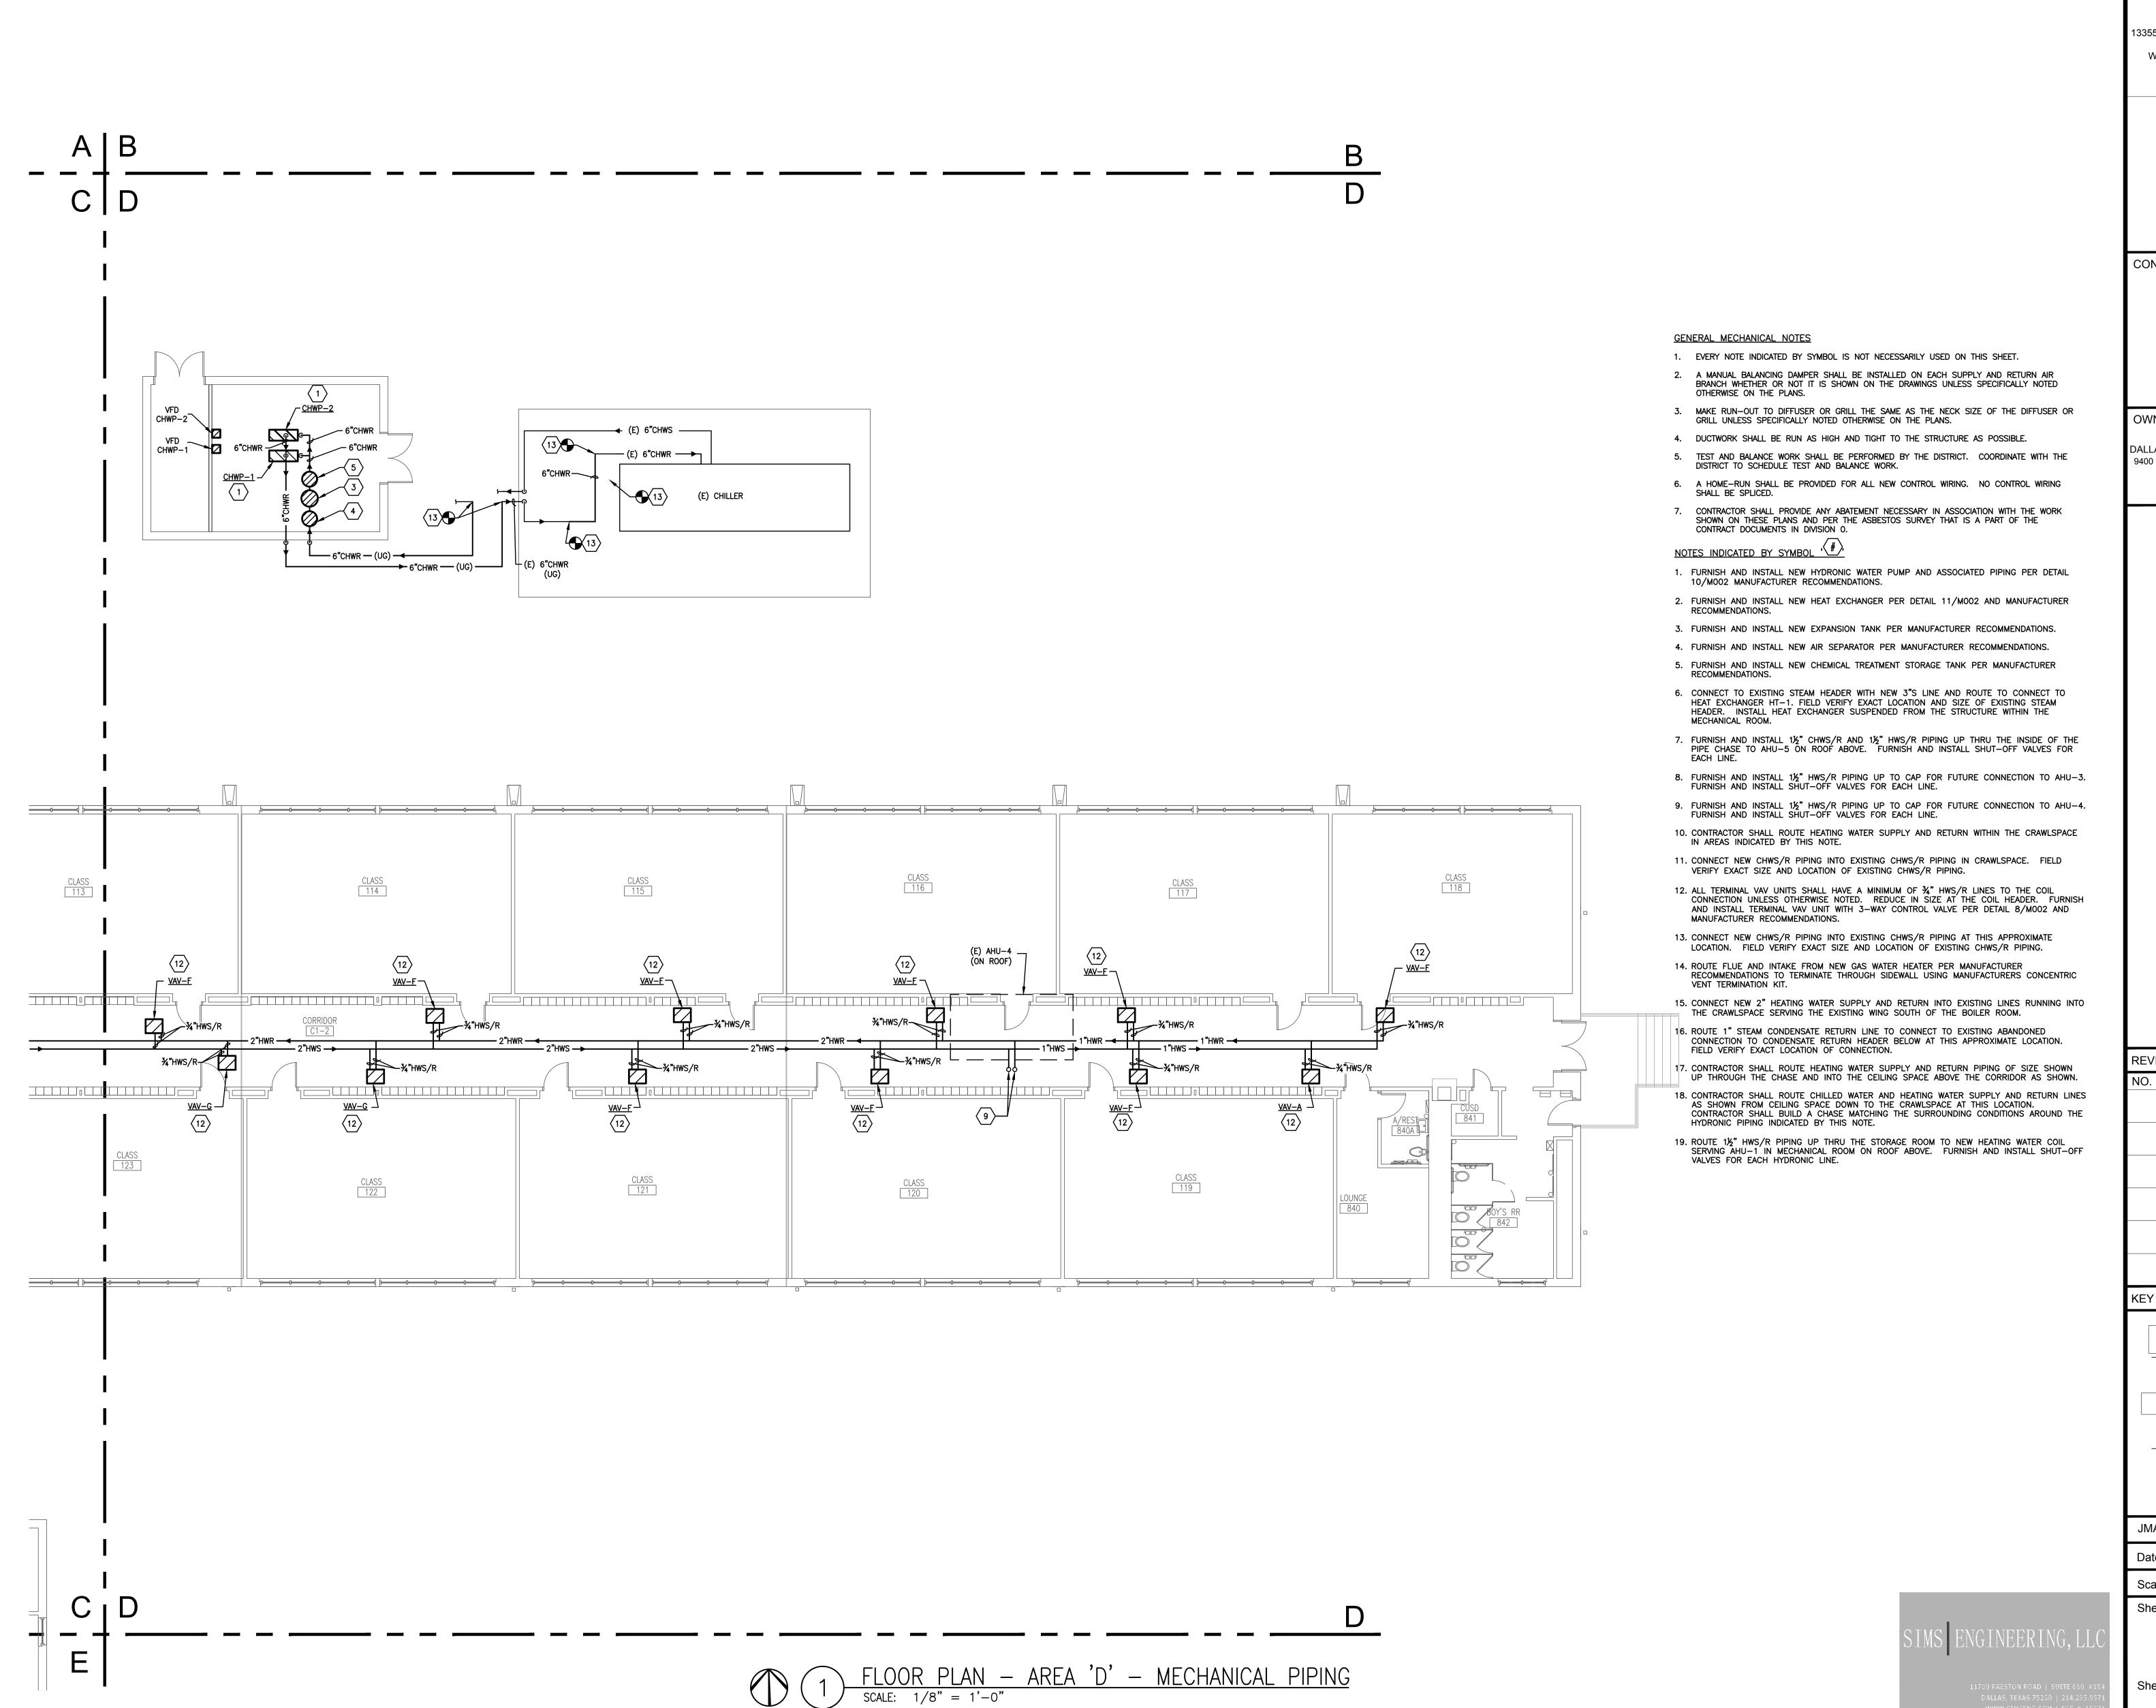
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SIMS ENGINEERING, LLC

FLOOR PLAN MECHANICAL PIPING

M212

3. FURNISH AND INSTALL NEW EXPANSION TANK PER MANUFACTURER RECOMMENDATIONS. 4. FURNISH AND INSTALL NEW AIR SEPARATOR PER MANUFACTURER RECOMMENDATIONS. 5. FURNISH AND INSTALL NEW CHEMICAL TREATMENT STORAGE TANK PER MANUFACTURER 6. CONNECT TO EXISTING STEAM HEADER WITH NEW 3"S LINE AND ROUTE TO CONNECT TO HEAT EXCHANGER HT-1. FIELD VERIFY EXACT LOCATION AND SIZE OF EXISTING STEAM HEADER. INSTALL HEAT EXCHANGER SUSPENDED FROM THE STRUCTURE WITHIN THE 7. FURNISH AND INSTALL 1½" CHWS/R AND 1½" HWS/R PIPING UP THRU THE INSIDE OF THE PIPE CHASE TO AHU-5 ON ROOF ABOVE. FURNISH AND INSTALL SHUT-OFF VALVES FOR 8. FURNISH AND INSTALL 1½" HWS/R PIPING UP TO CAP FOR FUTURE CONNECTION TO AHU-3. FURNISH AND INSTALL SHUT-OFF VALVES FOR EACH LINE. 9. FURNISH AND INSTALL 1½" HWS/R PIPING UP TO CAP FOR FUTURE CONNECTION TO AHU-4. FURNISH AND INSTALL SHUT-OFF VALVES FOR EACH LINE. Indepe 2020 E School 10. CONTRACTOR SHALL ROUTE HEATING WATER SUPPLY AND RETURN WITHIN THE CRAWLSPACE 11. CONNECT NEW CHWS/R PIPING INTO EXISTING CHWS/R PIPING IN CRAWLSPACE. FIELD VERIFY EXACT SIZE AND LOCATION OF EXISTING CHWS/R PIPING. 12. ALL TERMINAL VAV UNITS SHALL HAVE A MINIMUM OF ¾" HWS/R LINES TO THE COIL CONNECTION UNLESS OTHERWISE NOTED. REDUCE IN SIZE AT THE COIL HEADER. FURNISH



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	ELECTRICAL A	BBREVIA	TIONS		LIGHTING SYMBOL LEGEND			WIRING DEVICE SYMBOL LEGEND
SOME ABBREVI	ATIONS MAY NOT APPEAR IN DRAWINGS A	and can differ sl	IGHTLY FROM THOSE SHOWN BELOW	SYMBOLS MA	AY NOT APPEAR IN ALL DRAWINGS AND ARE SHOWN SCHEMATICALLY, NOT NECESSAR	RILY TO SCALE.	SYMBOLS MAY	NOT APPEAR IN ALL DRAWINGS AND ARE SHOWN SCHEMATICALLY, NOT NECESSARILY TO SCALE.
AED AFC	AUTOMATED EXTERNAL DEFIBRILLATOR ABOVE FINISHED COUNTER	MDP MH	MAIN DISTRIBUTION PANEL METAL HALIDE	SYMBOL	DESCRIPTION		SYMBOL	DESCRIPTION
AFF AHJ	ABOVE FINISHED FLOOR AUTHORITY HAVING JURISDICTION	M.H. MLO	MANHOLE MAIN LUGS ONLY MOUNT OR MOUNTED		LIGHTING FIXTURE OF TYPE INDICATED ON PLANS AND/OR LIGHTING FIXTURE	SCHEDULE	ф	SINGLE (SIMPLEX) RECEPTACLE - 20A/125V/2P/3W/G NEMA 5-20R
AIC ATS BFC	AMPS INTERRUPTING CAPACITY AUTOMATIC TRANSFER SWITCH BELOW FINISHED CEILING	MTD MNTG. (MTG) N	MOUNTING NEW DEVICE		LIGHTING FIXTURE ON EMERGENCY CIRCUIT WITH INTEGRAL EMERGENCY BATTER REFER TO FLOOR PLANS AND LIGHTING FIXTURE SCHEDULE FOR ADDITIONAL I	ERY BACKUP, INFORMATION	φ	DUPLEX RECEPTACLE - 20A/125V/2P/3W/G NEMA 5-20R
BOF C	BOTTOM OF FIXTURE	NC (N.C.) NEC	NORMALLY CLOSED NATIONAL ELECTRIC CODE		STRIP LIGHT, SURFACE WRAPAROUND, OR AS DESIGNATED PER LIGHTING FIXTU	TURE SCHEDULE	Ф	CEILING MOUNTED DUPLEX RECEPTACLE - 20A/125V/2P/3W/G NEMA 5-20R
CB, C/B OR CKT BKR	CIRCUIT BREAKER	NF NIC	NONFUSED NOT IN CONTRACT		STRIP LIGHT, SURFACE WRAPAROUND, OR AS DESIGNATED PER LIGHTING FIXTU WITH INTEGRAL EMERGENCY BATTERY BACKUP, REFER TO FLOOR PLANS AND FIXTURE SCHEDULE FOR ADDITIONAL INFORMATION	TURE SCHEDULE LIGHTING	•	FLOOR MOUNTED DUPLEX RECEPTACLE - 20A/125V/2P/3W/G NEMA 5-20R, OR OTHER CONFIGURATION AS INDICATED ON PLANS
CKT	CIRCUIT CLOSED CIRCUIT T.V.	NL NO (N.O.)	NIGHT LIGHT NORMALLY OPEN	<u> </u>	CEILING MOUNTED LIGHT FIXTURE — REGULAR AND EMERGENCY		Ψ	DUPLEX RECEPTACLE SPLIT-WIRED - 20A/125V/2P/3W/G NEMA 5-20R
CLG CUH EC	CEILING CABINET UNIT HEATER EMPTY CONDUIT	PB PNL PTZ (P.T.Z.)	PULL BOX PANEL PAN/TILT/ZOOM	모오	WALL MOUNTED LIGHT FIXTURE — REGULAR AND EMERGENCY		Φ.	DUPLEX RECEPTACLE MOUNTED ABOVE COUNTERTOP
ELEC E	ELECTRIC EMERGENCY	PWR R	POWER RELOCATED DEVICE	4 8			₩	QUADRUPLEX RECEPTACLE (TWO DUPLEX RECEPTACLES UNDER ONE COVER PLATE)
EMS Ep	ENERGY MANAGEMENT SYSTEM EXPLOSION PROOF	RCPT(S) OR RECEPT(S)	RECEPTACLE(S)		CEILING FAN		φ	SPECIAL PURPOSE RECEPTACLE (NEMA DESIGNATION AS INDICATED ON PLANS)
EWC EX	ELECTRIC WATER COOLER EXISTING	REQD. RF	REQUIRED RETURN AIR FAN		TRACK LIGHTING FIXTURE		0 φ	JUNCTION BOX - SIZE & MOUNTING AS REQUIRED
F FA	FUSE FIRE ALARM	SCCR SEF	SHORT CIRCUIT CURRENT RATING SMOKE EXHAUST FAN	- ▼	EXIT SIGN, CEILING OR WALL MOUNTED — SHADING INDICATING SINGLE OR DO DIRECTIONAL ARROWS AS INDICATED	OUBLE FACE;	©	CLOCK HANGER OUTLET - 20A/120V/2P/3W/G RECEPTACLE
FACP, FAP FAPB FCU	FIRE ALARM CONTROL PANEL FIRE ALARM POWER BOOSTER FAN COIL UNIT	SF SO (S.O.) SP	SUPPLY AIR FAN SPACE ONLY SPARE		COMBINATION EMERGENCY EGRESS LIGHTING AND EXIT SIGN, CEILING OR WALL	L MOUNTED	<u> </u>	LOW VOLTAGE TRANSFORMER — MOUNTING AS REQUIRED
FIXT FLR	FIXTURE FLOOR	SPD ST (S.T.)	SURGE PROTECTIVE DEVICE SHUNT TRIP		WALL MOUNTED, BATTERY BACKED EMERGENCY EGRESS LIGHTING FIXTURE		四	TELEVISION
FLUOR FTP, FTS	FLUORESCENT FAN TERMINAL UNIT	SW T	SWITCH TAMPER RESISTANT		EXTERIOR, POLE MOUNTED AREA LUMINAIRE			MULTIOUTLET ASSEMBLY — LENGTH AND OUTLET SPACING AS INDICATED
FTU G, GND	FAN TERMINAL UNIT GROUND (EQUIPMENT)	TEL TF	TELEPHONE TRANSFER FAN	\$	WALL SWITCH SPST, 20A, 120/277V		PP	POWER POLE
GEF GEN	GENERAL EXHAUST FAN GENERATOR	TP TV	TAMPER PROOF TELEVISION	\$ _c	WALL SWITCH SPST, 20A, 120/277V WITH KEY OPERATION		<u> </u>	PHOTOCELL
gfci, gfi gfp hacr	GROUND FAULT CIRCUIT INTERRUPT GROUND FAULT PROTECTION HEATING, A/C, REFRIGERATION	TVSS UF	TRANSIENT VOLTAGE SURGE SUPPRESSION UNDERFLOOR	\$3	3-WAY WALL SWITCH, 20A, 120/277V		•	PUSHBUTTON
HP HV	HORSE POWER HIGH VOLTAGE	UG UH	UNDERGROUND UNIT HEATER	\$.	4-WAY WALL SWITCH, 20A, 120/277V			DOORBELL OR BUZZER SIGNAL DEVICE
HEAT IC	HEAT TRACE INTERRUPTING CAPACITY	UNO (U.N.O.) V	UNLESS NOTED OTHERWISE VOLTAGE	S₀ D	WALL DIMMER SWITCH EQUAL TO LUTRON #N-1000 OR #NF-10 SERIES			DISCONNECT SWITCH - 30A/3P/NF/3R INDICATES 30A, 3-POLE, NON-FUSED, NEMA 3R
INCAN IG	INCANDESCENT ISOLATED GROUND	VAV VB	VARIABLE AIR VOLUME VIEW BOX	\$ _r	WALL MOUNTED DIGITAL TIME SWITCH EQUAL TO WATT STOPPER #TS-400			FUSED DISCONNECT SWITCH - 30A/3P/25AF/3R INDICATES 30A, 3-POLE, WITH 25A FUSE,
JB JB	SHORT CIRCUIT CURRENT JUNCTION BOX KITCHEN EXHAUST FAN	VFD VP	VARIABLE FREQUENCY DRIVE VAPOR PROOF VARIABLE VOLUME UNIT	\$,	WALL SWITCH SPST, 20A, 120V OR 277V WITH LIGHTED HANDLE		 호	NEMA 3R MOTOR STARTER FVNR UNO; NUMBER INDICATES NEMA SIZE
Kef Ltg Lts	LIGHTING LIGHTS	W W/	WIRE WITH	••	OCCUPANCY SENSOR — CEILING AND WALL MOUNTED. REFER TO OCCUPANCY SCHEDULE FOR ADDITIONAL INFORMATION.	r sensor	⊠'	COMBINATION MOTOR CONTROLLER/DISCONNECT SWITCH
LV MATV	LOW VOLTAGE MASTER ANTENNA	WG WP	WIRE GUARD WEATHER PROOF/EXTERIOR RATED	PP P	20A, 120/277V OCCUPANCY SENSOR POWER PACK FOR LED, FLUORESCENT	&	MED-	VARIABLE FREQUENCY DRIVE
MCB MCC	MAIN CIRCUIT BREAKER MOTOR CONTROL CENTER	WT XFMR	WATER TIGHT TRANSFORMER		INCÂNDESCENT LIGHTING LOADS		S _M	MANUAL MOTOR CONTROLLER
	GENERAL	L +XX NOTATIO	MOUNTING HEIGHT, INCHES AFF		TELECOM & DATA SYMBOL LEGEND		<i>-</i> ∗	MOTOR
	GLNLRAL	NOTATIO	/IN	-	AY NOT APPEAR IN ALL DRAWINGS AND ARE SHOWN SCHEMATICALLY, NOT NECESSAR	RILY TO SCALE.		ELECTRICAL DISTRIBUTION PANELBOARD — 480V OR 600V
(2)	- KEYED NOTE: DENOTES "SEE NOTE N		DEFEN TO FOURNIEUT DROMOED	SYMBOL	DESCRIPTION TELEPHONE PLATE - PROVIDE CAT6 UTP CABLES, DROP COMPLETE WITH COM-	MOUNT CARIE		ELECTRICAL DISTRIBUTION PANELBOARD — 250V OR BELOW
—	- EQUIPMENT (ID) NUMBER FOR COORD DOCUMENTS FOR EXACT DEFINITION /	AND REQUIREMENTS.		WALL FLOOR	CONNECTORS & TERMINATION AS REQUIRED FOR LOCATION. DATA PLATE - PROVIDE (1) CAT6 UTP CABLE DATA DROP COMPLETE WITH CO	, ,		ELECTRICAL PANELBOARD — 480V OR 600V
02/E7.0 E5.01	 1 - DENOTES: REFERENCE DETAIL 02 ON - DENOTES: REFERENCE ENLARGED DET 	•		WALL FLOOR	CONNECTIONS, & TERMINATION AS REQUIRED FOR LOCATION. TELE/DATA PLATE - PROVIDE CAT6 UTP CABLES, DATA DROP COMPLETE WITH			ELECTRICAL PANELBOARD — 250V OR BELOW
(5.01)				WALL FLOOR	CABLE, CONNECTORS, & TERMINATION AS REQUIRED FOR LOCATION.	n condoil,		SPECIAL PANEL
	FIRE ALARM SY	MBOL LE	EGEND	Ф	CEILING MOUNTED BOX FOR DATA OUTLET(S).			ELECTRICAL CONNECTION TO EQUIPMENT
SYMBOLS MAY	NOT APPEAR IN ALL DRAWINGS AND ARE	E SHOWN SCHEMATION	CALLY, NOT NECESSARILY TO SCALE.	₩	4" SQUARE BOX WITH SINGLE GANG ADAPTER FOR CATV SYSTEM OUTLET.	<u>, </u>	-#-	CIRCUIT CONDUCTOR INDICATION (ISOLATED GROUND, EQUIPMENT GROUND, PHASE, NEUTRAL)
SYMBOL		DESCRIPTION		1			11.	CIRCUIT HOMERUN TO PANELBOARD
M	SMOKE DOOR HOLDER			1	ELECTRICAL DEMOLITION NOTES A. INFORMATION PROVIDED ON THESE DEALWINGS IS TAKEN FROM ARCHIVED DESIGN DRAWINGS		x,x,x	THREE SINGLE POLE DEVICE CIRCUIT NUMBERS
SD	MOTORIZED FIRE, SMOKE OR FIRE/SI	MOKE DAMPER		1	AND FIELD CREEKVATIONS. CONTRACTORS SHALL VERIFY ALL EXISTING CONDITIONS PRIOR TO PRICING AND COMMENCEMENT OF WORK.		x/x/x	MULTI-POLE DEVICE CIRCUIT NUMBERS
FAA	FIRE ALARM REMOTE ANNUNCIATOR			1	B. REFER TO ARCHITECTURAL PLANS FOR SPECIFIC AREAS OF DEMOLITION. PROVIDE FOR ANY AND ALL DEMOLITION WORK NECESSARY TO ACCOMMODATE NEW CONSTRUCTION, INCLIDING ARCHITECTURAL, MECHANICAL, PLUMBING AND ELECTRICAL, FIRE ALARM AND/OR LOW VOLTAGE WORK, CONTRACTOR SHALL RELOCATE ANY AND ALL EXSTING ELECTRICAL, FIRE ALARM AND LOW VOLTAGE EQUIPMENT, DEVICES AND CONDUIT AS REQUIRED FOR NEW		~~^	GROUND BAR
FACP	FIRE ALARM CONTROL PANEL			1	WORK INCLUDING BUT IS NOT LIMITED TO CEILING MODIFICATIONS, WALL MODIFICATIONS, DUCTWORK RUNS. ETC., ELECTRICAL DEVICES AND ASSOCIATED WIRING LOCATED		SPD	SURGE PROTECTION DEVICE
F	FIRE ALARM PULL STATION			1	WITHIN THE DEMOLITION AREA THAT WILL NO LONGER BE USED SHALL BE REMOVED AND PROPERLY DISPOSED OF AT CONTRACTORS EXPENSE UNLESS OTHERWISE NOTED. IF DEMOLITION OF AN EXISTING AREA TO REMAIN IS REQUIRED FOR NEW INSTALLATION WORK, THE CONTRACTOR SHALL RESTORE THE AFFECTED AREA AND		ATS	AUTOMATIC TRANSFER SWITCH
	FIRE ALARM AUDIBLE & VISUAL SIGN.	AL		1	REPLACE DAMAGED ITEMS WITH MATCHING NEW ITEMS. FOR ALL ELECTRICAL, LIGHTING, FIRE ALARM, PA, SECURITY SYSTEM COMPONENTS BEING REPLACED WITH NEW, CONTRACTOR SHALL PROVIDE ALL REQUIRED PATCHING AND REPAIR REQUIRED AFTER REMOVAL OF DEVICES.			AUTOMATIC DOOR SENSOR
					C. THE ELECTRICAL CONTRACTOR SHALL BE RESPONSIBLE FOR DEENERGIZING CIRCUITS IN DEMOLITION AREAS TO INSURE A SAFE CONDITION.		•	, o. omenio doon obtoon
WALL CLG	FIRE ALARM AUDIBLE SIGNAL				D. WHERE EXISTING CEILINGS AND WALLS ARE DEMOLISHED, REMOVE ALL AFFECTED LIGHTING FIXTURES, DEVICES, HANGERS, ASSOCIATED CONDUITS AND WIRING FROM THESE LOCATIONS. ONLY THE EXISTING HOMERUN WIRING IS TO REMAIN IF CIRCUIT IS TO BE REUSED.			
¢E €	FIRE ALARM VISUAL SIGNAL				OTHERWISE DEMO ALL CIRCUITS TO PANEL. ENERGIZE ALL EXISTING DEVICES TO REMAIN THAT WERE INTERRUPTED DURING DEMOLITION. WHERE ENTIRE CIRCUITS ARE REMOVED, TURN THE CIRCUIT BREAKER OFF AND LABEL AS "SPARE". COORDINATE WITH OWNER TO DETERMINE IF UNUSED LIGHTING FIXTURES SHALL BE TURNED OVER OR DEMOUSHED.			
FS	FIRE ALARM SPRINKLER FLOW SWITCH	н]	E. ALL EXISTING ELECTRICAL RACEWAYS OR CABLES THAT ARE TO REMAIN IN AREAS WHERE CEILINGS ARE DEMOLISHED SHALL BE SUPPORTED BY THIS CONTRACTOR. ELECTRICAL RACEWAYS AND CABLES SHALL BE SUPPORTED AS REQUIRED BY APPLICABLE NEC			
ET	FIRE ALARM SPRINKLER TAMPER SWIT	тсн]	ARTICLES AND LOCAL AHJ REQUIREMENTS. BUNDLE LOW VOLTAGE SIGNAL CABLES TOGETHER USING TIE-WRAPS AND SUPPORT ABOVE CEILING WITH "U" BRACKETS OR "J" HOOKS ON A MINIMUM OF 4" TO 6" INTERVALS. FIRE ALARM CABLES SHALL NOT BE			
PS	FIRE ALARM SPRINKLER PRESSURE S	SWITCH			BUNDLED WITH OTHER CABLES AND SHALL BE SUPPORTED SEPARATELY FROM DATA, SECURITY, AND COMMUNICATIONS CABLING. THE CONTRACTOR SHALL FIELD DETERMINE THE BEST METHOD TO ACCOMMODATE OBSTRUCTIONS PRIOR TO SUPPORT INSTALLATION. CONTRACTOR SHALL ASSUME ALL LOW VOLTAGE SIGNAL CABLES ARE ACTIVE TO REMAIN,			
\$ \$,	SMOKE DETECTOR, CEILING OR DUCT	MOUNTED			UNLESS NOTED OTHERWISE. REPAIR OF REMAINING CABLES DAMAGED DURING WORK SHALL BE THE RESPONSIBILITY OF THE CONTRACTOR. F. UNLESS NOTED OTHERWISE, IN AREAS WHERE EXISTING LIGHTS OR NOTES ARE NOT			
_	i				The state of the s	T .		

- **GENERAL ELECTRICAL NOTES** THE CONTRACTOR SHALL VISIT THE SITE PRIOR TO SUBMITTING ANY PROPOSAL AND BECOME FAMILIAR WITH THE CONDITIONS UNDER WHICH THE WORK WILL BE PERFORMED. SITE OBSERVATIONS SHALL BE CORRELATED WITH THE REQUIREMENTS OF THE CONTRACT DOCUMENTS. CONTRACTOR SHALL REPORT ANY CONDITION THAT, IN HIS OPINION, PREVENTS THE PROPER INSTALLATION OF THE ELECTRICAL WORK AND ANY INCONSISTENCIES DISCOVERED SHALL BE REPORTED TO THE ARCHITECT AND ENGINEER IMMEDIATELY.

 38. CONDUIT FILL IS CALCULATED BASED ON TYPE THAN INSULATION AND CONCENTRIC STRANDED CONDUCTORS.

 39. PANELBOARDS SHALL CONSIST OF A BOX, FRONT, INTERIOR AND CIRCUIT PROTECTIVE DEVICES AND BE MANUFACTURED IN ACCORDANCE WITH NEITHER DEAD FRONT INTERIOR SHALL HAVE COPPER BUSSING, COPPER 39. PANELBOARDS SHALL CONSIST OF A BOX, FRONT, INTERIOR AND CIRCUIT PROTECTIVE DEVICES AND BE MANUFACTURED IN ACCORDANCE WITH NEMA AND UL THE DEAD FRONT INTERIOR SHALL HAVE COPPER BUSSING, COPPER NEUTRAL AND GROUND BARS, CIRCUIT BREAKERS SHALL BE AS REQUIRED BELOW AND SHALL BE FULLY AIC RATED. PANELBOARDS DESIGNED FOR 10KAIC UDH, 120/208V 3 PHASE, 4 WIRE SERVICE SHALL BE SQUARE D NQOD SERIES, BOLT—IN BRANCH BREAKERS OR EQUAL. PANELBOARDS SHALL HAVE A MINIMUM SHORT CIRCUIT CURRENT RATING AND LUG CONNECTIONS AS REQUIRED TO PROVIDE ADEQUATE PROTECTION FROM UTILITY FAULT CURRENT. CONTRACTOR SHALL VERIFY UTILITY FAULT CURRENT IN ORDER TO DETERMINE THE AIC RATING OF ALL PANELBOARD SETTING OF ALL BREAKERS. PANELBOADS SHALL BE LISTED WITH AVAILABLE FAULT CURRENT. THE CONTRACTOR SHALL OBTAIN ALL NECESSARY PERMITS, PAY ALL FEES, AND COMPLY WITH THE APPLICABLE NATIONAL, STATE & MUNICIPAL LAWS, CODES AND ORDINANCES RELATED TO BUILDING AND PUBLIC SAFETY. 3. ALL ELECTRICAL PRODUCTS AND INSTALLATIONS SHALL COMPLY WITH APPLICABLE MATIONAL, STATE AND LOCAL CODES. ALL WORK SHALL BE PERFORMED IN ACCORDANCE WITH CURRENT RULES, REGULATIONS, AND INDUSTRY SHADARDS OF THE 2023 NATIONAL ELECTRICAL CODE (NEC), UL, NEMA, HFPA, OSHA, NATIONAL ELECTRICAL SAFETY CODE, TAS/ADA, 2021 INTL EMERGY CONSERVATION CODE, 40 2021 INTL BUILDING CODE, LANDLORD CRITERIA, AND ANY LOCAL CODES, LAWS OR ORDINANCES. 40. ACCEPTABLE MANUFACTURERS: SIEMENS CO., SQUARE D CO., GENERAL ELECTRIC CO., EATON, A SINGLE SOURCE MANUFACTURER IS REQUIRED FOR ALL ELECTRICAL EQUIPMENT. 4. REFER TO SPECIFICATIONS REGARDING MATERIALS AND METHODS FOR ELECTRICAL CONSTRUCTION. DISCONNECT SWITCHES: DISCONNECT SWITCHES SHALL BE HEAVY DUTY TYPE, INDOOR OR OUTDOOR PER LOCATION, SOUD NEUTRAL, VISIBLE BLADE, LOCKABLE, 5. FURNISH ALL EQUIPMENT, MATERIALS AND LABOR REQUIRED FOR COMPLETE, WORKING AND COORDINATED SYSTEMS. PROVIDE PRODUCTS NOT MENTIONED BUT OBVIOUSLY NECESSARY AND INCIDENTAL TO THE COMPLETION OF THIS WORK.UNLESS NOTED OTHERWISE, THE ELECTRICAL CONTRACTOR IS RESPONSIBLE FOR ALL WORK OF AN ELECTRICAL NATURE. THE TERM "PROVIDE" USED IN THESE DOCUMENTS SHALL BE DEFINED AS "FURNISH AND INSTALL" 6. UNLESS OTHERWISE NOTED, ALL EQUIPMENT AND MATERIALS SHALL BE NEW AND U.L. LISTED OR LABELED, AND OF A SPECIFICATION GRADE. EQUIPMENT AND MATERIALS SHALL BE INSTALLED IN ACCORDANCE WITH THE MANUFACTURER'S RECOMMENDATIONS, LISTING OR LABELING REQUIREMENTS AND RESTRICTIONS. PROVIDE SUBMITTAL DATA AS DEPICTED IN THE ELECTRICAL SPECIFICATIONS. CONTRACTOR SHALL NOT MAKE PRODUCT SUBSTITUTIONS WITHOUT PRIOR APPROVAL. SHALL DEVARUAT CARRARY UVERGUARRENT PROTECTION DEVICES (CIRCUIT BREAKERS)
 SHALL BE INVERSE TIME THERMAL MAGNETIC BOLT—ON CIRCUIT BREAKERS, RATED
 20 AMPERES, UNLESS OTHER AMPACITY IS NOTED. MULTI—POLE BREAKERS SHALL
 BE INTEGRAL UNITS. USE OF HANDLE TIES IS NOT ACCEPTABLE. WHERE THE
 PANEL IS EXISTING, THE BREAKER SHALL BE OF THE SAME MANUFACTURER AS
 THE PANELBOARD. 44. GROUND FAULT INTERRUPT: CIRCUIT BREAKERS SERVING WEATHER PROOF RECEPTACLES, RECEPTACLES EXPOSED TO WATER OR MOISTURE, OR RECEPTACLES LIKELY TO SERVE EQUIPMENT IN CLOSE PROXIMITY TO WATER SHALL BE GROUND FAULT INTERRUPTING. ALL RECEPTACLES WITHIN 6'-0" OF A SINK OR LAWATORY SHALL HAVE GFI PROTECTION. ALL WORK DONE SHALL BE PERFORMED BY QUALIFIED ELECTRICIAN UNDER THE SUPERVISION AND DIRECTION OF A SUPERINTENDENT HAVING SUCCESSFUL EXPERIENCE INSTALLING AND SUPERVISING EQUIPMENT AND SYSTEMS OF SIMILAR TYPE AND SIZE AS INDICATED BY CONTRACT DOCUMENTS. 5. ALL FUSES SHALL BE UL LISTED CURRENT LIMITING, TIME DELAY REJECTION TYPE, 200,000 AIC, 600 VOLT. 600A OR LESS - CLASS J, ABOVE 600g - CLASS L ACCEPTABLE MANUFACTURERS: BUSSMAN, GOULD SHAMMUT. 8. PROVIDE SHOP DRAWINGS FOR APPROVAL OF ALL ELECTRICAL ITEMS PROPOSED TO BE INSTALLED UNDER THIS CONTRACT. ANY DEVATIONS FROM ITEMS SPECIFIED SHALL BE CLEARLY IDENTIFIED. NO WORK IS AUTHORIZED WITHOUT SHOP DRAWINGS REVIEWED BY THE ENGINEER. 46. AS PER NEC 110.11, UNLESS IDENTIFIED FOR USE IN THE OPERATING ENARONMENT, NO CONDUCTORS OR EQUIPMENT SHALL BE LOCATED IN DAMP OR WET LOCATIONS; WHERE EXPOSED TO GASES, FUMES, VAPORS, LIQUIDS OR OTHER AGENTS THAT HAVE A DETERIORATING EFFECT ON THE CONDUCTORS OR EQUIPMENT OR WHERE EXPOSED TO EXCESSIVE TEMPERATURE. EQUIPMENT NOT IDENTIFIED FOR OUTDOOR USE AND EQUIPMENT IDENTIFIED ONLY FOR INDOOR USE, SUCH AS DRY LOCATIONS, INDOOR USE ONLY, DAMP LOCATIONS OR ENCLOSURE TYPES 1, 2, 5, 12, 12K AND/OR 13 SHALL BE PROTECTED AGAINST DAMAGE FROM THE WEATHER DURING CONSTRUCTION. 9. ALL POWER WINING SHALL BE INSTALLED IN CONDUIT. POWER CONDUCTORS SHALL BE COPPER THIN/THINN, #12 AWG, MINIMUM. 10. ALL EMPTY CONDUIT SYSTEMS SHALL CONTAIN A PULL CORD FOR FUTURE PULLING OF CONDUCTORS. 11. REFER TO AND COORDINATE WITH ARCHITECTURAL DRAWINGS FOR EXACT DIMENSIONS, HEIGHTS, CONFIGURATION AND FINISHES OF ALL WIRING DEVICES, LIGHT FIXTURES, AND EQUIPMENT. VERIFY EXACT LOCATION OF OUTLETS AND DEVICES WITH ARCHITECT PRIOR TO ROUGH—IN. PROVIDE OUTLETS BOXES, 48. TELEPHONE OUTLETS, RECEPTACLES, AND RACEWAYS SHALL BE FURNISHED AND INSTALLED BY THE CONTRACTOR. FOR WALL MOUNTED DATA OR PHONE OUTLET; PROVIDE 3/4° EMT WITH CONTINUOUS PULL STRINGS/ROPES, LABELED ON BOTH ENDS; MOUNT 18° A.F.F., U.O.N. ALL DATA AND LOW VOLTAGE CONDUITS TO RECEIVE CONTINUOUS PULL STRINGS FOR OWNER'S VENDER USE. VERIFY EXACT REQUIREMENTS WITH TENANTS REPRESENTATIVE. 12. COORDINATE WORK AND SCHEDULING WITH ALL OTHER TRADES, GIVE SPECIAL CONSIDERATION TO COORDINATING INSTALLATION OF LIGHTING, PILLIEBING PIPING AND DUCTWORK, COORDINATE WALL OUTLET LOCATIONS WITH MILLWORK, COORDINATE WALL SWITCHES WITH DOOR SWINGS, VERIFY EXACT LOCATION, COLOR AND FINISH OF OUTLETS AND DEVICES WITH THE ARCHITECT. 13. REFER TO AND COORDINATE WITH MECHANICAL FOR THE LOCATION OF ALL ITEMS LOCATED IN THE CEILING INCLUDING, BUT NOT LIMITED TO, SUPPLY—AIR DIFFUSERS, RETURN—AIR GRILLS, FIRE SPRINKLER HEADS AND EXHAUST DUCTS. 49. ELECTRICAL LOADS SHALL BE APPROXIMATELY BALANCED ACROSS ALL THREE PHASES TO WITHIN 10%. 50. ALL CONVENIENCE OUTLETS SHOWN SHALL BE NEMA TYPE 5-20R, SPECIFICATION GRADE RECEPTACLES WITH NYLON COVERPLATES IN COMMON AREAS AND STAINLESS STEEL COVERPLATES IN KITCHEN AND BATHROOM. COORDINATE COLOR SCHEME WITH ARCHITECT. INSTALL AT ADA REQUIRED 18" AFF, UNLESS OTHERWISE MOTED. CONTROL DEVICES WITH OTHER TRADES AND MANUFACTURER'S SHOP DRAWINGS
 PRIOR TO CONSTRUCTION OR INSTALLATION, REFERENCE TECHNOLOGY DRAWINGS
 AND ARCHITECTURAL ELEVATIONS FOR MOUNTING HEIGHTS. 15. ALL PENETRATIONS THROUGH FIRE RATED WALLS OR PARTITIONS SHALL BE MADE IN ACCORDANCE WITH U.L. 483 "FIRE RESISTANCE DIRECTORY". PENETRATIONS SHALL BE SLEEVED AND SEALED WITH A UL APPROVED FIRE RATED SEALANT. REFER TO ARCHITECTURAL PLANS FOR FIRE RATED WALLS. 51. PER NEC 300.5(J) WHERE DIRECT BURIED CONDUCTORS, RACEWAYS OR CABLES ARE SUBJECT TO MOVEMENT BY SETTLEMENT OR FROST, THEY SHALL BE ARRANGED SO AS TO PREVENT DMAAGE TO THE ENCLOSED CONDUCTORS OR TO EQUIPMENT CONNECTED TO THE RACEWAYS. PROVIDE EXPANSION JOINTS AS REQUIRED. 7. CONDUIT ROUTING SHOWN IS SYMBOLIC AND DIAGRAMMATIC. INSTALL CONDUIT TO FIT ACTUAL FIELD CONDITIONS. COORDINATE ROUTING WITH ENGINEER IN FIELD WHERE DRAWINGS DO NOT REFLECT ACTUAL CONDITIONS. NOTE SUCH CONDITIONS IN SHOP DRAWINGS. CONDUIT SHALL NOT BE RUN IN OR THROUGH DUCTWORK.
- 53. EQUIPMENT GROUNDING CONDUCTORS SHALL HAVE A CONTINUOUS OUTER FINISH THAT IS EITHER GREEN OR GREEN WITH ONE OR MORE YELLOW STRIPES. EQUIPMENT GROUNDING CONDUCTORS 4 AWG AND LARGER SHALL BE PERMANENTLY IDENTIFIED AS AN EQUIPMENT GROUNDING CONDUCTOR AT EACH END AND AT EVERY POINT WHERE IT IS ACCESSIBLE. IDENTIFICATION SHALL ENCIRCLE THE CONDUCTOR AND SHALL BE ACCOMPLISHED BY TRIPPING THE INSULATION OR COVERING FROM THE ENTIRE EXPOSED LENGTH, COLORING THE INSULATION OR COVERING GREEN AT THE TERMINATION OR MARKING THE INSULATION OR COVERING WITH GREEN TAPE OR GREEN ADHEVISE LABELS AT THE TERMINATION. 22. ALL GFI RECEPTACLES SHALL BE WIRED TO SELF-PROTECT ONLY AND SHALL NOT AFFECT POWER TO ANY DOWNSTREAM DEVICES, UNLESS SPECIFICALLY NOTED OTHERWISE.

 55. PROVIDE CONTROL WRING AND CONDUIT FROM ALL NECESSARY AIR CONDITIONING CONTROLS. VERIFY EXACT REQUIREMENTS WITH EQUIPMENT SUPPLIER AND HVAC CONTRACTOR.
- 23. INSTALL ALL RECEPTACLES THROUGHOUT THE PROJECT WITH THE GROUND POLE AT THE TOP OF THE CONFIGURATION WHEN MOUNTED VERTICALLY, AND ON THE LEFT WHEN MOUNTED HORIZONTALLY.

 56. PROVIDE HEAVY DUTY RATED DISCONNECT SMITCHES, FUSED OR NONFUSED AS NOTED, AND VOLTAGE AS APPROPRIATE OR INDICATED ON PLANS RATED AT 200,000 AIC. 57. IN GENERAL, FIXTURE TYPES ARE TO BE AS SPECIFIED OR APPROVED EQUAL. VERIFY REQUIREMENTS WITH ARCHITECT. ACCEPTABLE MANUFACTURERS SHALL BE MAJOR BRANDS SUCH AS PHILIPS BRANDS, WILLIAMS, BEGA, SELUX, FINELITE, HUBBELL, ACUITY BRANDS, COLUMBIA, KIM, PRESCOLITE, EATON BRANDS. 24. DISCONNECTING MEANS FOR ALL MECHANICAL AND PLUMBING EQUIPMENT SHALL BE MOUNTED INDEPENDENTLY OF THE PIECE OF EQUIPMENT. 58. REFERENCE LIGHTING FIXTURE SCHEDULE AND REFLECTED CEILING PLAN FOR COMPLETE DESCRIPTION OF EACH FIXTURE TYPE, LIGHT FIXTURES ARE IDENTIFIED BY LETTERS AND SYMBOLS. ALL EMERGENCY FIXTURES SHALL HAVE CLEAR
- 26. SPACE ALLOCATIONS FOR MATERIALS, EQUIPMENT AND DEVICES HAVE BEEN MADE ON THE BASIS OF PRESENT AND KNOWN FUTURE REQUIREMENTS AND THE DIMENSIONS OF ITEMS OF EQUIPMENT OR DEVICES OF A PARTICULAR MANUFACTURER WHETHER INDICATED OR NOT. THE CONTRACTOR SHALL VERIFY THAT ALL MATERIALS, EQUIPMENT AND DEVICES PROPOSED FOR USE ON THIS PROJECT ARE WITHIN THE CONSTRAINTS OF THE ALLOCATED SPACE. 59. EACH ROOM SHALL BE CONTROLLED BY INDIVIDUAL WALL SWITCHES OR OCCUPANCY SENSORS AS SHOWN ON THE DRAWINGS, WALL SWITCH OCCUPANCY SENSOR SHALL BE ACUITY WSX PDT DUAL TECHNOLOGY. CEILING SENSORS SHALL BE ACUITY DUAL TECHNOLOGY MOTION SENSOR WITH DAYLIGHT SENSOR AS REQUIRED. OVERRIDE SWITCH SHALL BE ACUITY GR 2400 CHELSEA. 27. THE CONTRACTOR SHALL PROVIDE THE ARCHITECT A COMPLETE SET OF "AS BUILT" DRAWINGS FOR ALL WORK PERFORMED PER THE ARCHITECTS INSTRUCTIONS. 28. ALL LUMINARIES SHALL BE SUPPORTED IN ACCORDANCE WITH NEC 410.30 & 410.36.

 410.36.

 29. ALL ELECTRICAL DISTRIBUTION EQUIPMENT, PANELBOARDS AND OTHER ENCLOSED FOR INDICATED IN THE CONTRACT DOCUMENTS

 61. SWITCH LOCATIONS: TYPICAL SWITCHING SHALL BE LOCATED INSIDE EACH ROOM NEAR THE STRIKE SIDE OF EACH DOOR, UNLESS OTHERWISE SHOWN OR NOTED ON PLANS, MOUNT SWITCHES AT 42" AFF OR AS DIRECTED BY ARCHITECT, ALL SWITCH LOCATIONS TO BE COORDINATED WITH OWNER AT ROUGH IN.
- 29. ALL ELECTRICAL DISTRIBUTION EQUIPMENT, PANELBOARDS AND OTHER ENCLOSED EQUIPMENT SHALL BE IDENTIFIED AS INDICATED IN THE CONTRACT DOCUMENTS AND SHALL BE IDENTIFIED AS INDICATED IN THE CONTRACT DOCUMENTS AND SHALL BE IDENTIFIED AS INDICATED IN THE CONTRACT DOCUMENTS AND SHALL BE IDENTIFIED AS INDICATED IN THE CONTRACT DOCUMENTS AND SHALL BE IDENTIFIED PERSONS OF POTENTIAL ELECTRIC ARC FLASH HAZARDS AND SHALL BE LOCATED SO AS TO BE CLEARLY VISIBLE TO QUALIFIED PERSONS BEFORE EXAMINATION, ADJUSTMENT, SERVICING OR MAINTENANCE OF THE EQUIPMENT. EACH DISCONNECTING MEANS SHALL BE LEGIBLY MARKED TO INDICATE ITS PURPOSE UNLESS ARRANGED AND LOCATED SUCH THAT THE PURPOSE IS EVIDENT, SERVICE EQUIPMENT SHALL BE LEGIBLY MARKED TO IDENTIFY IT AS BEING SUITABLE FOR USE AS SERVICE EQUIPMENT, SERVICE EQUIPMENT SHALL BE LEGIBLY MARKED IN THE FIELD WITH THE MAXIMUM AVAILABLE FAULT CURRENT. THE FIELD MARKINGS SHALL INCLUDE THE DATE THE FAULT CURRENT CALCULATION WAS PERFORMED AND BE OF SUFFICIENT DURABILITY TO WITHSTAND THE ENVIRONMENT INVOLVED.

 55. PROVIDE NULDN SMITCH PLATES, COLOR TO BE SELECTED BY ARCHITECT.
- 30. EACH BRANCH CIRCUIT OVERCURRENT PROTECTION DEVICE SHALL BE IDENTIFIED BY CIRCUIT NUMBER AND SCHEDULES INSIDE PANEL DOOR. EACH BRANCH CIRCUIT SPLICE OR TERMINATION SHALL BE IDENTIFIED BY PANEL AND CIRCUIT DESIGNATION SHOWN ON THE JUNCTION OR CUTLET BOX, OR UPON INDIVIDUAL WIRES IN CASES WHERE MORE THAN ONE OF EACH PHASE CONDUCTOR OCCUR. EACH CONDUCTOR TERMINATION SHALL BE IDENTIFIED BY NUMBER AT EACH DEVICE, INSIDE BOX, ON WIRE BY APPROVED MEANS.

 65. PROVIDE NYLON SWITCH PLATES. COLOR TO BE SELECTED BY ARCHITECT. BE. REFERENCE REFLECTED CEILING PLAN FOR EXACT LOCATIONS OF LIGHT FIXTURES AND FINASH COLORS ARE TO MATCH CEILING COLOR OR BE PAINTED TO MATCH. COORDINATE MELLATION IN FIELD WITH ARCHITECT. COORDINATE ALL LIGHTS ATTACHED TO ROOF STRUCTURE TO BE SUSPENDED TO PAINT LINE SHOWN ON ARCHITECTURAL ELEVATIONS.
- 31. ALL CONDUCTORS CARRYING GREATER THAN 50 VOLTS SHALL BE SOLID COPPER, MINIMUM \$12 AWG, SOFT DRAWN OF 98% CONDUCTIVITY, UNLESS NOTED OTHERWISE. CONDUCTORS OF SIZE \$8 AWG OR LARGER SHALL BE CONCENTRIC LAY STRANDED COPPER. PROVIDE MINIMUM \$14 AWG CONDUCTORS, CARRYING LESS THAN LINE VOLTAGE FOR COMMUNICATIONS, CONTROLS OR LOW VOLTAGE LIGHTING, UNLESS OTHERWISE NOTED.

 32. INSULATION: PROVIDE TYPE THINN/THINN OR TW, TYPE INSULATION COORDINATE INSULATION TYPES WITH CONDITIONS, NEC REQUIREMENTS AND CONDUCT TILL REQUIREMENTS. ALL WIRING SIZES ARE BASED ON 60C OR 75C INSULATION 32. INSULATION: PROVIDE TYPE THHN/THWN OR TW, TYPE INSULATION COORDINATE INSULATION TYPES WITH CONDITIONS, NEC REQUIREMENTS AND CONDUIT FILL REQUIREMENTS. ALL WIRING SIZES ARE BASED ON 60C OR 75C INSULATION ACCORDING TO CURRENT, REGARDLESS OF ACTUAL INSULATION USED, COMPLY WITH ALL UL "GREEN BOOK" REQUIREMENTS, REFERENCE CONDUIT NOTES BELOW.

 DOCUMENTS AND MANUFACTURER'S INSTRUCTIONS, FUNCTIONAL TESTING SHALL BE IN ACCORDANCE WITH SECTIONS C408.3.1.1 AND C408.3.1.2 FOR THE ACCORDANCE WITH SECTIONS C408.3.1.2 FOR THE ACCORDANCE W TABLES C405.7(1) THROUGH C405.7(4). EFFICIENCY VERIFIED THROUGH CERTIFICATION PROGRAM OF THE EQUIPMENT EFFICIENCY RATINGS SHALL BE PROVIDED BY MOTOR MANUFACTURER.
- 70. BUILDING SHALL HAVE SUFFICIENT RADIO COVERAGE (-950bM) FOR EMERGENCY RESPONDERS AS PER 510 OF THE IFC. CONTRACTOR SHALL DETERMINE IF SIGNAL STRENGTH WITHIN THE BUILDING IS SUFFICIENT. IF INSUFFICIENT, CONTRACTOR SHALL PROVIDE BIDIRECTIONAL AMPLIFIER SYSTEM TO BOOST SIGNAL AS REQUIRED TO ENHANCE IN BUILDING RADIO FREQUENCY SIGNAL COVERAGE FOR PUBLIC SAFETY RADIOS. 34. WIRE COLORS: CONFIRM TO CITY REQUIRED COLOR SCHEME. 35. GROUNDING: ALL CIRCUITS SHALL BE RUM WITH A MINIMUM #12 AWG INSULATED GREEN COPPER EQUIPMENT GROUND WIRE, UNLESS OTHER WIRE SIZE IS NOTED, USE OF CONDUIT AS SOLE GROUND IS UNACCEPTABLE. DO NOT BOND NEUTRAL TO GROUND EXCEPT AT SERVICE ENTRANCE EQUIPMENT AS SHOWN IN DETAILS. 71. THE MAXIMUM VOLTAGE DROP OF FEEDERS NOT TO EXCEED 2% AT DESIGN LOAD AND BRANCH CIRCUITS NOT TO EXCEED 3% AT DESIGN LOAD, CONDUCTOR SIZES INDICATED ON DRAWING SWITCH BOARD AND PANEL SCHEDULES ASSUME THE MOST EFFICIENT ROUTING OF COMDUCTORS AND IT IS THE RESPONSIBILITY OF THE CONTRACTOR TO VERIFY THE VOLTAGE DROP AND PROVIDE UPSIZED FEEDERS AND BRANCH CIRCUITS AS REQUIRED WHEN THE ACTUAL LENGTH AND ROUTING OF THE CIRCUIT IS DETERMINED, THE DESIGN LOAD IS INDICATED ON THE DRAWINGS FOR THEIR USE IN DETERMINING FIELD CONDITION VOLTAGE DROP. 36. ALL WRING SHALL BE IN METAL CONDUIT. MINIMUM % EAT CONDUIT IS ACCEPTABLE MOORS FOR SIZES UP TO 3" IN DIAMETER. MINIMUM % EAT CONDUIT IS SUBJECTED AND BRANCH CIRCUITS NOT TO EXCEED 3% AT DESIGN LOAD AND BRANCH CIRCUITS NOT TO EXCEED 3% AT DESIGN LOAD. CONDUITOR SIZES STATED FIXTURE WHIPS ONLY. MC CABLE SHALL BE RUN IN NEAT MANNER & STRAPPED AT REGULAR INTERVALS TO AVOID THE RATS NEST AFFECT. ENT, ALUMINUM CONDUIT, HM ("ROMEY"), MMC AND NSMM ARE NOT ACCEPTABLE. ALL CONDUIT AT EXTERIOR OF BUILDING SHALL COMPLY WITH NEC 358.10 (C) FOR CORROSSION PROTECTION AND SHALL BE SUITABLE FOR INSTALLATION IN WELL LOCATION PER NEC 300.9. CONDUITS OR RACEWAYS THROUGH WHICH MOSTURE MAY CONTACT LIVE PARTS SHALL BE SEALED OR PLIEGED AT EITHER OR BOTH ENDS.

 71. THE MAXIMUM VOLTAGE DROP OF FEEDERS NOT TO EXCEED 2% AT DESIGN LOAD AND BRANCH CIRCUITS NOT TO EXCEED 3% AT DESIGN LOAD. CONDUCTOR SIZES NIDICATED ON DRAWING SWITCH BOARD AND PANEL SCHEDLES ASSIDILITY OF THE CONTRACTOR TO VERIFY THE VOLTAGE DROP AND PROVIDE UPSIZED FEEDERS AND BRANCH CIRCUITS AS REQUIRED WHEN THE ACTUAL LENGTH AND ROUTING OF THE CIRCUIT IS DETERMINED. THE DESIGN LOAD IS INDICATED ON THE DRAWINGS FOR THEIR USE IN DETERMINING FIELD CONDITION VOLTAGE DROP.

 72. PROVIDE COMPATIBLE FRESTOP SYSTEM FOR ALL ELECTRICAL PENETRATIONS THROUGH CONCRETE SLABS, CONCRETE OR MASONRY WALLS, FIRE RATED FLOOR OR WALL ASSEMBLIES AS TO MAINTAIN THE RATING OF THE ASSEMBLY.

TECHNOLOGY DEMOLITION NOTES

37. USE ONLY FITTINGS APPROPRIATE FOR TYPES OF CONNECTIONS TO BE MADE ALL FITTINGS SHALL BE COMPRESSION, SET SCREW OR THREADED TYPE. FITTINGS FOR PVC, WHEN ALLOWED, SHALL BE APPROVED FOR USE WITH PVC AND WATERTIGHT. ALL FITTINGS MADE BELOW GRADE SHALL BE WATERTIGHT. FOR ENCLOSURES INSTALLED IN WET LOCATIONS, ALL RACEWAYS ENTERING ABOVE THE LEVEL OF UNINSULATED LIVE PARTS SHALL USE FITTINGS LISTED FOR WET LOCATIONS.

- B. REFER TO THE RESPONSIBILITY MATRIX IN TDG TO DETERMINE THE ENTITY RESPONSIBLE FOR REMOVING AND HANDLING ALL TECHNOLOGY DEVICES AND WIRING, CONTRACTOR SHALL NOT REMOVE OR HANDLE ANY DEVICES SPECIFICALLY DELINEATED TO IT DEPARTMENT EMPLOYEES AND VENDORS, CONTRACTOR SHALL COORDINATE REMOVAL OF DEMOLISHED ITEMS WITH RESPONSIBLE ENTITY.
- C. REFER TO ARCHITECTURAL PLANS FOR SPECIFIC AREAS OF DEMOLITION. PROVIDE FOR ANY AND ALL DEMOLITION WORK NECESSARY TO ACCOMMODATE NEW CONSTRUCTION, INCLUDING ARCHITECTURAL, MECHANICAL, PLIMBING AND ELECTRICAL WORK. TECHNOLOGY DEVICES AND ASSOCIATED WIRING LOCATED WITHIN THE DEMOLITION AREA THAT WILL NO LONGER BE USED SHALL BE REMOVED AND PROPERLY DISPOSED OF BY RESPONSIBLE ENTITY, PER RESPONSIBILITY MATRIX. IF DEMOLITION OF AN EXISTING AREA TO REMAIN IS REQUIRED FOR NEW INSTALLATION WORK, THE CONTRACTOR SHALL RESTORE THE AFFECTED AREA IN REGARDS TO PATCHING AND PAINTING SURFACES. THE ENTITY RESPONSIBLE FOR THAT TECHNOLOGY DEVICE SHALL REPLACE DAMAGED ITEMS WITH MATCHING NEW ITEMS.
- D. THE ELECTRICAL CONTRACTOR SHALL BE RESPONSIBLE FOR DEENERGIZING CIRCUITS IN DEMOLITION AREAS TO INSURE A SAFE CONDITION.
- E. ALL EXISTING TECHNOLOGY RACEWAYS OR CABLES THAT ARE TO REMAIN IN AREAS WHERE CELLINGS ARE DEMOLISHED SHALL BE SUPPORTED BY THIS CONTRACTOR. BUNDLE LOW VOLTAGE SIGNAL CABLES TOGETHER USING TIE-WRAPS AND SUPPORT ABOVE CEILING WITH VOLTAGE SIGNAL CABLES TOGETHER USING TIE—WRAPS AND SUPPORT ABOVE CELLING WITH
 "U BRACKETS OR "J" HOOKS ON A MINIMUM OF 4' TO 6' INTERVALS. THER ALARM
 "CABLES SHALL NOT BE BUNDLED WITH OTHER CABLES AND SHALL BE SUPPORTED
 SEPARATELY FROM DATA, SECURITY, AND COMMUNICATIONS CABLING. THE CONTRACTOR
 SHALL FIELD DETERMINE THE BEST METHOD TO ACCOMMODATE OBSTRUCTIONS PRIOR TO
 SUPPORT INSTALLATION. CONTRACTOR SHALL ASSUME ALL LOW VOLTAGE SIGNAL CABLES
 ARE ACTIVE TO REMAIN, UNLESS NOTED OTHERWISE. REPAIR OF REMAINING CABLES
 DAMAGED DURING WORK SHALL BE THE COORDINATED WITH THE RESPONSIBILITY PARTY
 PER RESPONSIBILITY MATRIX.
- UNLESS NOTED OTHERWISE, IN AREAS WHERE EXISTING DEVICES OR NOTES ARE NOT SHOWN, IT IS INTENDED THAT THE EXISTING DEVICES AND CONTROLS SHALL REMAIN. REMOVE, STORE, PROTECT & REINSTALL AS REQUIRED FOR DEMOLITION.

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FOR COORDINATION

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PERMITTING. DATE: 8/16/2024

CONSULTANT:

THIS DOCUMENT IS ISSUED

UNDER THE AUTHORITY OF

CHRISTOPHER W. SIMS, P.E #94747. IT SHALL NOT BE **ÜSED FOR CONSTRUCTION OR**

KEY PLAN	
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JMA Project Number: Date: 08/09/2024

Scale: Sheet Title

ELECTRICAL DETAILS & SCHEDULES

Sheet Number

E001



F. UNLESS NOTED OTHERWISE, IN AREAS WHERE EXISTING LIGHTS OR NOTES ARE NOT SHOWN, IT IS INTENDED THAT THE EXISTING FOXTURES, CIRCUITRY, DEVICES AND CONTROLS REMAIN.

A. A FACTORY-AUTHORIZED AND LICENSED INSTALLER SHALL PERFORM THE WORK OF THIS SECTION. THE INSTALLER SHALL BE BONDED. SUBMIT COPIES OF CURRENT LICENSE CERTIFICATES AND FACTORY TRAINING CERTIFICATES FOR ALL STAFF MEMBERS DOING THE INSTALLATION AND MAINTENANCE WOOK.

B. IT IS THE SOLE RESPONSIBILITY OF THE STATE LICENSED FIRE ALARM CONTRACTOR TO PROVIDE FIRE ALARM SYSTEM DESIGN, ENGINEERING, DESIGN APPROVAL, CODE COMPLIANCE, INSTALLATION, AND FINAL

C. THE FINAL FIRE ALARM PLANS TO BE SUBMITTED FOR AHJ APPROVAL SHALL BE PRODUCED AND APPROVED BY A NICET LEVEL III CERTIFIED FIRE ALARM SYSTEM

D. THE CONTRACTOR SHALL PROVIDE AND INSTALL A COMPLETE FIRE ALARM SYSTEM TO INCLUDE SMOKE DETECTION & ALARM SUPERVISION TO MEET NFPA AND ALL LOCAL CODES. PROVIDE A COMPLETE AND OPERATIONAL SYSTEM THAT IS ULLISTED AND OF ONE MANUFACTURER. PROVIDE AN

CIRCUITS AND AUTOMATIC DIALER TO CONTACT THE SECURITY COMPANY. PROVIDE CONNECTIONS TO ALL FIRE PROTECTION TAMPER & FLOW

SWITCHES, DOUBLE ACTION PULL STATIONS, PHOTOELECTRIC TYPE SMOKE DETECTORS, DUCT DETECTORS, FIRE ALARM PANELS, AND SECURITY PANELS.

E. ALL FIRE ALARM RELATED DEVICES AND NOTES ON THESE DRAWINGS ARE SHOWN TO INDICATE INTENT OF SYSTEM DESIGN. ANY DEVICES OR SYSTEM ACCESSORIES REQUIRED TO MEET APPLICABLE CODES AND ORDINANCES THAT ARE NOT SHOWN ON THESE DRAWINGS SHALL BE CONSIDERED

F. CONTRACTOR SHALL PROVIDE SUBMITTAL DATA INCLUDING EQUIPMENT

SPECIFICATION SHEETS, INSTALLATION INSTRUCTIONS, AND SHOP DRAWINGS WHICH INCLUDE BATTERY CALCULATIONS. CONTRACT REQUIRED SUBMITTALS SHALL ONLY BE SUBMITTED FOR ENGINEERING REVIEW AFTER THE CONTRACTOR HAS RECEIVED WRITTEN APPROVAL FROM THE AHJ.

FOR A PERIOD OF ONE YEAR AFTER DATE OF FINAL ACCEPTANCE OF THE INSTALLATION. THE ELECTRICAL CONTRACTOR SHALL PROMPTLY REPLACE, DURING THE PERIOD OF GUARANTEE, ANY PARTS OR WORKMANSHIP FOUND TO BE DEFECTIVE IN THEIR OPERATION, WITHOUT ADDITIONAL COST TO THE

OWNER. PROVIDE TWELVE MONTHS OF MONITORING SERVICE REQUIRED AS

G. THE CONTRACTOR SHALL GUARANTEE ALL MATERIALS AND WORKMANSHIP

H. THE FIRE ALARM SYSTEM SHALL BE SERVICEABLE BY ANY FACTORY AUTHORIZED DEALER. SERVICE SHALL NOT BE LIMITED TO SERVICE BY

PROVIDE ALL RELAYS AND COMPONENTS AS REQUIRED FOR SHUT DOWN OF HVAC UNITS AND SOUND SYSTEMS AS REQUIRED PER FIRE AND MECHANICAL CODE. PROVIDE A DEDICATED TELEPHONE LINE. PROVIDE SMOKE DETECTORS ND CARBON MONOXIDE DETECTORS IN SLEEPING AREAS WITH LOCAL

GENERAL FIRE ALARM & DEFERRED APPROVAL SYSTEM NOTES

DESIGNER, LICENSED BY THE STATE FIRE MARSHAL.

ANNUNCIATION AND AS REQUIRED BY CODE.

PART OF THE INSTALL.

ONLY MANUFACTURER'S PERSONNEL.

HEAT DETECTOR

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FIREMAN'S PHONE JACK. STUB 3/4"C ABOVE ACCESSIBLE CEILING FROM OUTLET BOX

			JTING FIVELIDE COUEDING
EIVTLIDE		VALLAS ISV - LIGI	HTING FIXTURE SCHEDULE
FIXTURE			
<u>ID</u>	LAMPS		DESCRIPTION
		2 X 2 RECESSED GRID LAYIN	
	I 28W LED	DRIVER(S): VOLTAGE:	1 - 0-10v DIMMING DRIVER, <10% THD, CORRIDOR LTS W/STEP DIM 120/277
A1	I 4000K	INSTALLATION:	RECESSED LAY-IN GRID
	1 3300 LUMENS	DESIGN BASIS:	LITHONIA 2GTL - 2 - 33L - A12125 - GZ10 - LP840
			COLUMBIA, DAYBRITE, METALUX
		2 X 4 RECESSED GRID LAYIN	•
	36W LED	DRIVER(S):	1 - 0-10v DIMMING DRIVER, <10% THD, CORRIDOR LTS W/STEP DIM
A2	4000K	VOLTAGE:	120/277
AZ	4800 LUMENS	INSTALLATION:	RECESSED LAY-IN GRID
	4800 LOWILING	DESIGN BASIS:	LITHONIA 2GTL - 4 - 48L - A12125 - GZ10 - LP840
		OTHER MANUFACTURERS:	COLUMBIA, DAYBRITE, METALUX
		4' LINEAR VANDAL RESISTA	
	33W(1FI)	DRIVER(S):	1 - 0-10v DIMMING DRIVER, <10% THD
В	4000K	VOLTAGE:	120/277
	1000 LUMENS	INSTALLATION:	RECESSED CEILING
		DESIGN BASIS:	LITHONIA# VAP -4000LM-FST-WD-MVOLT-GZ20-40K-80CRI
			COLUMBIA, DAYBRITE, METALUX
		·	DAMP LOCATION DOWNLIGHT "DE" WITH EMERGENCY BATTERY
	1 59W LED	DRIVER(S):	1 - 0-10v DIMMING DRIVER, <10% THD
D/DE	I 4000K	VOLTAGE: INSTALLATION:	RECESSED CEILING
	5000 LUMENS	DESIGN BASIS:	LITHONIA# LDN8SQ-50LM-40K-LS8-AR-LSS-MVOLT-E10WCP
			COLUMBIA, DAYBRITE, METALUX
			EGRESS LIGHTING FIXTURE, NI-CAD BATTERY FOR 90 MINUTES OF
EM	LED		PON LOSS OF FORMAL POWER, WHITE THERMOPLASTIC HOUSING. U.L.
2111	(INCLUDED)		LOCATIONS, SELF-DIAGNOSTICS INCLUDED
		DRIVER(S):	N/A
		VOLTAGE:	120/277
		INSTALLATION:	SURFACE WALL
		DESIGN BASIS:	LITHONIA #EU2C-SD
		OTHER MANUFACTURERS:	DUAL-LITE, MCPHILBEN, SURE-LITES
X	LED (INCLUDED)	UPON LOSS OF FORMAL PC	EXIT SIGN, NI-CAD BATTERY FOR 90 MINUTES OF EMERGENCY OPERATION OWER, RED LETTERING, WHITE THERMOPLASTIC HOUSING. U.L. LISTED FOR S, SELF-DIAGNOSTICS INCLUDED, FACES & ARROWS PER DRAWINGS
		DRIVER(S):	N/A
		VOLTAGE:	120/277
		INSTALLATION:	SURFACE WALL/CEILING
		DESIGN BASIS:	LITHONIA #LQM-W-1-R-EL N-SD
		OTHER MANUFACTURERS:	DUAL-LITE, MCPHILBEN, SURE-LITES
		FORWARD THROW DISTRIB	UTION ON EXISTING POLE S1=SINGLE HEAD, S2A=TWO @90, S2B 2@180
	179 WATT LED	DRIVER(S):	1 - 0-10v DIMMING DRIVER, <10% THD
	4000K	VOLTAGE:	120/277
S1/S2A/S2B	23368	INSTALLATION:	POLE LIGHT
	LUMENS		LITHONIA# DSX2 LED P2 40K 80CRI TFTM MVOLT DDBXD UNIVERSAL
		DESIGN BASIS:	BRACKET FOR EXISTING POLE
		OTHER MANUFACTURERS:	, , ,
	170 \\\\ TT \ CD	FORWARD THROW DISTRIB	
	179 WATT LED 4000K	VOLTAGE:	1 - 0-10v DIMMING DRIVER, <10% THD 120/277
S3		INSTALLATION:	POLE LIGHT
		DESIGN BASIS:	LITHONIA# DSX2 LED P2 40K 80CRI TFTM MVOLT DDBXD
	LOIVILIAO	OTHER MANUFACTURERS:	
			LL PACK VIA TIMECLOCK & PHOTOCELL CONTROL WPE=EM BATTERY
		DRIVER(S):	1 - 0-10v DIMMING DRIVER, <10% THD
	25W LED	VOLTAGE:	120/277
WP/WPE	4000K	INSTALLATION:	SURFACE WALL
	3000 LUMENS	DESIGN BASIS:	LITHONIA WST LED P2 40K VF MVOLT (E7WC) DBXD
			COLUMBIA, DAYBRITE, METALUX
	1		, , , , , , , , , , , , , , , , , , ,

LABEL	MANUFACTURER	MODEL NO.	TYPE	VOLTAGE
	ILC	ILC-SWX-123-WH		120V
$\overline{\Upsilon}$	nLight	nWSXA-PDT-LV	Dual-Tech Wall Switch, 3-Way Capable, Manual On	24V
	Echoflex	US-DOC-SM1-5		120V
	ILC	ILC-SWX-123-WH	│ │ Dual Tech Wall Switch w/ Wire Guard, Manual On ├─	120V
Tw _G	nLight	nWSXA-PDT-LV	Wire Guard Provided Separately by Contractor	24V
	Echoflex	US-DOC-SM1-5		120V
_	ILC	ILC-SWX-123-D-WH		120V
₽	nLight	nWSXA-PDT-LV-DX	Dual-Tech Wall Switch w/ Dimming, Manual On	24V
т	Echoflex	US-DOCSMDIM-5	1	120V
_	ILC	ILC-SWX-221-1		24V
lacktriangle	nLight	nCM-PDT-9	Duak- Tech Ceiling Mounted Sensor Small Motion, Ex. Offices	24V
	Echoflex	E-DOC-C-SR	Sitiali Motion, Ex. Offices	24V
	ILC	ILC-SWX-222-1		24V
C LM	nLight	nCM-PDT-10	Dual- Tech Ceiling Mounted	24V
	Echoflex	E-DOC-C-LR	Large Motion, Ex. Warehouse	24V
	ILC	ILC-SWX-402-1 (Wall Mount)		24V
ի 👇	Sensor Switch	CM-PDT-11 (Ceiling Mount)	Dual- Tech Ceiling Mounted	24V
工	Echoflex	E0DVAC-W-NR (Wall Mount)	Hallway	24V
	ILC	ILC-SWX-223-1	Dual Tech, Ceiling Mounted, High Bay, 360°. High	24V
HB	nLight	nCM PDT-6	Bay Sensors shall be provided in all High Bay	24V
-110	Echoflex	E-DOC-C-HC	applications. Sensors may or may not have "HB"	24V
	ILC		designation.	120V
₽	1	ILC-SWX-122-WH	Dual- Tech Wall Switch	
Т.	Sensor Switch	WSX-PDT-2PFAN-WH	w/60min Fan Control	120V
	Echoflex	US-DOC-SM2-5		120V
_	ILC	ILC-SWX-233-D	Dual-Tech Ceiling Mounted, High Bay, 360° w/	24V
HBP	nLight	nCM PDT-6-ADCX	Photocell	24V
	Echoflex	E-DOC-C-HC w/ ELSC Sensor		24V
_	ILC	ILC-SWX-421-1		24V
√ c	nLight	nWV PDT 16 KIT	Dual Technology Corner Mount	24V
	Echoflex	E-DOC-W-WD		24V
\$	ILC	ILC-SWX-801-WH	Overside Onitals for Occurrence Octobr	24V
D	nLight	nPODMA	Override Switch for Occupancy Sensor On/Off Only	24V
	Echoflex	E1001		24V
	ILC	ILC-SWX-803-WH		24V
D	nLight	nPODMA -xx-DX	Override Switch for Occupancy Sensor w/ Dimming Control	24V
	Echoflex	E1004 (On/Off/Raise/Lower)		24V
KP	ILC	ILC LSG3 Series	Multi- Scene Controller, Refer to Lighitng Plans for	24V
131	nLight	nPODM Series	Control Schematic and Button Requirements	24V
	Ech of lex ILC	E1000 & 1100 Control Station		24V Multi
PP	nLight	nPP16D	Power Pack, Universal Voltage	Multi
_	Echoflex	ERMC4-G2		Multi
$\overline{}$	ILC	PS-IND		24V
©	Sensor Switch	NCM ACDX	Daylight Sensor	24V
	Echoflex	ELSC		24V
\$ _T	ILC	ILC-SWX-843-12H-WH		120V
•	Sensor Switch	PTSA 720	Timer Switch, 12hr Pushbutton	1001/
NOTES:	Echoflex	TS-300		120V
1.	Provide all nower n	acks relays and devices necessar	y for a complete functioning system.	
1. 2.		acks, relays, and devices necessal I sensors shall be over 5'-0" away f		

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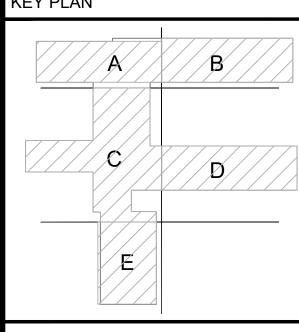
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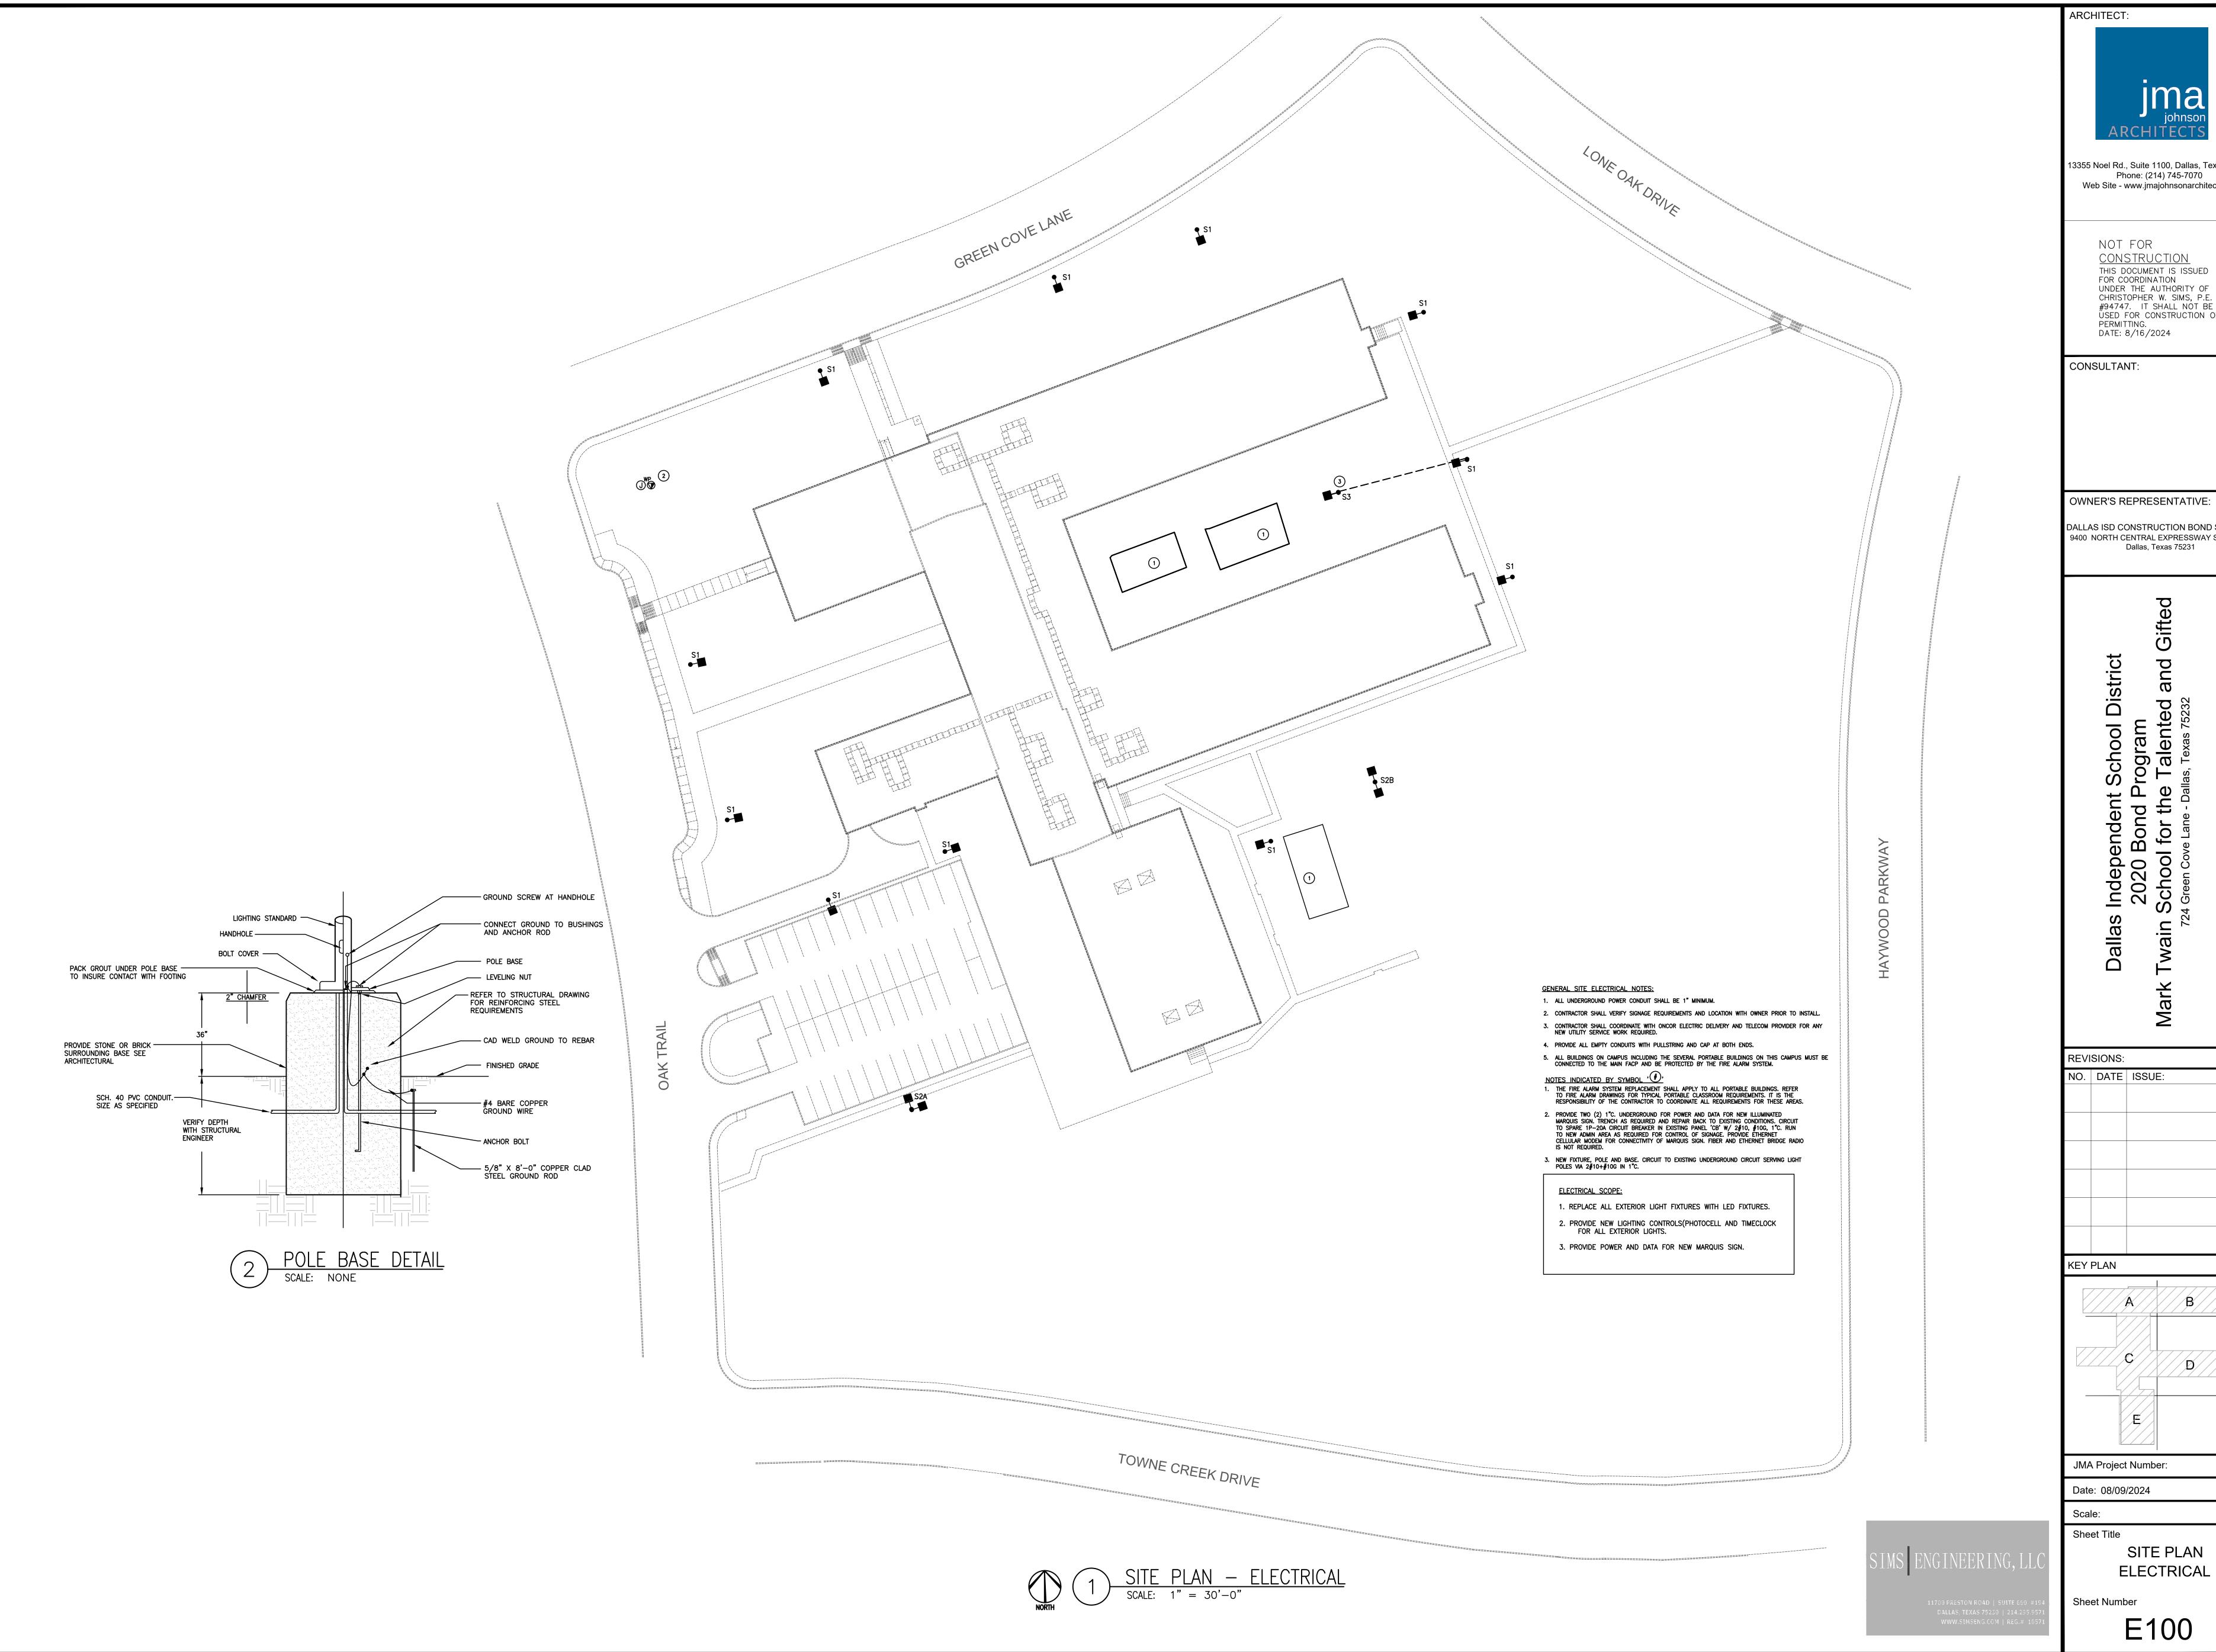
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Sheet Title

ELECTRICAL DETAILS & SCHEDULES

heet Number






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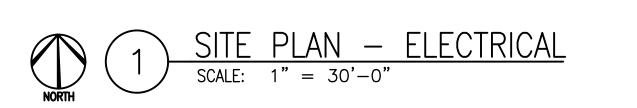
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Calculation Summary

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E101

CALCULATIONS

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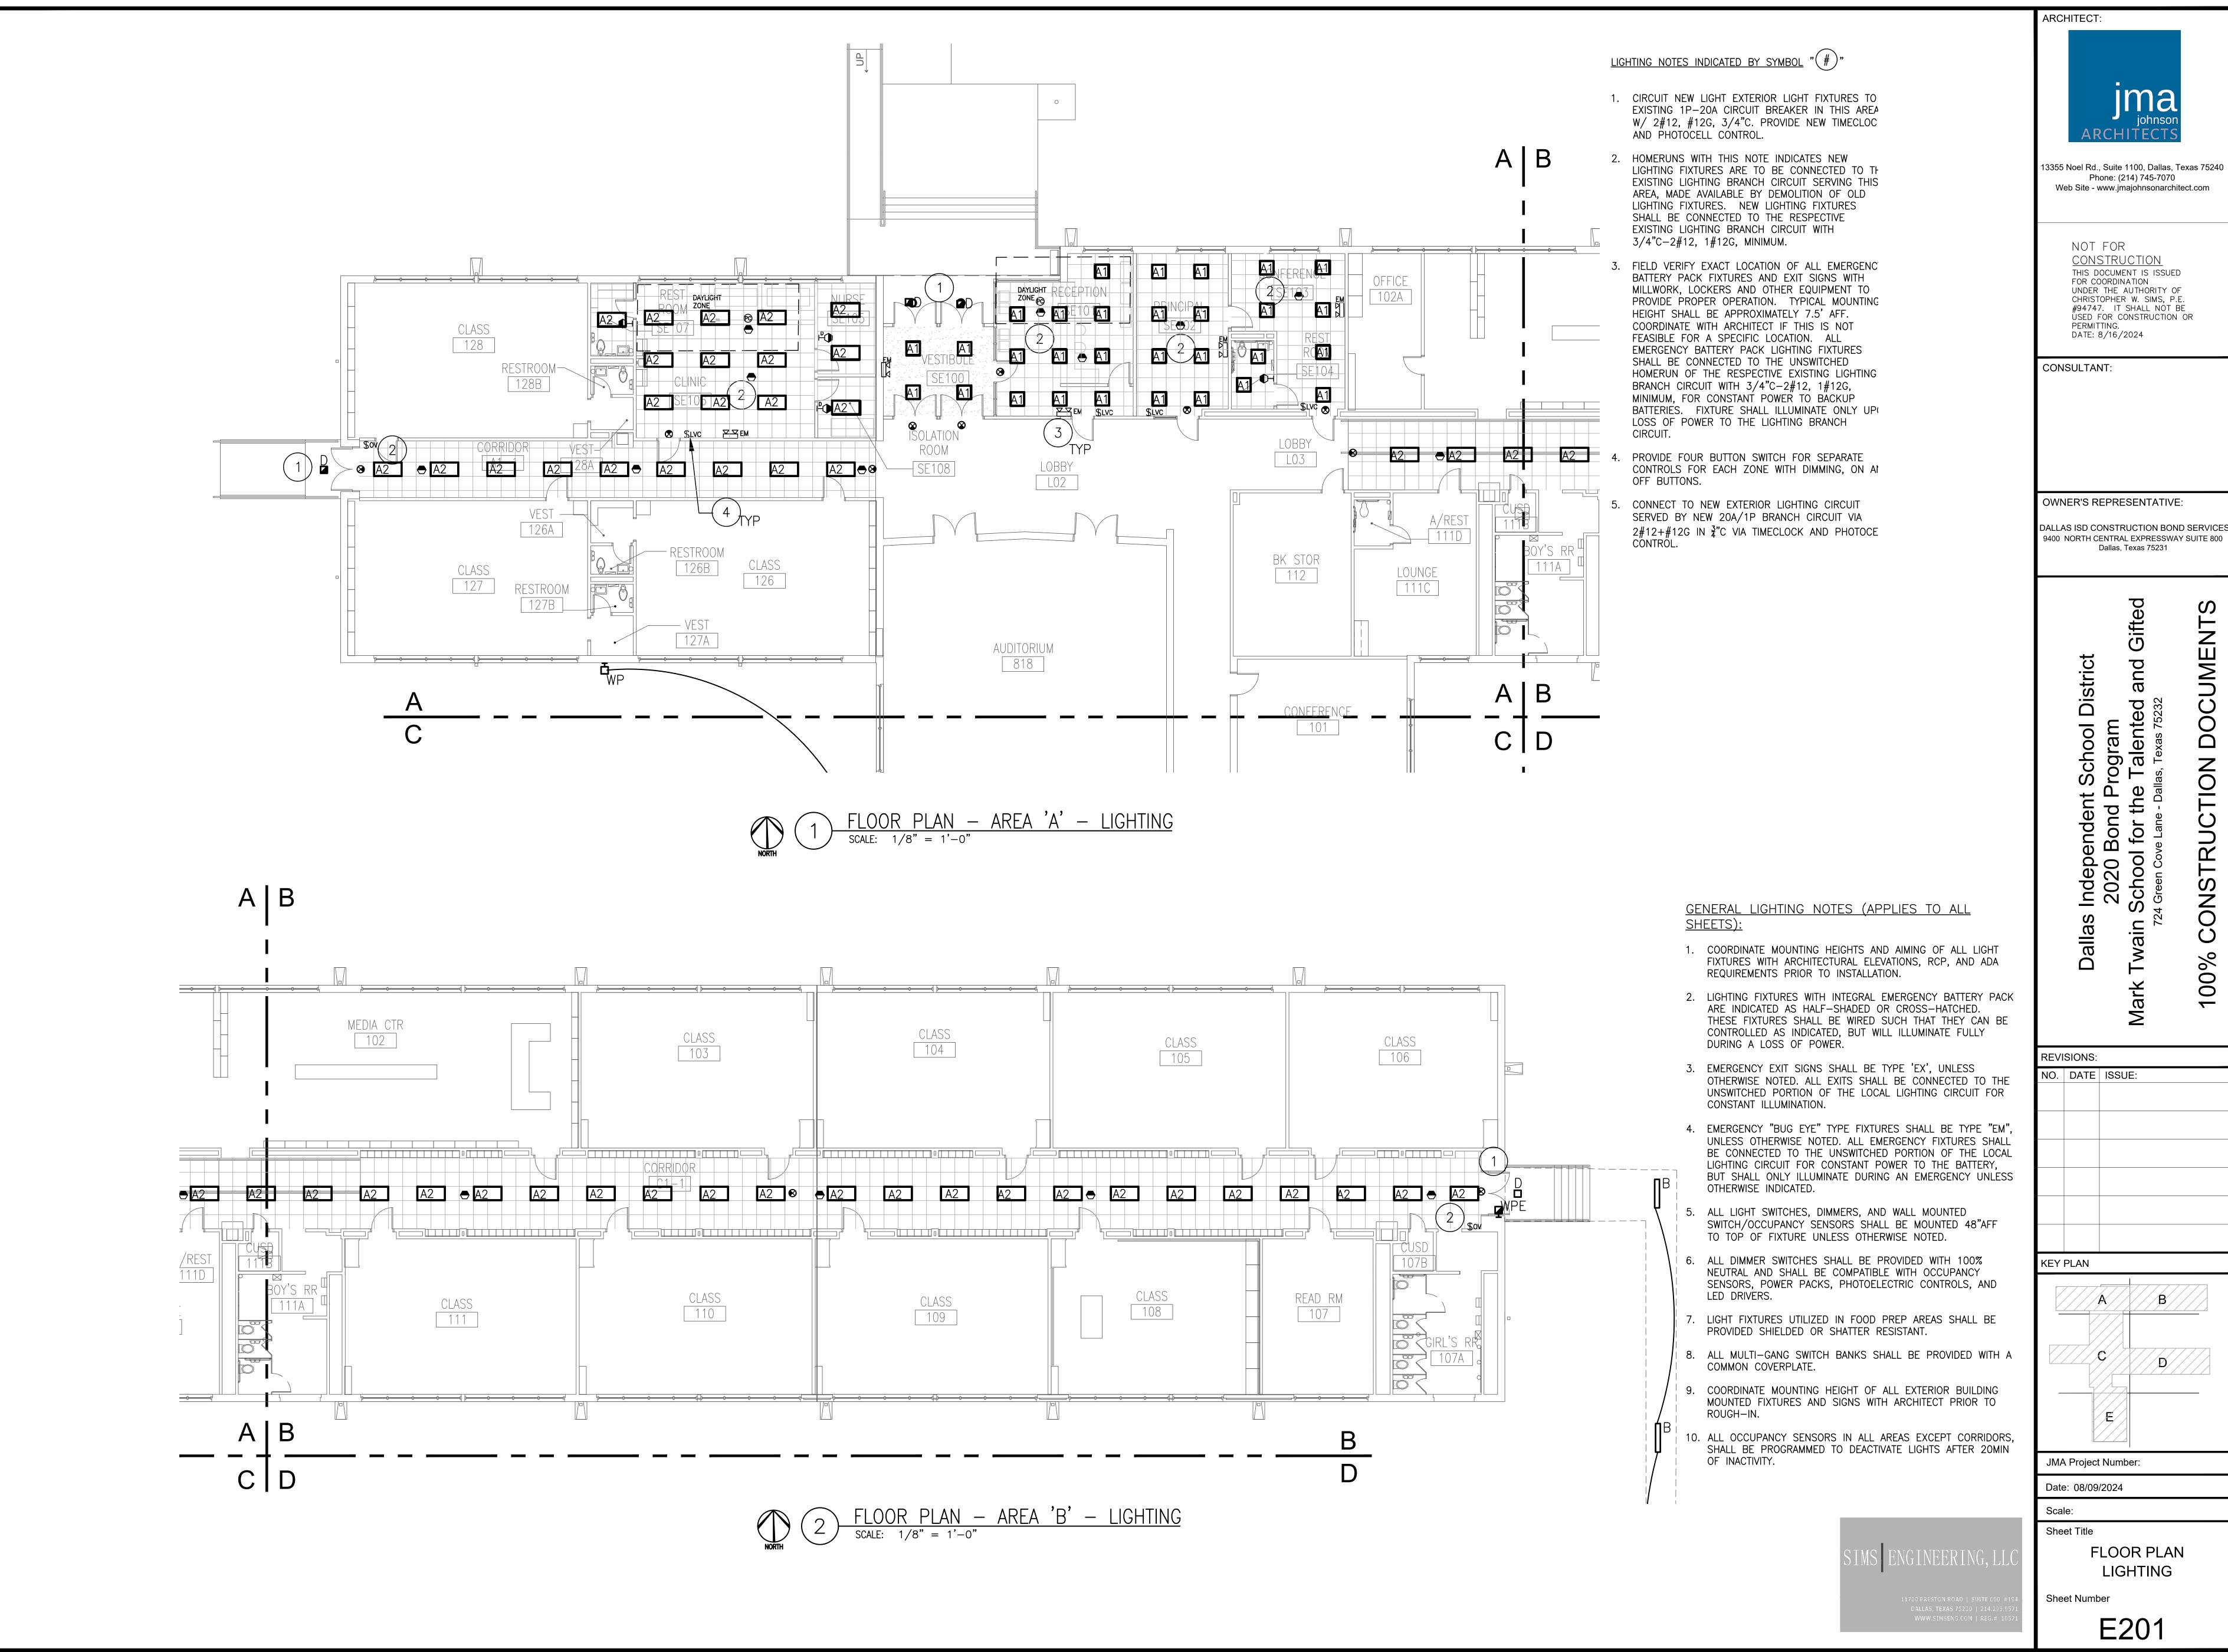
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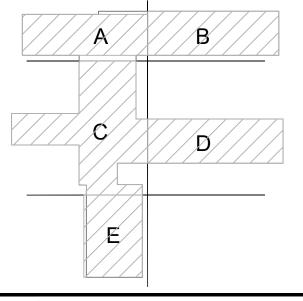
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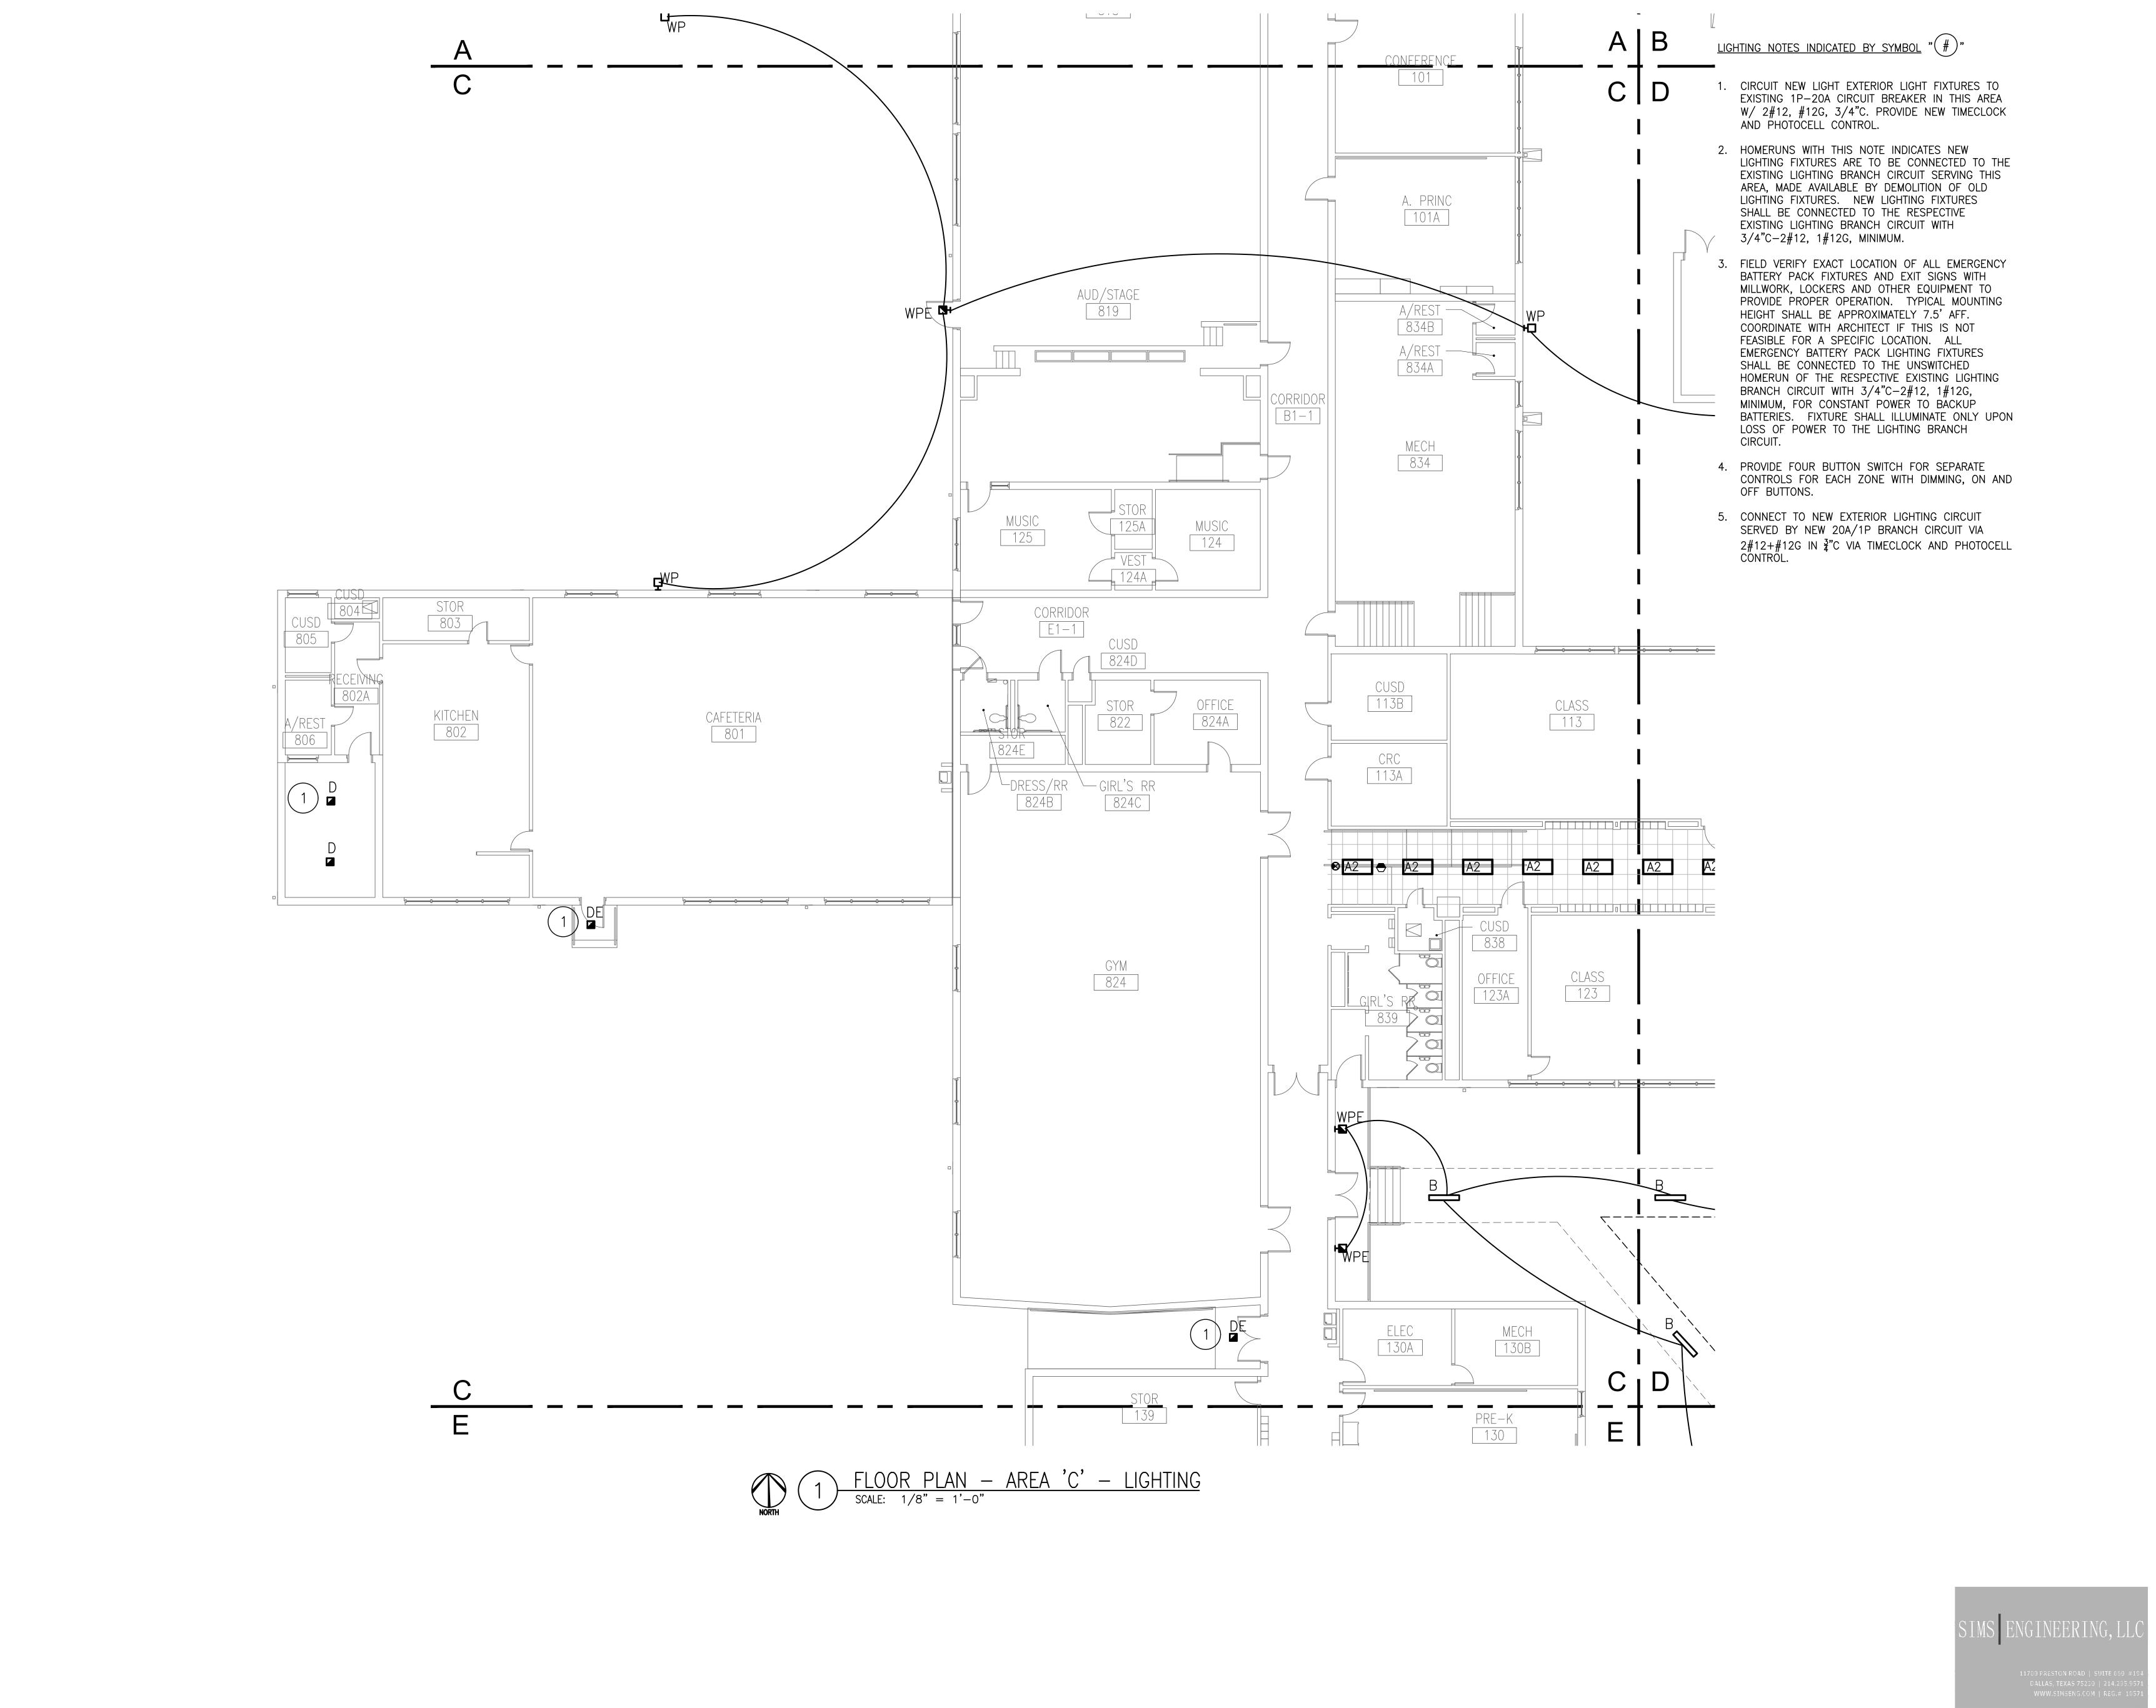
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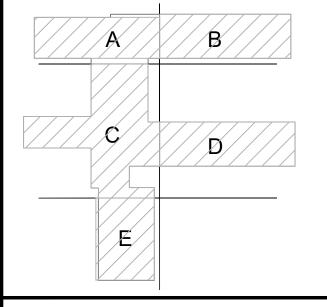
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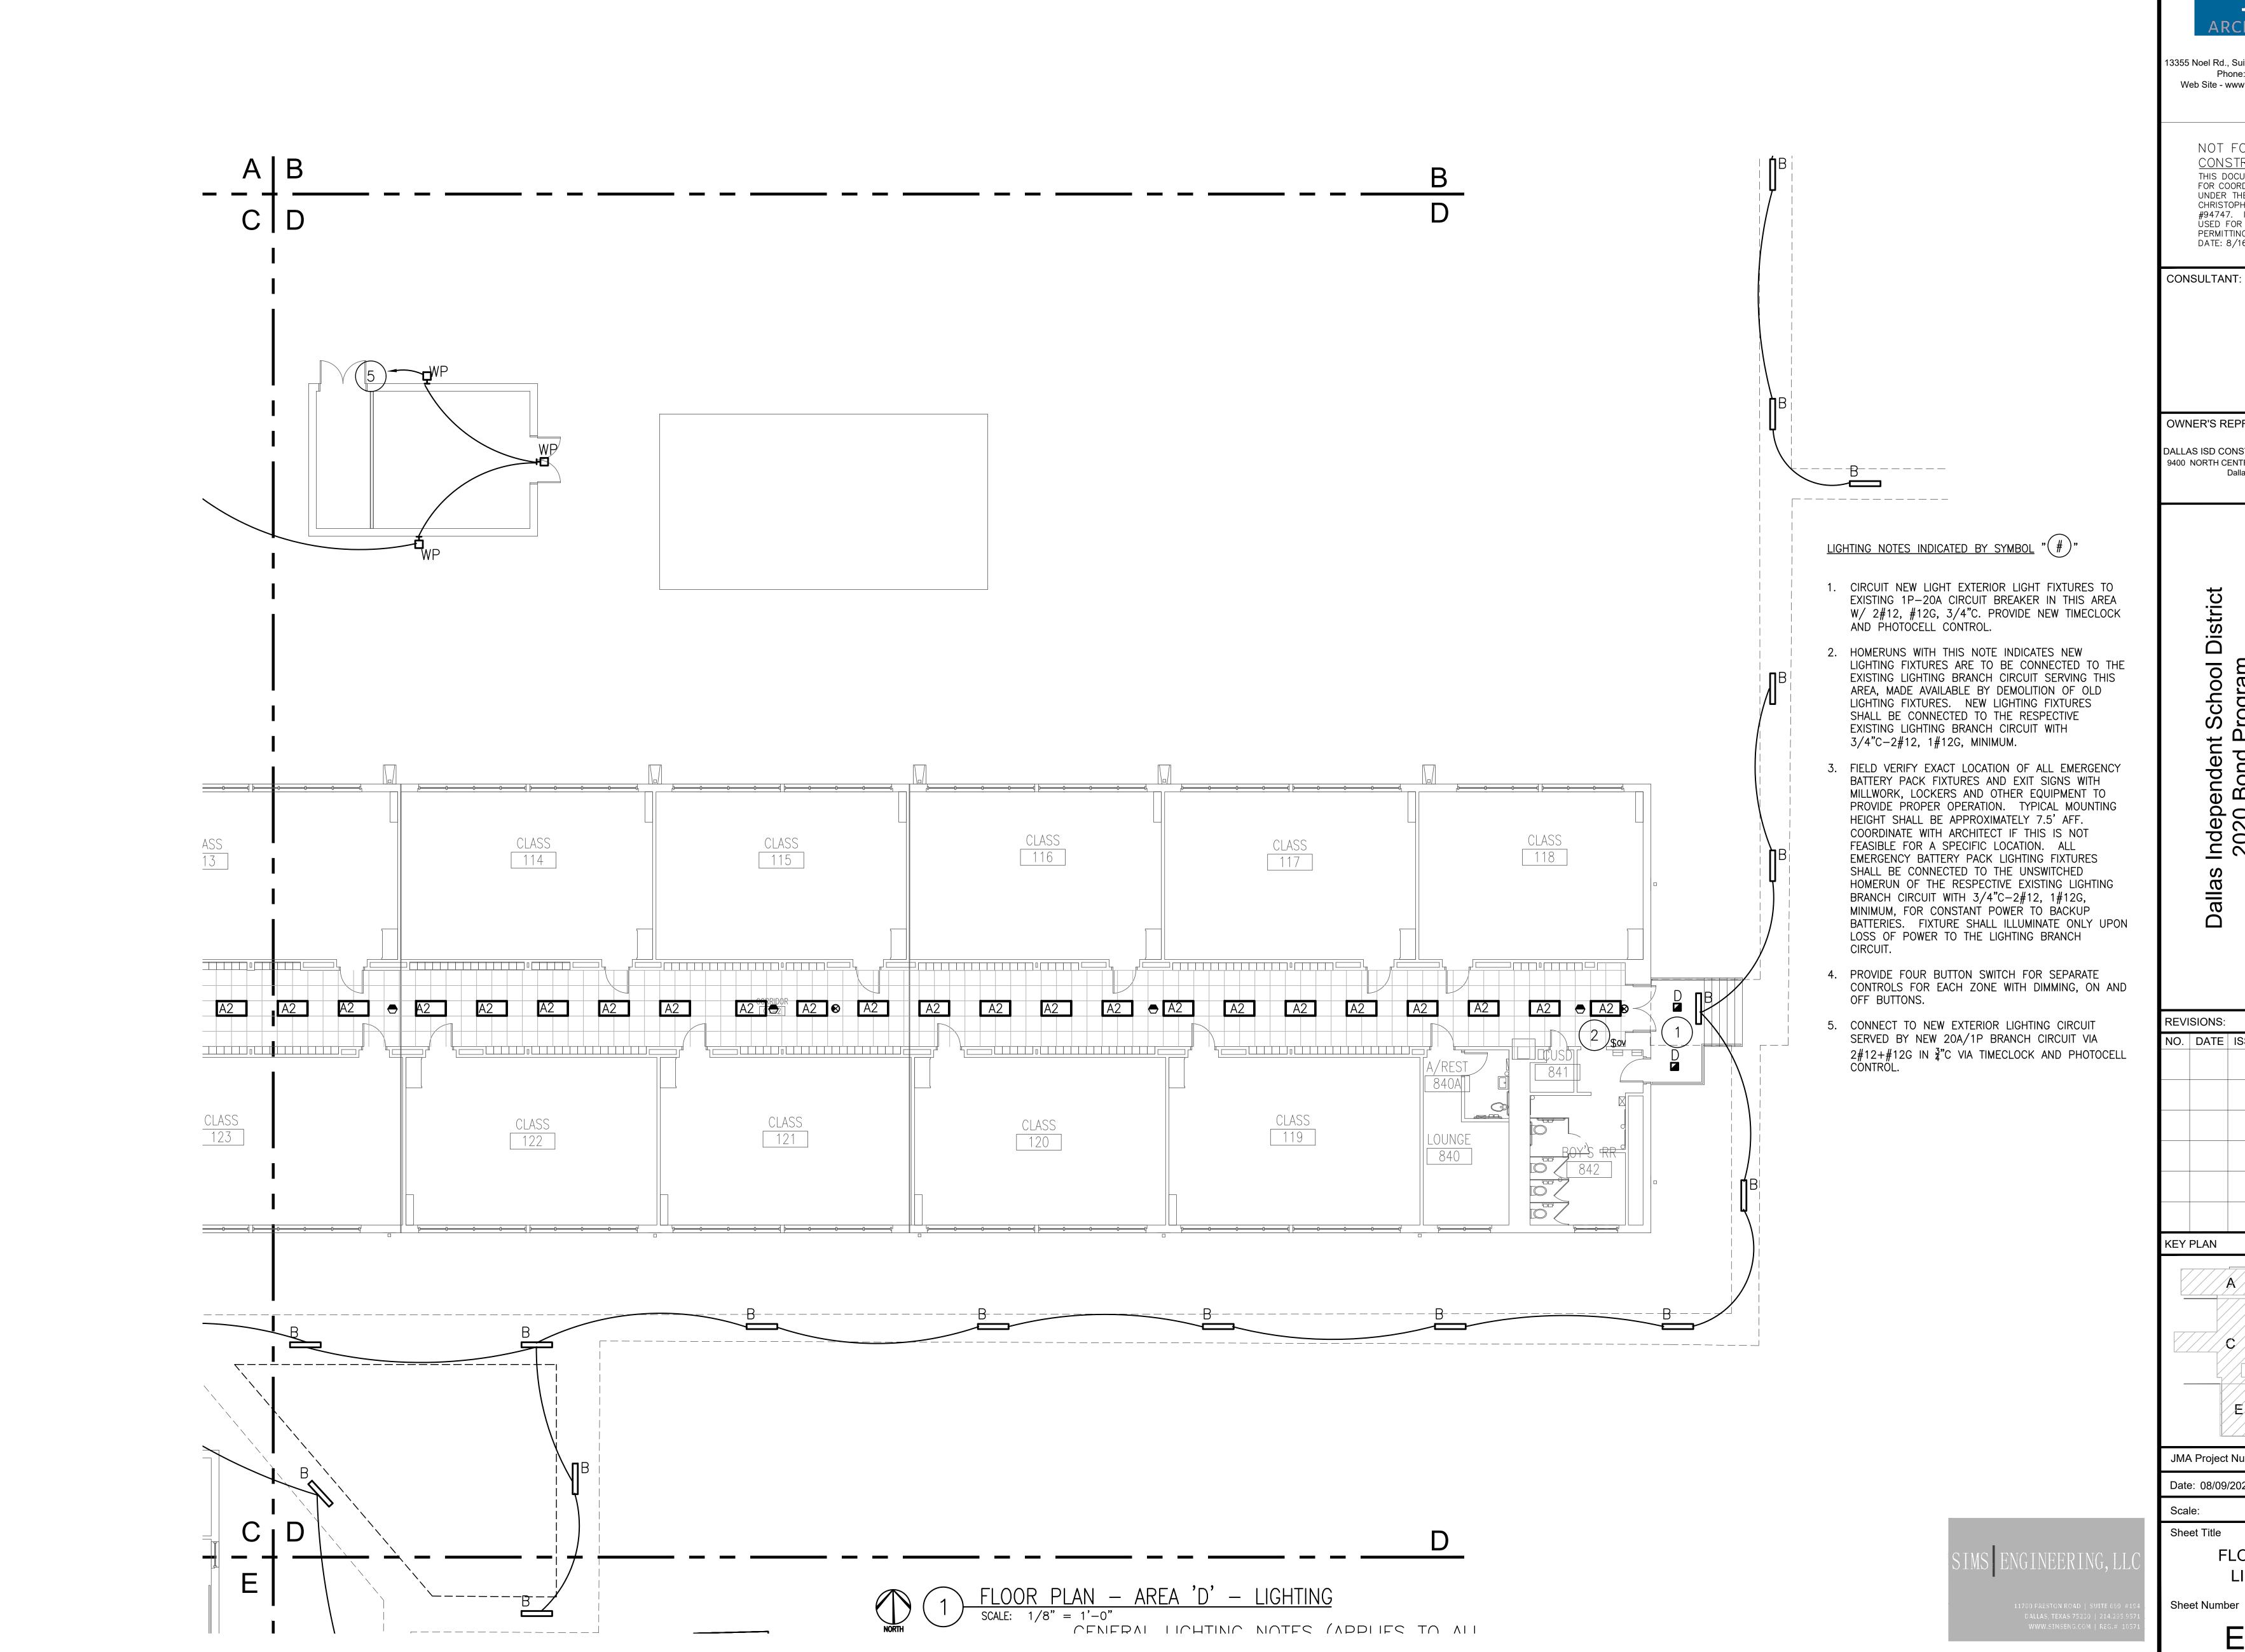
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FLOOR PLAN LIGHTING

Sheet Number

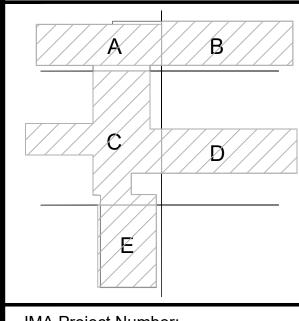

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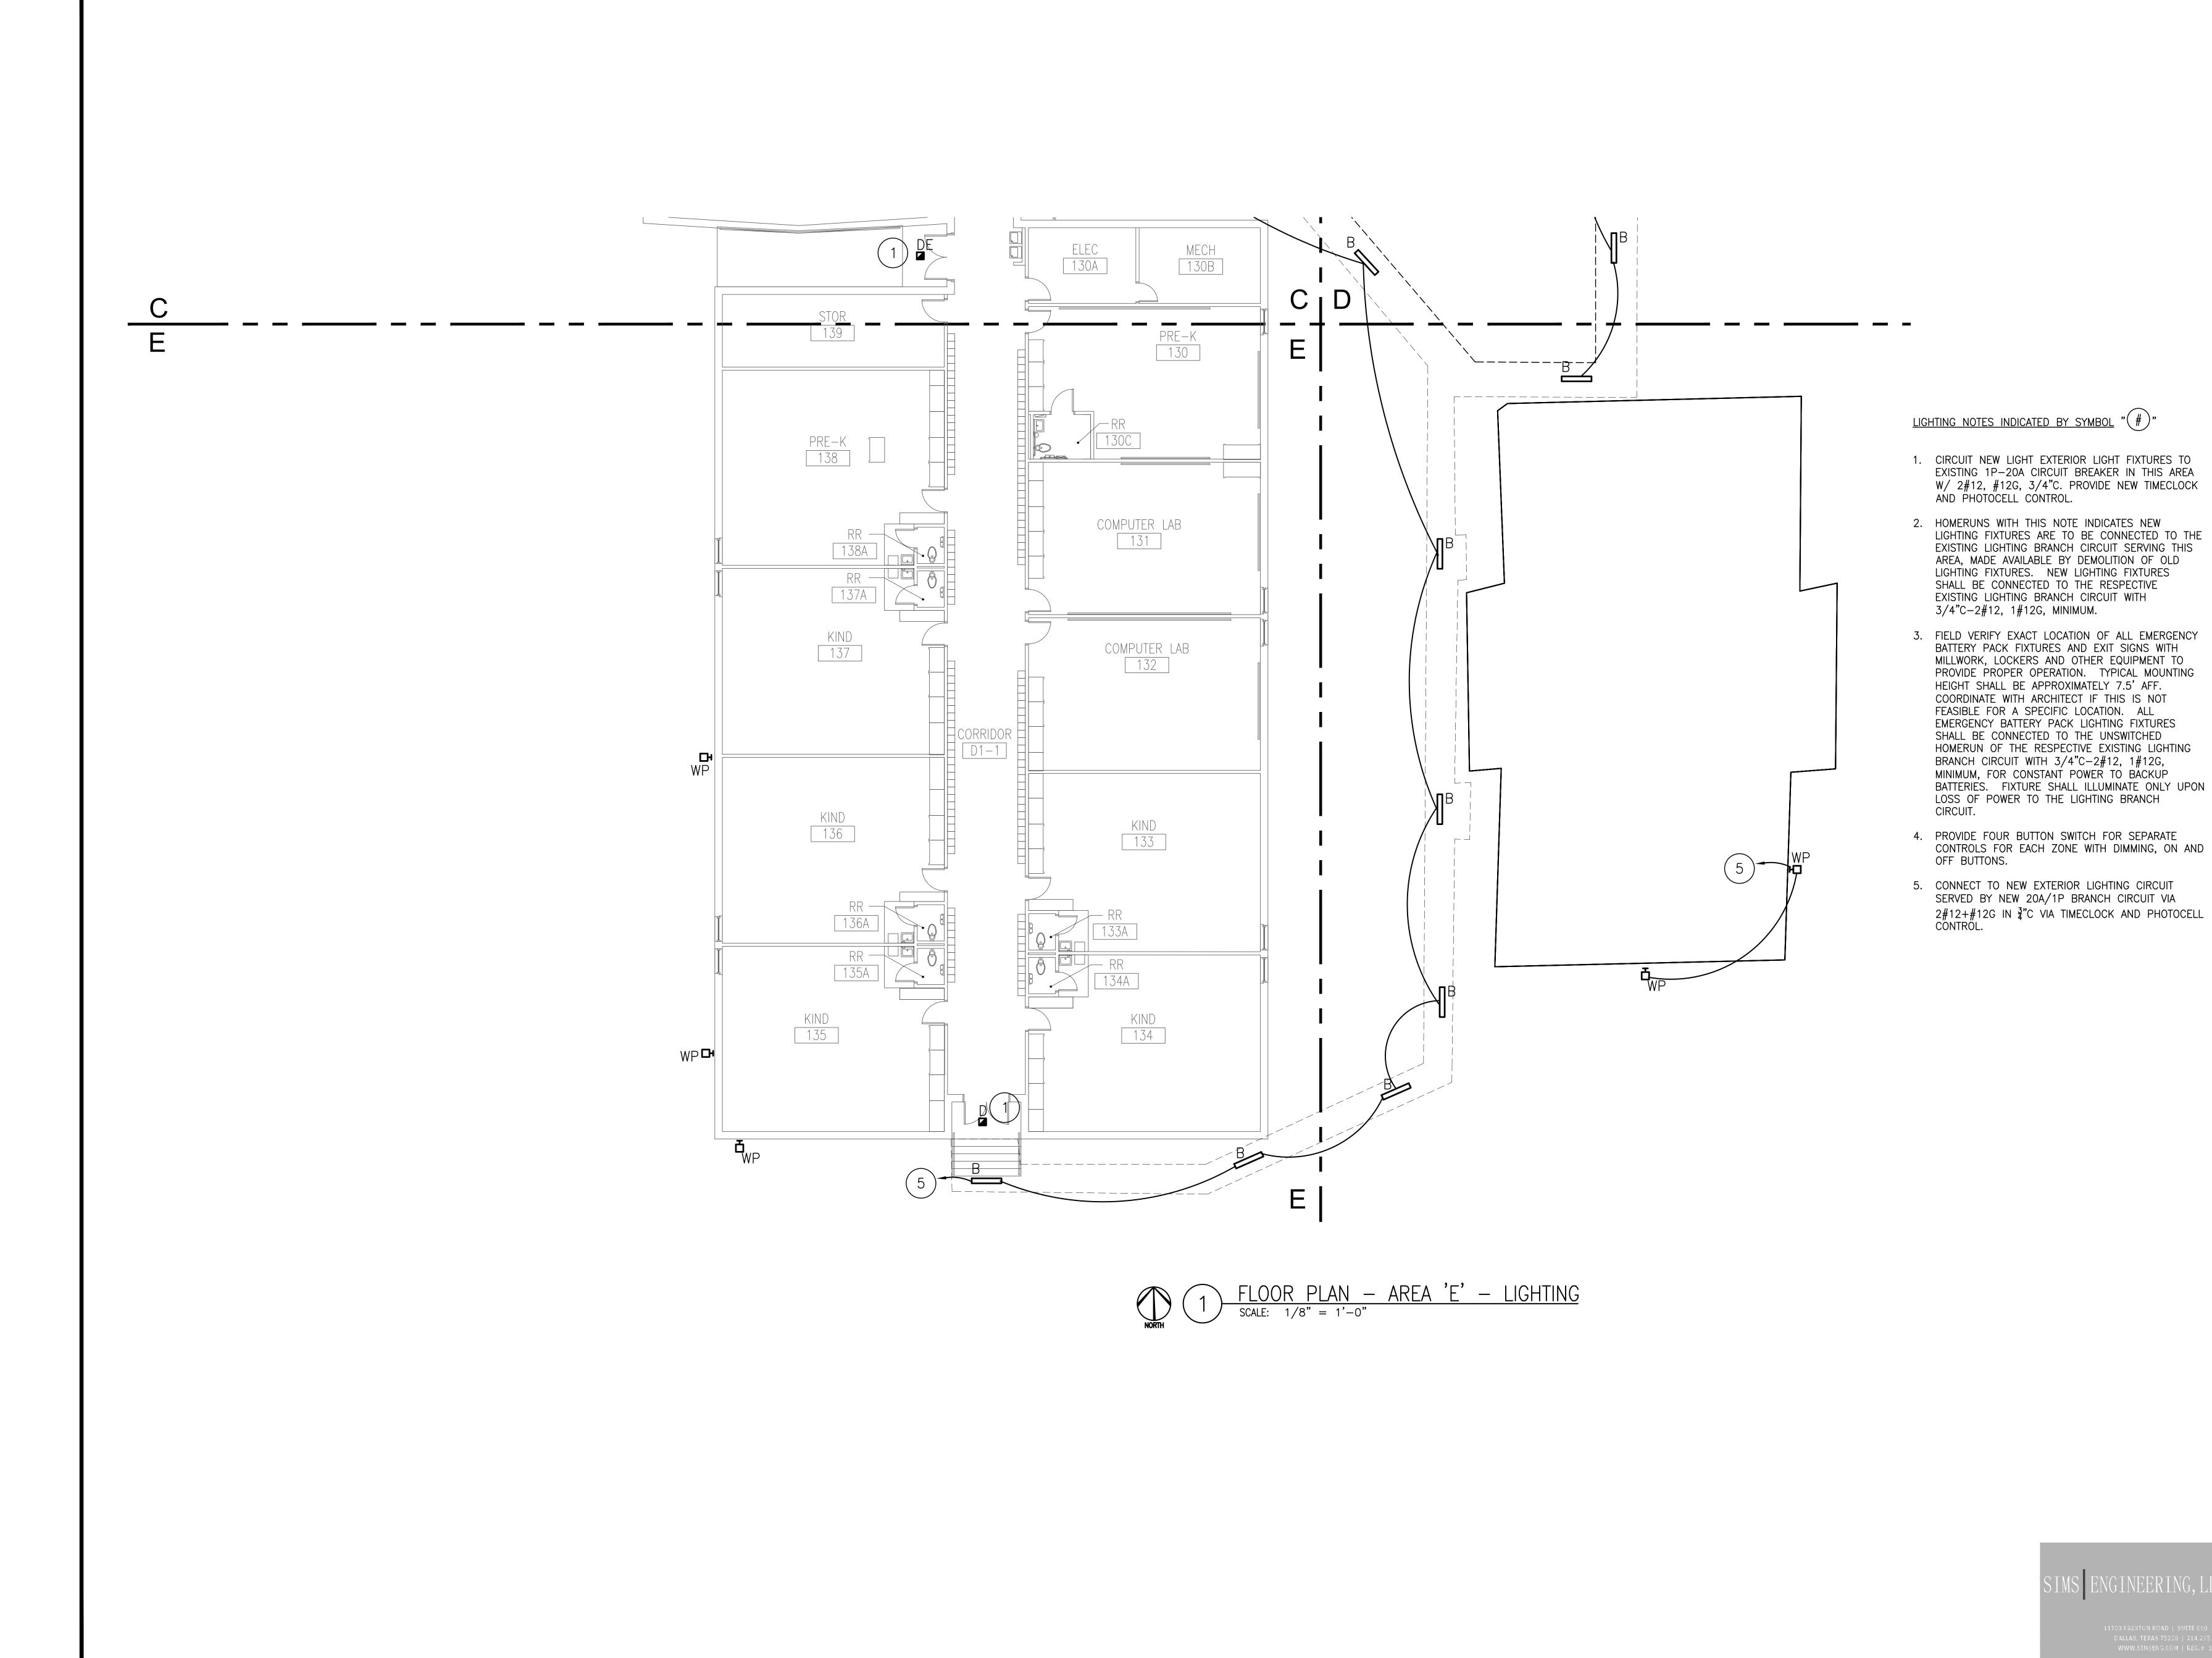
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FLOOR PLAN LIGHTING

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Sheet Title

FLOOR PLAN LIGHTING

Sheet Number



FLOOR PLAN - AREA 'E' - POWER

SCALE: 1/8" = 1'-0"

NOTES INDICATED BY SYMBOL , #),

CONNECTION TO NEW MARQUEE SIGN.

- POWERED BY OUTDOOR UNIT. RUN DESIGNATED CIRCUIT TO LOCATION OF OUTDOOR UNIT. COORDINATE WITH MECH FOR LOCATION. CONNECT INDOOR UNIT TO ASSOCIATED OUTDOOR UNIT. PROVIDE 2 #10 +#10G IN ₹"C FROM RECESSED HEAVY DUTY 2 POLE SWITCH AT INDOOR UNIT.
- 2. DISCONNECT AND RECONNECT NEW VAV BOXES. 3. CONNECT NEW FACP TO EXISTING CIRCUIT SERVING PREVIOUS FACP W/ 2#12, #12G, 3/4"C. RELOCATE FROM NURSE'S RESTROOM. COORDINATE EXACT LOCATION IN FIELD.
- 4. PROVIDE CONNECTION TO NEW MARQUEE SIGN FOR CONTROL. 5. ADMINISTRATIVE AREA AND CLINIC TO BE REMODELED. REFER TO ARCHITECTURAL DRAWINGS FOR SCOPE OF DEMOLITION. REMOVE
- POWER/DATA WITHIN WALLS SCHEDULED FOR DEMO. FOR ALL DEMOLISHED DEVICES, REMOVE WIRE AND CONDUIT BACK TO SOURCE OR NEAREST REMAINING "HOT" DEVICE ON CIRCUIT. 6. DATA AND POWER LOCATED WITHIN RECEPTION DESK. COORDINATE SPECIFIC LOCATION OF STUB UP FROM UNDER FLOOR WITH LOCATION OF FURNITURE. COORDINATE WITH MILLWORK DRAWINGS. PROVIDE
- 7. UNLESS SPECIFICALLY DESIGNATED FOR EQUIPMENT REQUIRING CONTINUOUS OPERATION(CABLE BOXES FOR TVS, APPLIANCES, ETC), PROVIDE SPLIT WIRED RECEPTACLES IN OFFICES AND CONFERENCE ROOMS, LABELED IN ACCORDANCE WITH NEC PER IECC 2021 WITH TOP PLUG TIED INTO A TIMECLOCK WITH OVERRIDE SWITCH WITHIN SIGHT OF
- UUILEIS. 8. DISCONNECT EXISTING PUMP & RECONNECT TO MCC. PROVIDE TWO 60A/3P BREAKERS WITHIN MCC TO FEED NEW CHWP PUMPS VIA 3#6+#10G IN 1"C & VFD. COOLING TOWER FANS AND CONDENSER WATER PUMP ARE NO LONGER SERVED BY MCC. REUSE SPACES AND PREVIOUS CHILLED WATER PUMP SPACE AND RELABEL THOSE NO LONGER USED AS SPARES.
- 9. DISCONNECT EXISTING PUMP & RECONNECT TO PANEL DB. PROVIDE TWO 50A/3P BREAKERS WITHIN DB TO FEED NEW HWP PUMPS VIA 3#8+#10G IN 1"C & VFD.
- 10. PROVIDE NEW 400A MLO 277/480V PANEL DB TO REPLACE EXISTING. PANEL FED BY 400A/3P SERVICE DISCONNECT IN MAIN SWITCHBOARD. 11. CONTRACTOR SHALL CONFIRM FACP & FAAP LOCATION WITH DISD AND ARCHITECT PRIOR TO ROUGH—IN.



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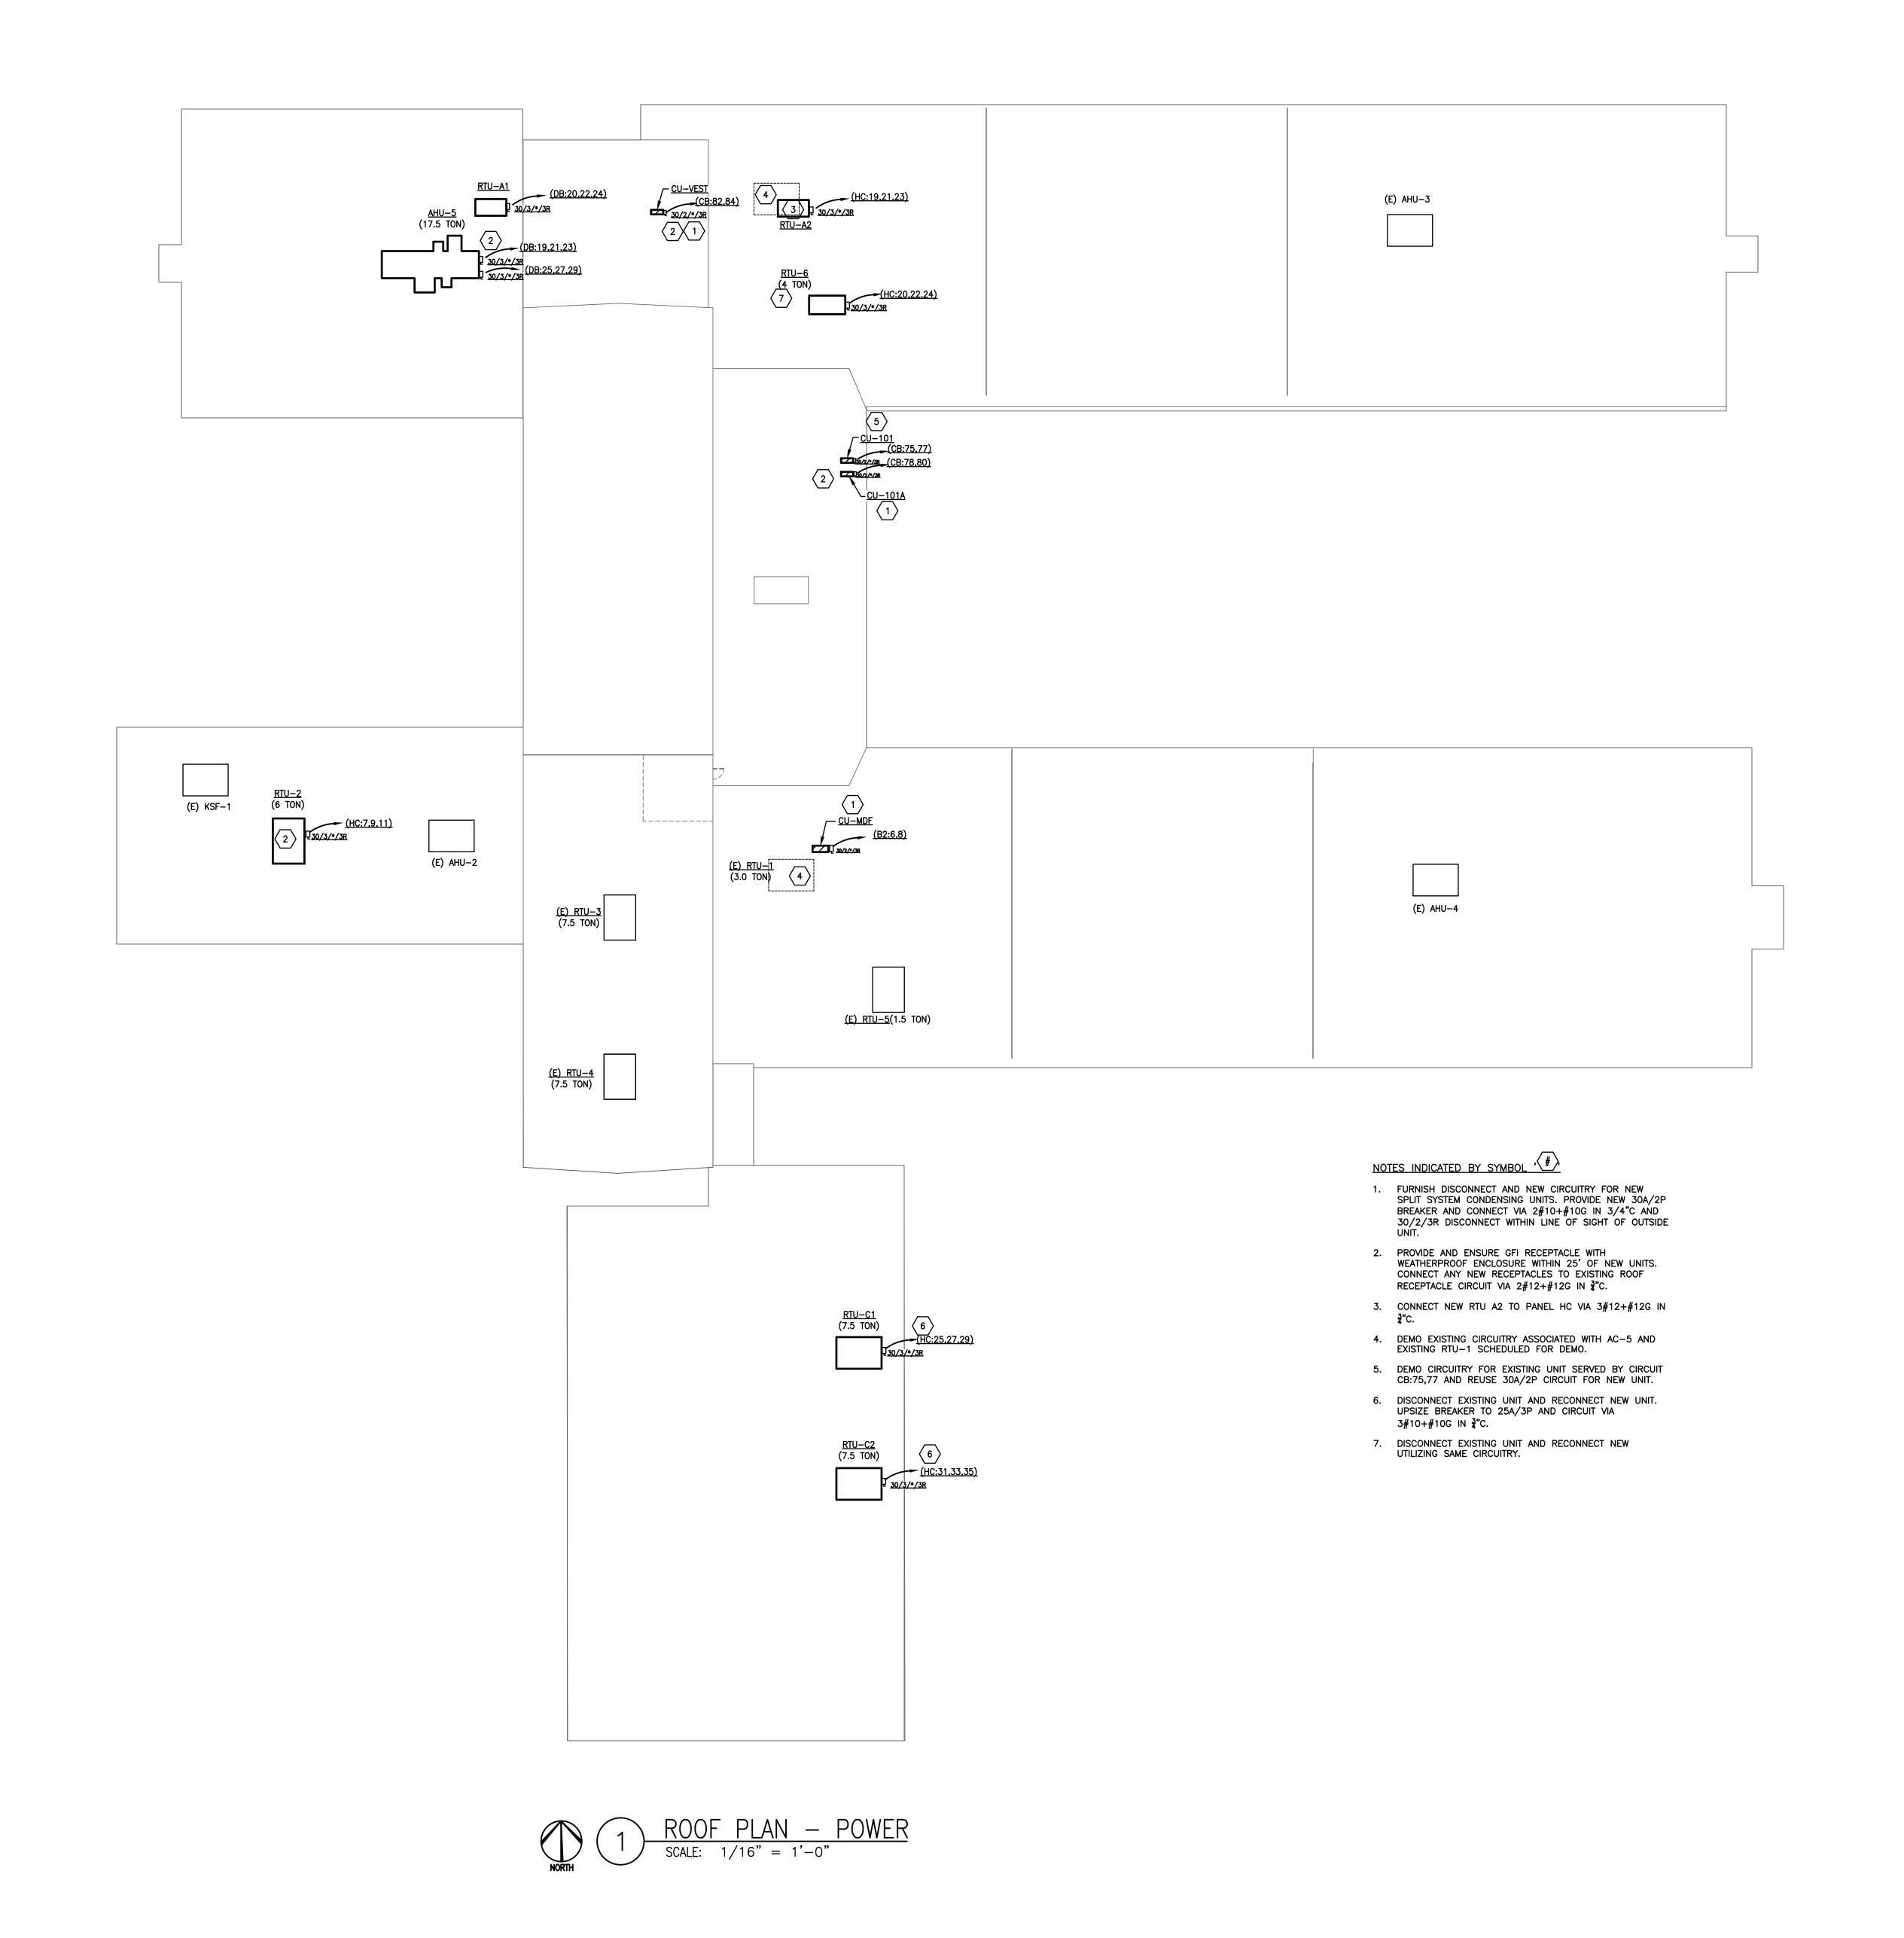
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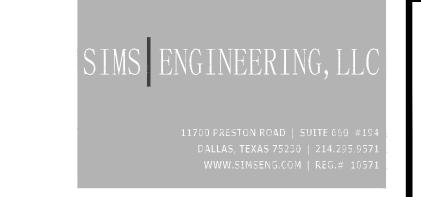
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FLOOR PLAN

Sheet Number





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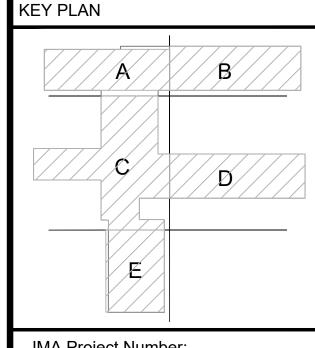
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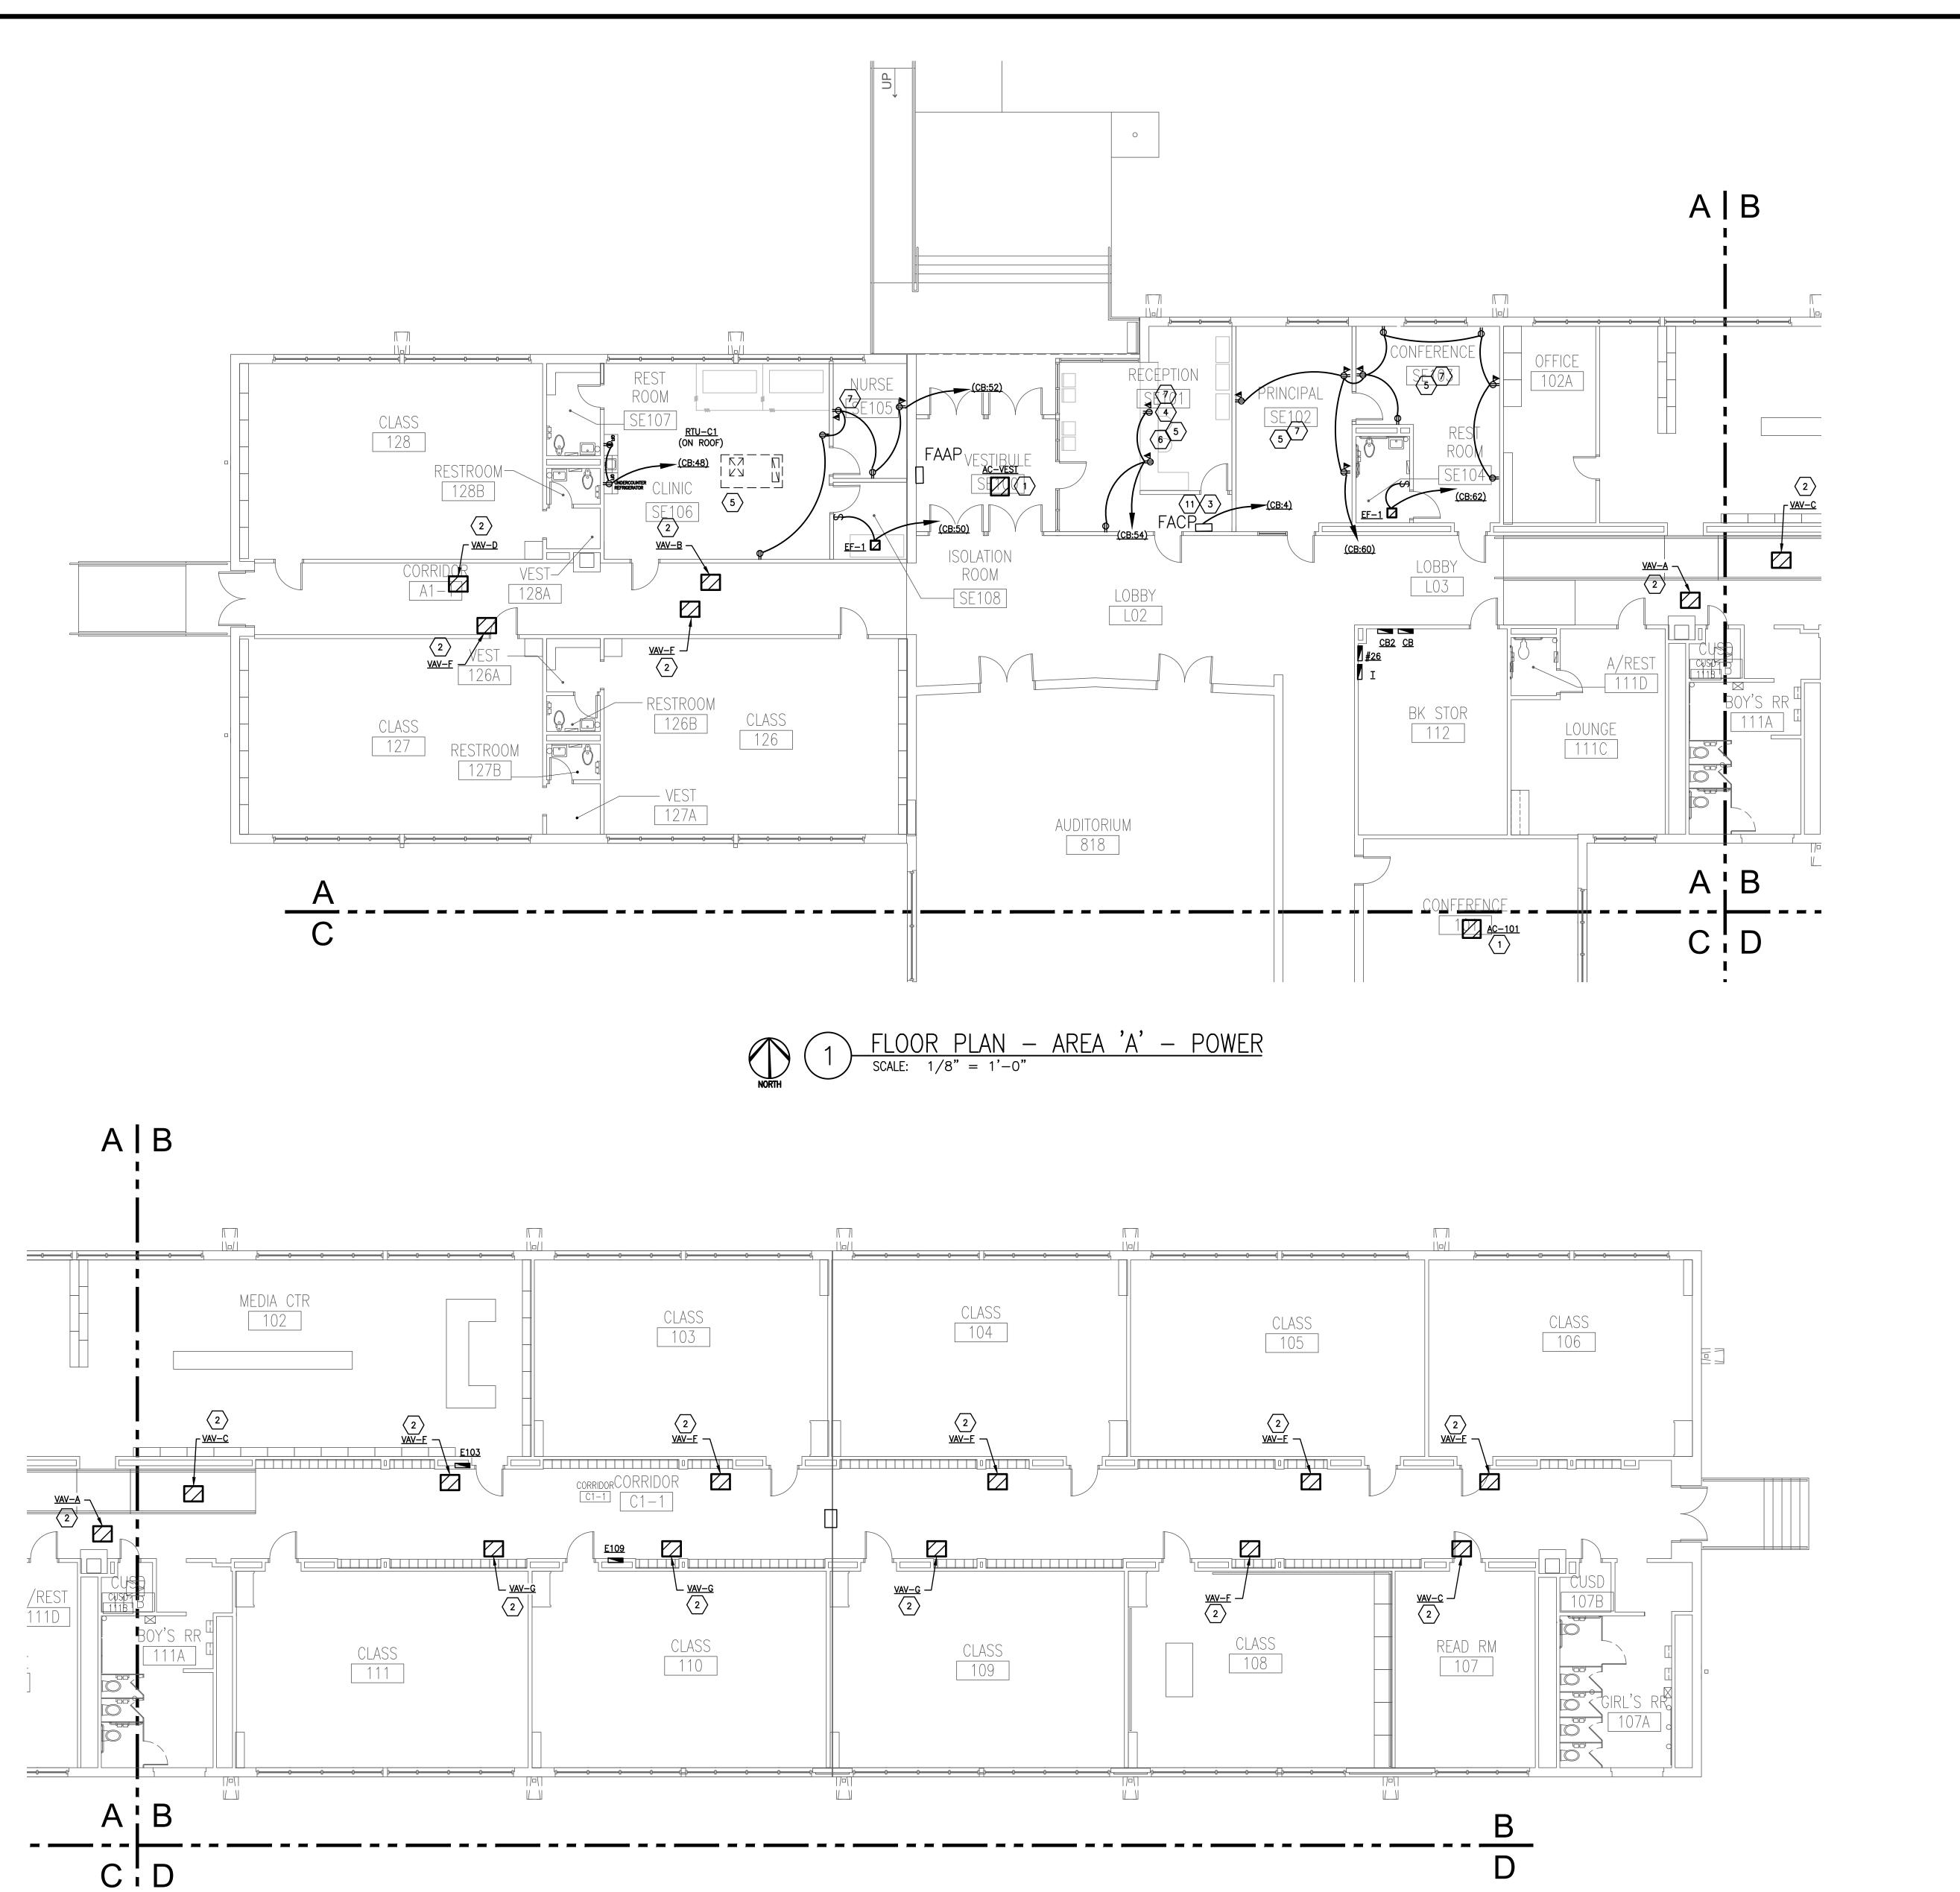
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Sheet Title **ROOF PLAN**



FLOOR PLAN — AREA 'B' — POWER

SCALE: 1/8" = 1'-0"



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OWNER'S REPRESENTATIVE:

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Dallas, Texas 75231

ADMINISTRATIVE AREA AND CLINIC TO BE REMODELED. REFER TO ARCHITECTURAL DRAWINGS FOR SCOPE OF DEMOLITION. REMOVE POWER/DATA WITHIN WALLS SCHEDULED FOR DEMO. FOR ALL DEMOLISHED DEVICES, REMOVE WIRE AND CONDUIT BACK TO SOURCE OR

OF FURNITURE. COORDINATE WITH MILLWORK DRAWINGS. PROVIDE CONNECTION TO NEW MARQUEE SIGN. 7. UNLESS SPECIFICALLY DESIGNATED FOR EQUIPMENT REQUIRING CONTINUOUS OPERATION(CABLE BOXES FOR TVS. APPLIANCES, ETC). PROVIDE SPLIT WIRED RECEPTACLES IN OFFICES AND CONFERENCE ROOMS, LABELED IN ACCORDANCE WITH NEC PER IECC 2021 WITH TOP PLUG TIED INTO A TIMECLOCK WITH OVERRIDE SWITCH WITHIN SIGHT OF

SPECIFIC LOCATION OF STUB UP FROM UNDER FLOOR WITH LOCATION

6. DATA AND POWER LOCATED WITHIN RECEPTION DESK. COORDINATE

1. POWERED BY OUTDOOR UNIT. RUN DESIGNATED CIRCUIT TO LOCATION OF OUTDOOR UNIT. COORDINATE WITH MECH FOR

LOCATION. CONNECT INDOOR UNIT TO ASSOCIATED OUTDOOR UNIT.

PROVIDE 2 #10 +#10G IN \(\frac{3}{4}\)"C FROM RECESSED HEAVY DUTY 2 POLE SWITCH AT INDOOR UNIT.

2#12, #12G, 3/4"C. RELOCATE FROM NURSE'S RESTROOM. COORDINATE

3. CONNECT NEW FACP TO EXISTING CIRCUIT SERVING PREVIOUS FACP W/

4. PROVIDE CONNECTION TO NEW MARQUEE SIGN FOR CONTROL.

NEAREST REMAINING "HOT" DEVICE ON CIRCUIT.

NOTES INDICATED BY SYMBOL , #),

EXACT LOCATION IN FIELD.

2. DISCONNECT AND RECONNECT NEW VAV BOXES.

8. DISCONNECT EXISTING PUMP & RECONNECT TO MCC. PROVIDE TWO 60A/3P BREAKERS WITHIN MCC TO FEED NEW CHWP PUMPS VIA 3#6+#10G IN 1"C & VFD. COOLING TOWER FANS AND CONDENSER WATER PUMP ARE NO LONGER SERVED BY MCC. REUSE SPACES AND

PREVIOUS CHILLED WATER PUMP SPACE AND RELABEL THOSE NO LONGER USED AS SPARES. 9. DISCONNECT EXISTING PUMP & RECONNECT TO PANEL DB. PROVIDE TWO 50A/3P BREAKERS WITHIN DB TO FEED NEW HWP PUMPS VIA

3#8+#10G IN 1"C & VFD. 10. PROVIDE NEW 400A MLO 277/480V PANEL DB TO REPLACE EXISTING. PANEL FED BY 400A/3P SERVICE DISCONNECT IN MAIN SWITCHBOARD.

11. CONTRACTOR SHALL CONFIRM FACP & FAAP LOCATION WITH DISD AND ARCHITECT PRIOR TO ROUGH—IN.

GENERAL POWER NOTES: (APPLIES TO ALL SHEETS)

1. INSTALL ALL RECEPTACLES AT 18"AFF TO TOP OF DEVICE, UNLESS NOTED OTHERWISE NOTED, TO MEET

ADA REQUIREMENTS.. 2. INSTALL ALL TELEPHONE, DATA, AND COMMUNICATIONS OUTLETS AT 18"AFF, UNLESS OTHERWISE NOTED. PROVIDE RECESSED METAL BACKBOX, COVERPLATE, AND 1" E.C. RISER TO ACCESSIBLE CEILING SPACE, WITH NYLON BUSHINGS ON EACH END AND PULL STRING. COMMUNICATIONS CABLING SHALL BE INSTALLED BY

3. MOUNTING HEIGHT OF ALL RECEPTACLES INDICATED AS ABOVE COUNTER SHALL BE COORDINATED WITH ARCHITECTURAL DETAILS.

4. GFCI PROTECTION SHALL BE PROVIDED FOR ALL RECEPTACLES WITHIN 6'-0" OF A SINK OR LAVATORY.

5. ALL RECEPTACLES SHALL BE TAMPER PROOF IN AREAS WHERE CHILDREN WILL BE PRESENT, INTERIOR AND EXTERIOR. KITCHEN, OFFICE, BREAKROOM, AND LAUNDRY RECEPTACLES ARE NOT REQUIRED TO BE TAMPER

6. ALL EXTERIOR DISCONNECT SWITCHES AND CONTROL DEVICES SHALL BE WEATHERPROOF. DISCONNECT SWITCHES FOR MECHANICAL EQUIPMENT SHALL NOT BE INSTALLED ON MOVING PARTS, REMOVABLE ACCESS PANELS, OR ON THE EQUIPMENT NAMEPLATE.

7. ALL CONDUIT IN EXPOSED AREAS SHALL BE EMT TYPE AND SHALL BE RUN RECTILINEAR TO STRUCTURE AND LIGHTS IN A NEAT MANNER. RE: ARCH. FOR ADDITIONAL REQUIREMENTS. ALL LOW VOLTAGE WIRING SHALL BE IN CONDUIT IN EXPOSED AREAS. MC CABLE IS ALLOWED IN CONCEALED AREAS & MUST BE SUPPORTED PROPERLY WITHOUT MORE THAN 12" SLACK.

8. ALL EMPTY CONDUIT SHALL HAVE PULL WIRE. 9. CONTRACTOR SHALL DISCONNECT AND RECONNECT ALL

10. CONTRACTOR SHALL DEMO ALL ASSOCIATED CIRCUITRY AND EQUIPMENT WITH MECHANICAL UNITS SCHEDULED FOR DEMO.

MECHANICAL UNITS SCHEDULED TO BE REPLACED.

REVISIONS: NO. | DATE | ISSUE: KEY PLAN

JMA Project Number:

Date: 08/09/2024


Sheet Title

FLOOR PLAN POWER

Sheet Number

E301

EIMS ENGINEERING, LLO

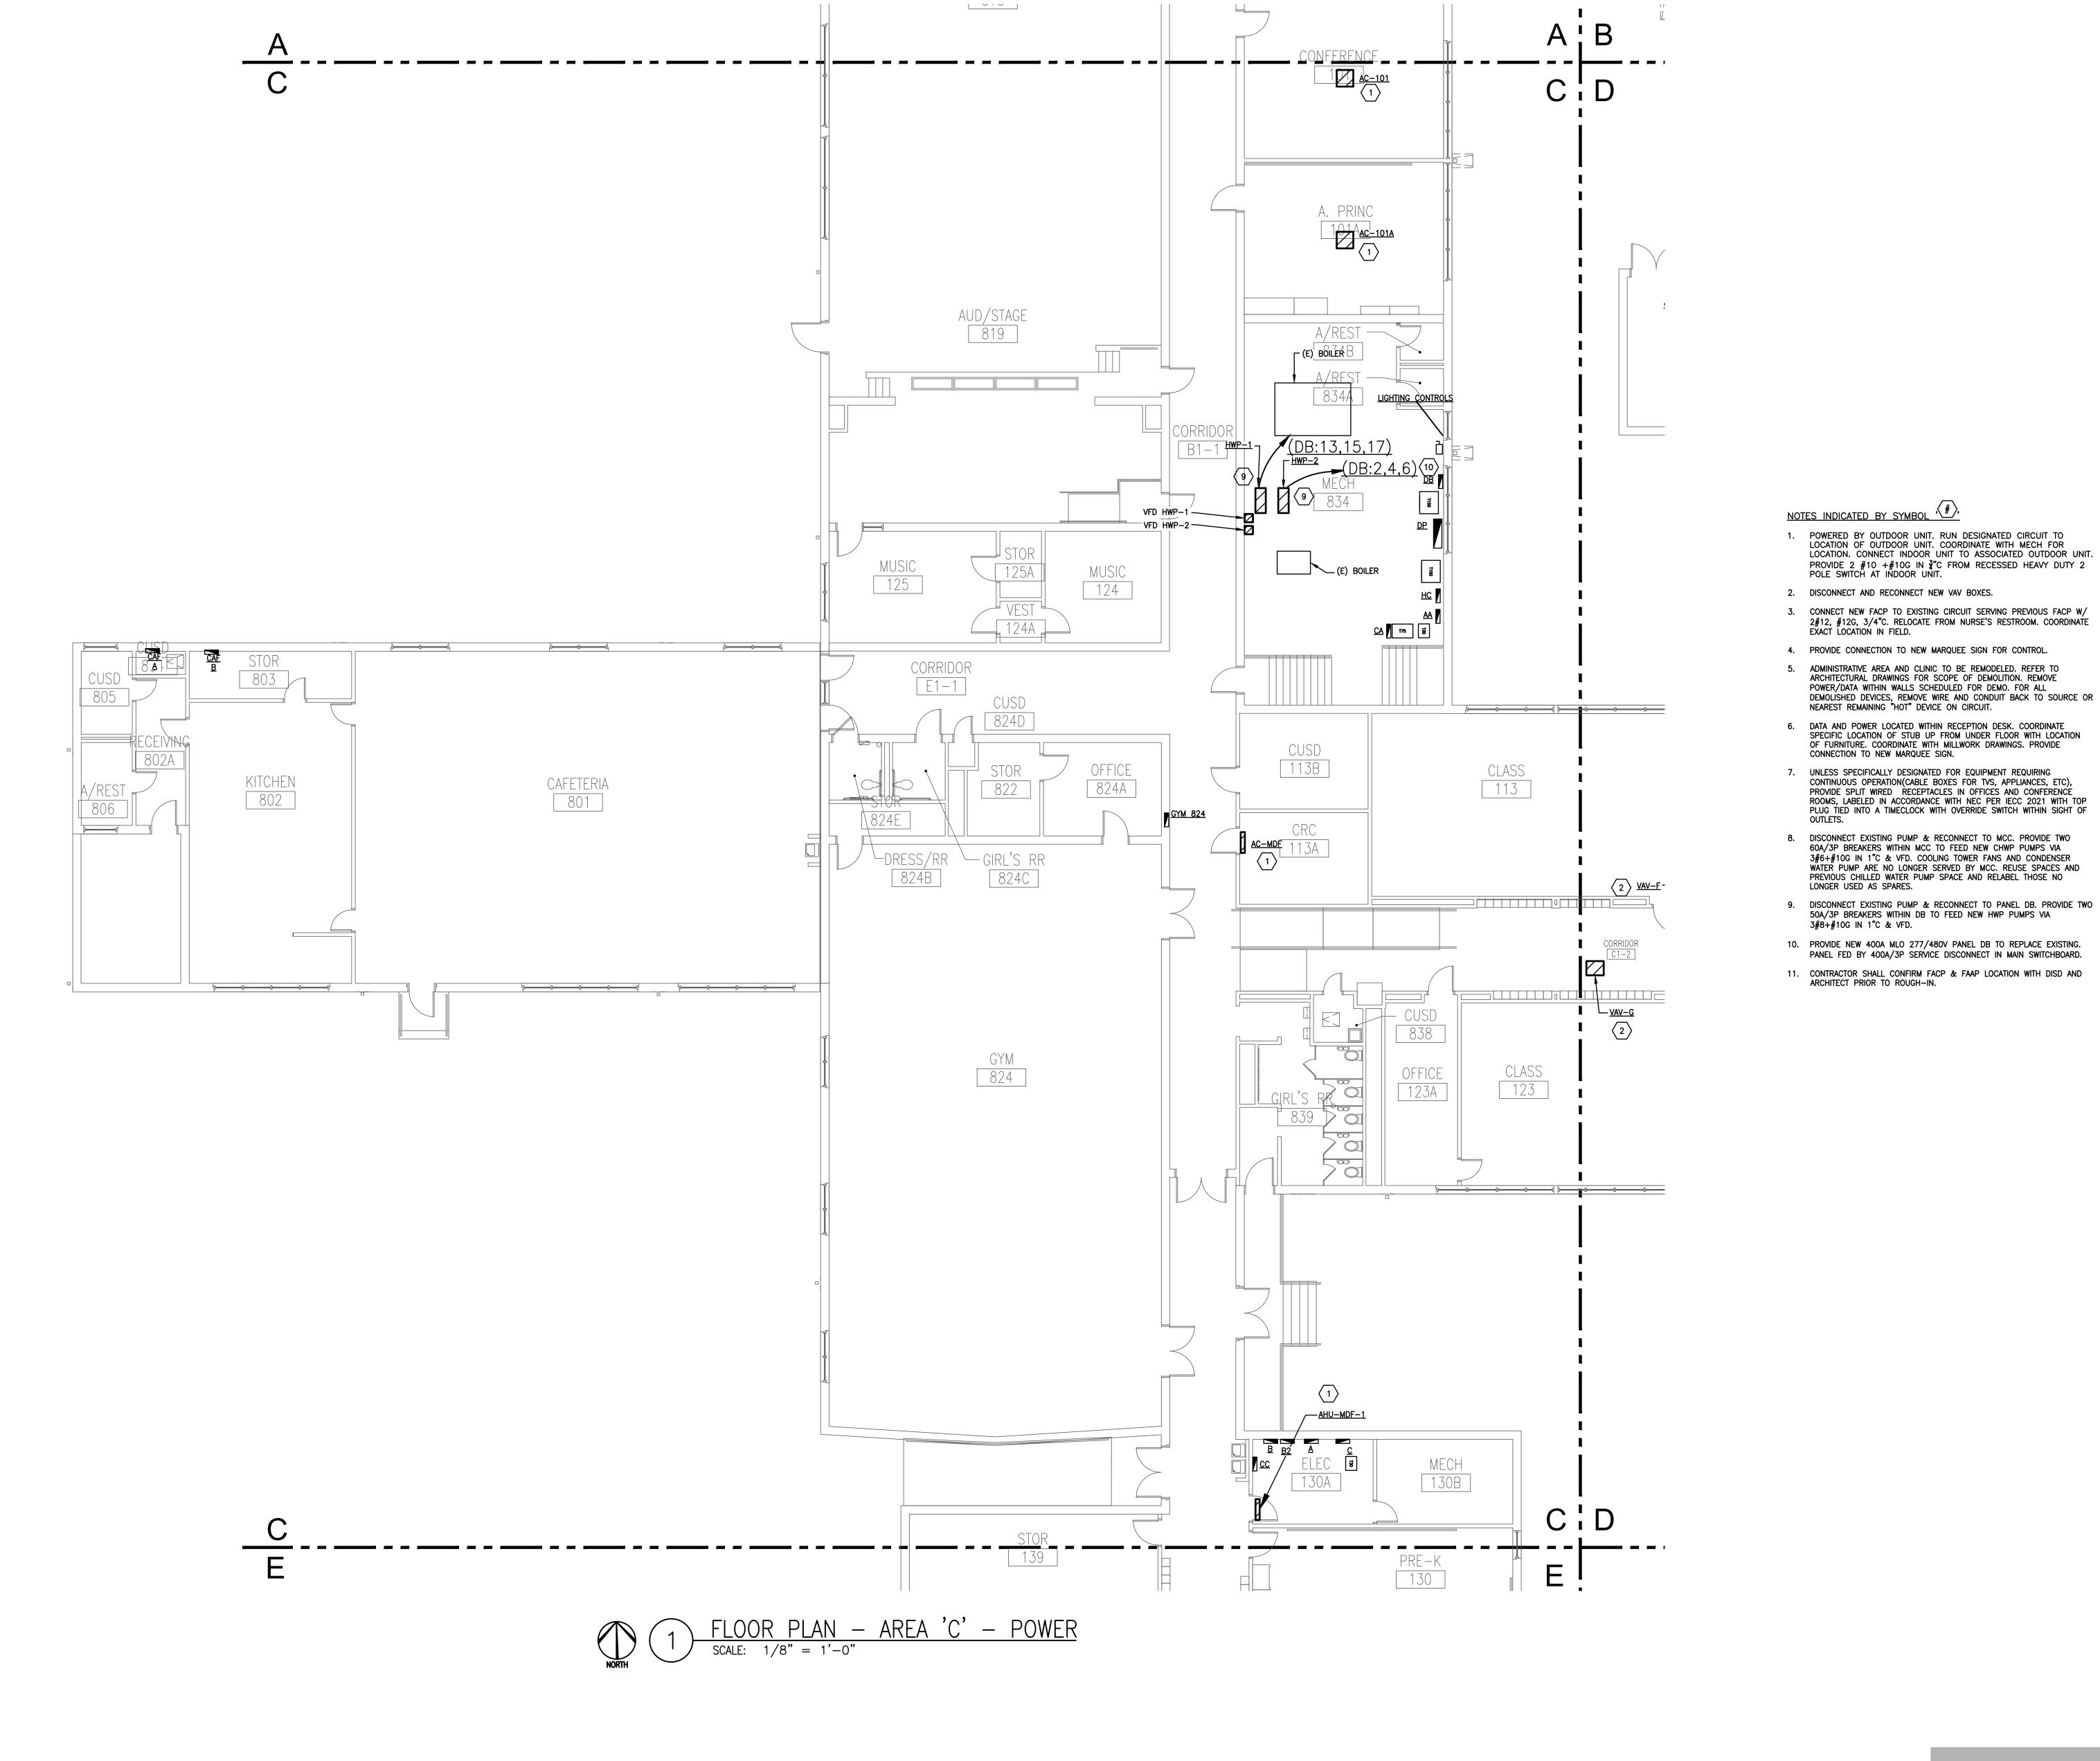

ARCHITECT:

13355 Noel Rd., Suite 1100, Dallas, Texas 75240 Phone: (214) 745-7070 Web Site - www.jmajohnsonarchitect.com

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6. DATA AND POWER LOCATED WITHIN RECEPTION DESK. COORDINATE SPECIFIC LOCATION OF STUB UP FROM UNDER FLOOR WITH LOCATION OF FURNITURE. COORDINATE WITH MILLWORK DRAWINGS. PROVIDE CONNECTION TO NEW MARQUEE SIGN.

CONTINUOUS OPERATION(CABLE BOXES FOR TVS, APPLIANCES, ETC), PROVIDE SPLIT WIRED RECEPTACLES IN OFFICES AND CONFERENCE ROOMS, LABELED IN ACCORDANCE WITH NEC PER IECC 2021 WITH TOP PLUG TIED INTO A TIMECLOCK WITH OVERRIDE SWITCH WITHIN SIGHT OF OUTLETS.

DISCONNECT EXISTING PUMP & RECONNECT TO MCC. PROVIDE TWO 60A/3P BREAKERS WITHIN MCC TO FEED NEW CHWP PUMPS VIA 3#6+#10G IN 1"C & VFD. COOLING TOWER FANS AND CONDENSER WATER PUMP ARE NO LONGER SERVED BY MCC. REUSE SPACES AND PREVIOUS CHILLED WATER PUMP SPACE AND RELABEL THOSE NO LONGER USED AS SPARES.

9. DISCONNECT EXISTING PUMP & RECONNECT TO PANEL DB. PROVIDE TWO 50A/3P BREAKERS WITHIN DB TO FEED NEW HWP PUMPS VIA 3#8+#10G IN 1"C & VFD.

10. PROVIDE NEW 400A MLO 277/480V PANEL DB TO REPLACE EXISTING. PANEL FED BY 400A/3P SERVICE DISCONNECT IN MAIN SWITCHBOARD.


11. CONTRACTOR SHALL CONFIRM FACP & FAAP LOCATION WITH DISD AND ARCHITECT PRIOR TO ROUGH—IN.

Is Independent School Distr 2020 Bond Program School for the Talented ar 724 Green Cove Lane - Dallas, Texas 75232

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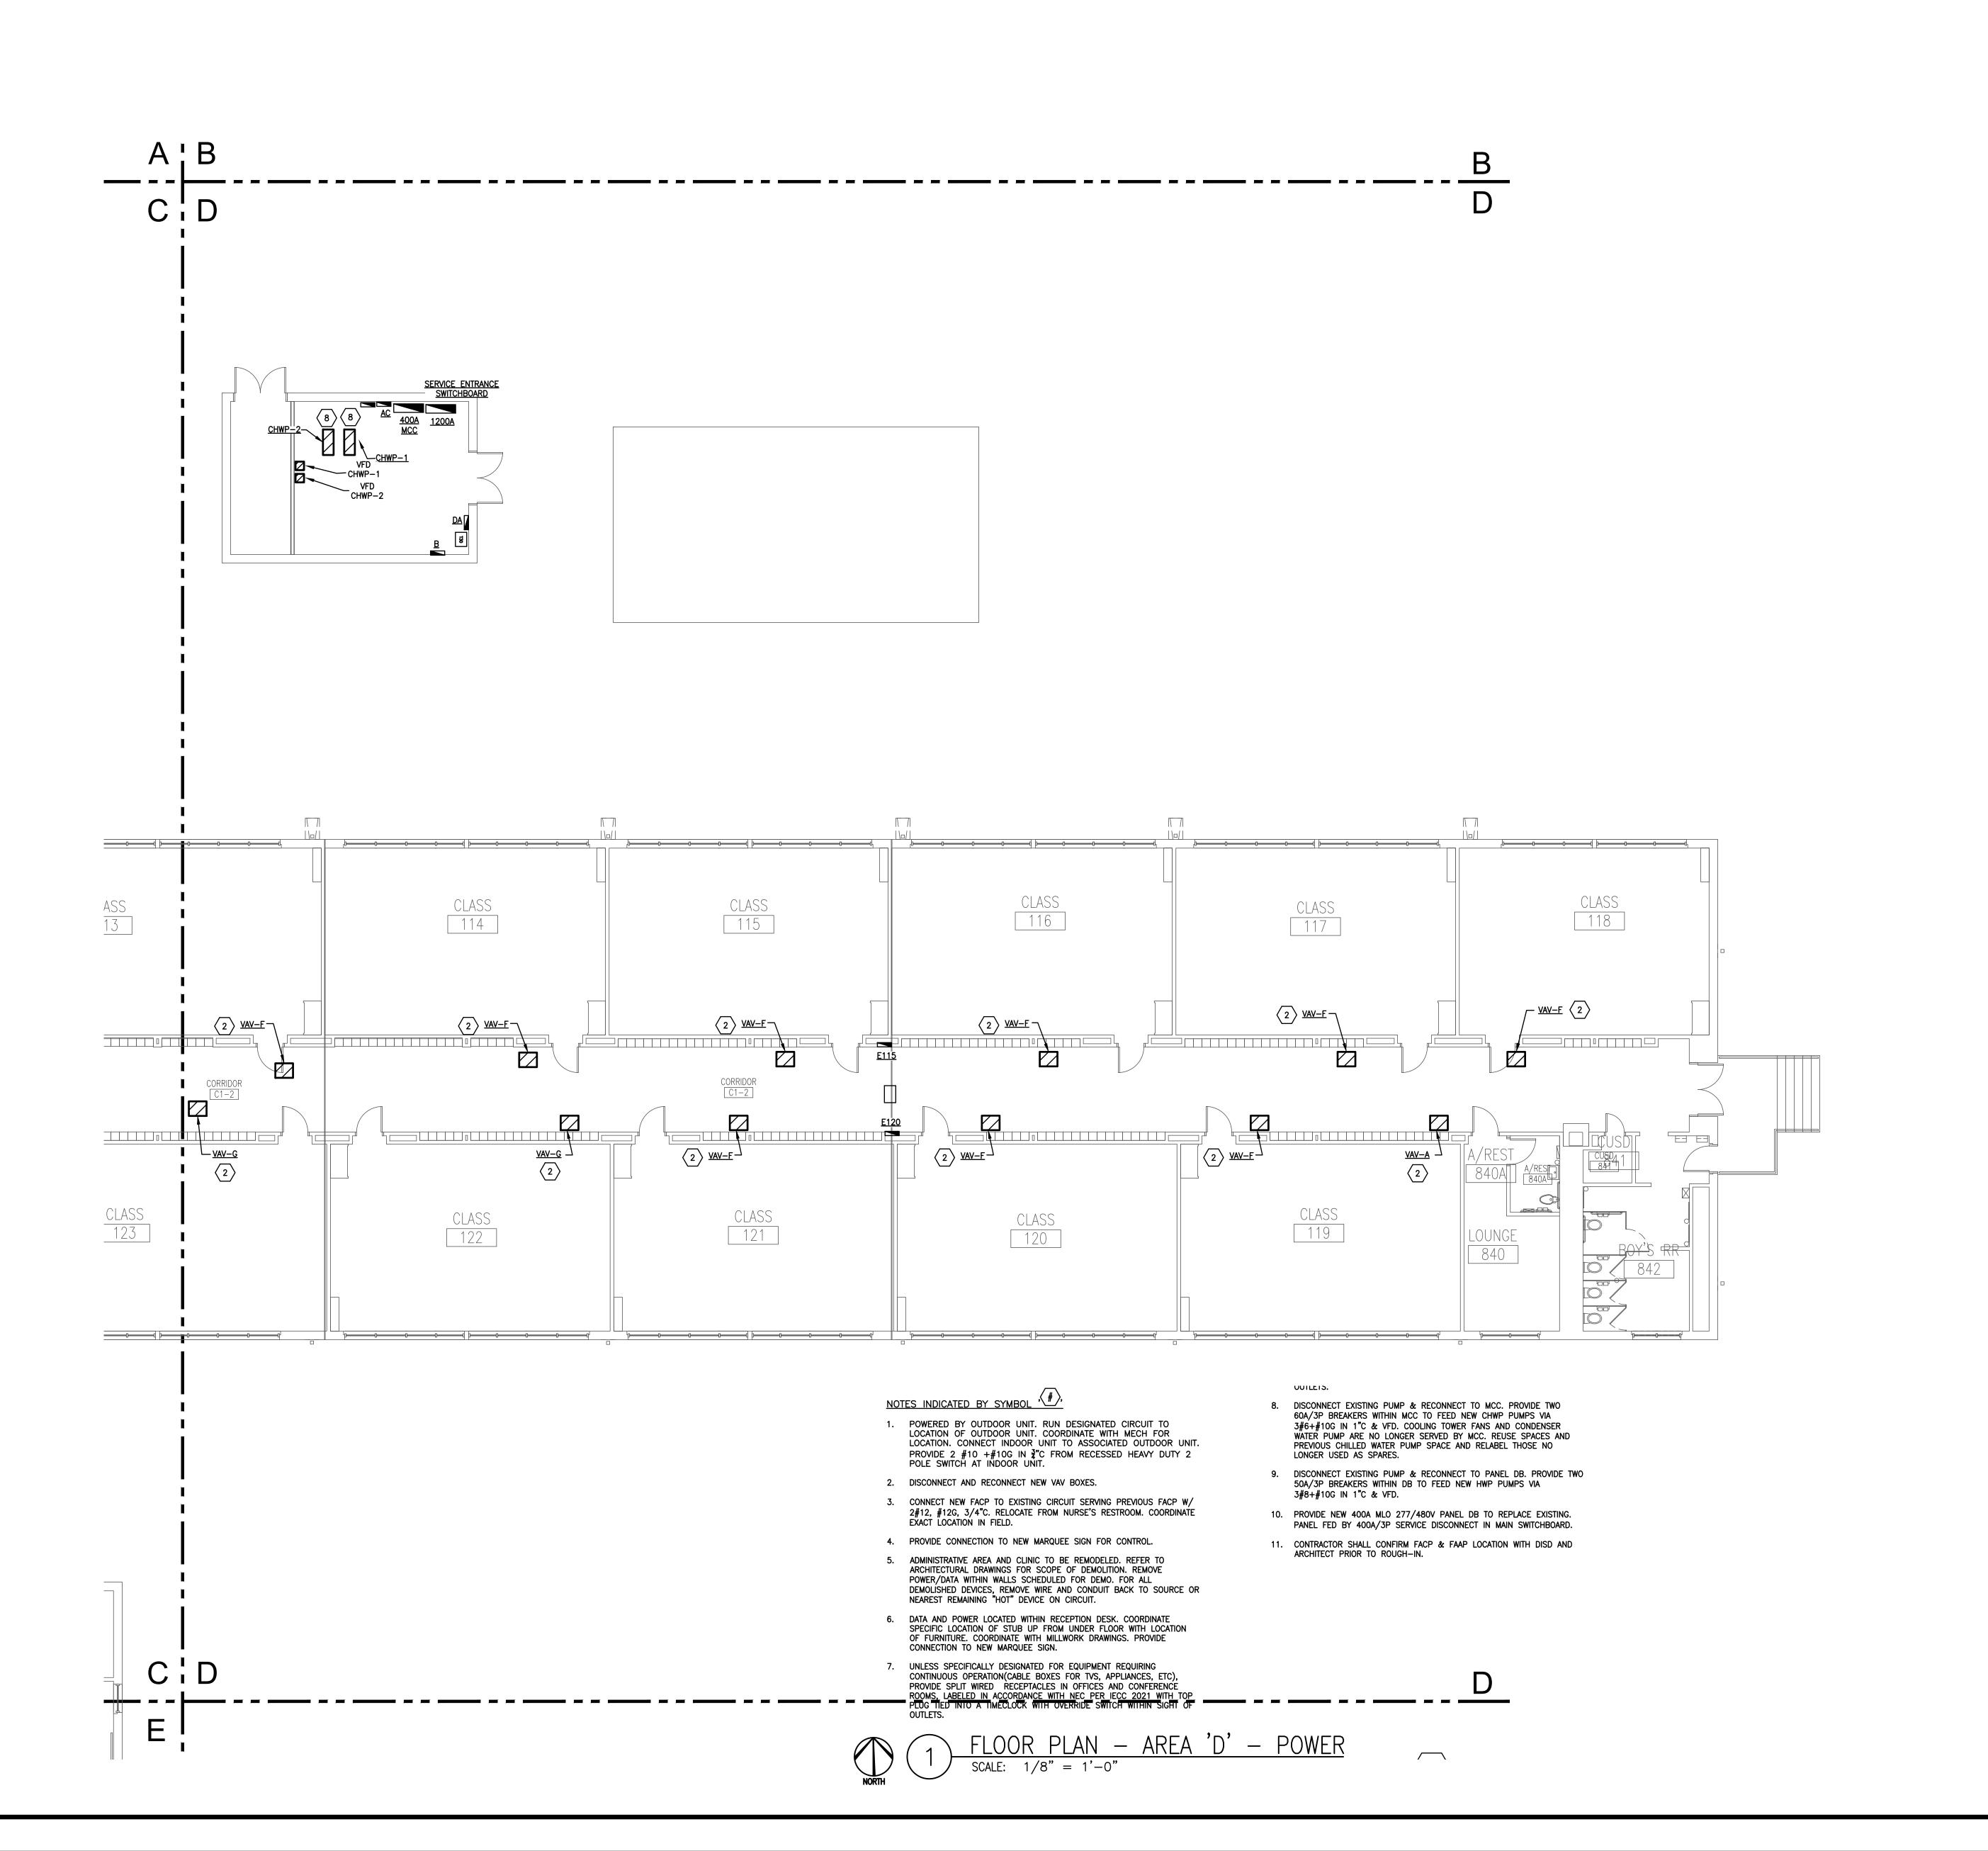
Sheet Title

FLOOR PLAN POWER

E302

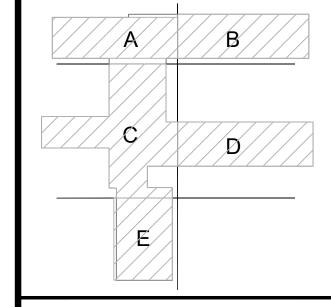SIMS ENGINEERING, LLC

11700 PRESTON ROAD | SUITE 660 #194
DALLAS, TEXAS 75230 | 214.295.9571
WWW.SIMSENG.COM | REG.# 10571





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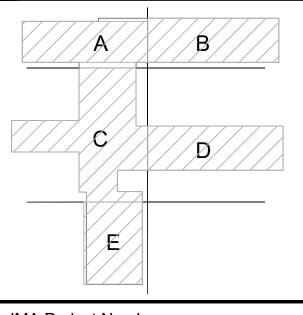
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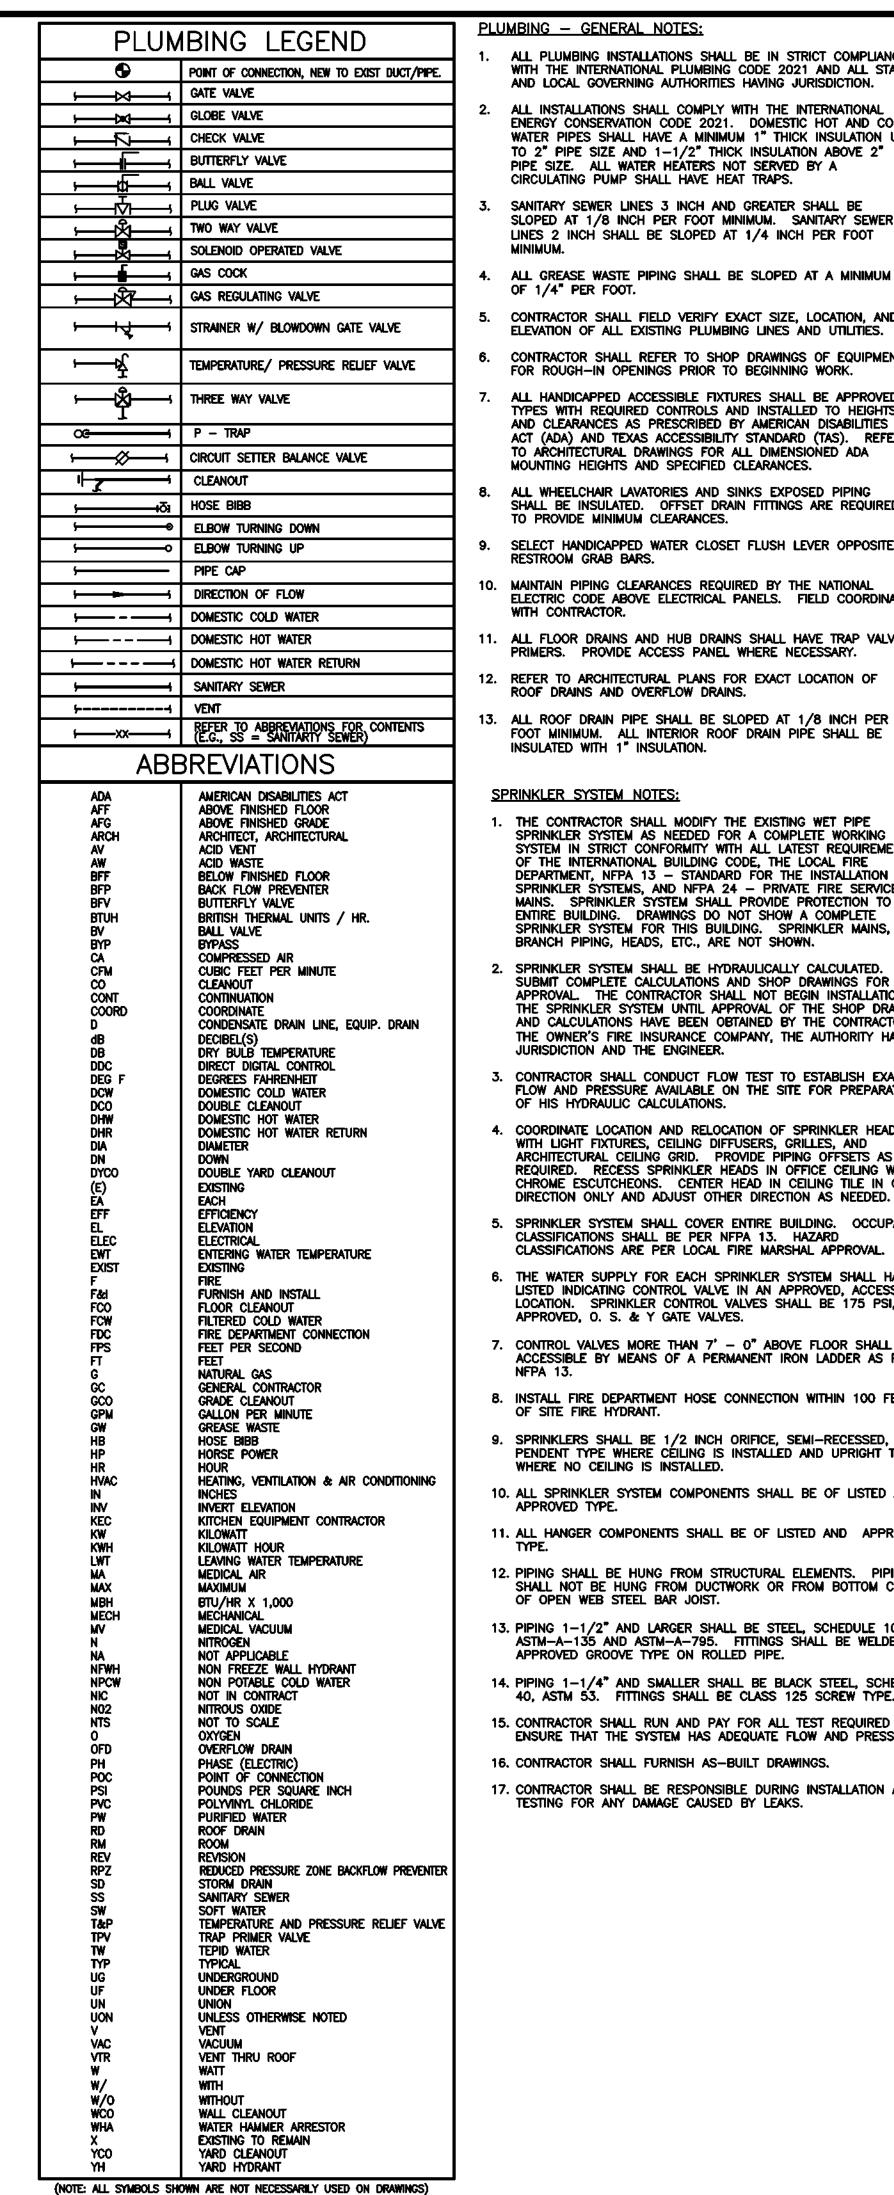
Date: 08/09/2024


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MS ENGINEERING, LLO

Sheet Title **FLOOR PLAN**

Sheet Number



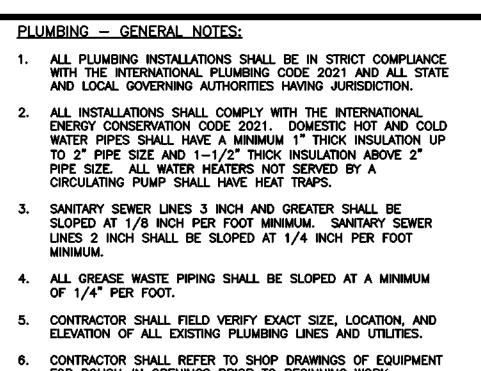

6.	CONTRACTOR SHALL REFER TO SHOP DRAWINGS OF EQUIPMENT FOR ROUGH—IN OPENINGS PRIOR TO BEGINNING WORK.
7.	ALL HANDICAPPED ACCESSIBLE FIXTURES SHALL BE APPROVED TYPES WITH REQUIRED CONTROLS AND INSTALLED TO HEIGHTS AND CLEARANCES AS PRESCRIBED BY AMERICAN DISABILITIES ACT (ADA) AND TEXAS ACCESSIBILITY STANDARD (TAS). REFER TO ARCHITECTURAL DRAWINGS FOR ALL DIMENSIONED ADA

ALL WHEELCHAIR LAVATORIES AND SINKS EXPOSED PIPING SHALL BE INSULATED. OFFSET DRAIN FITTINGS ARE REQUIRED TO PROVIDE MINIMUM CLEARANCES.

MOUNTING HEIGHTS AND SPECIFIED CLEARANCES.

- SELECT HANDICAPPED WATER CLOSET FLUSH LEVER OPPOSITE RESTROOM GRAB BARS. MAINTAIN PIPING CLEARANCES REQUIRED BY THE NATIONAL
- ELECTRIC CODE ABOVE ELECTRICAL PANELS. FIELD COORDINATE
- 11. ALL FLOOR DRAINS AND HUB DRAINS SHALL HAVE TRAP VALVE PRIMERS. PROVIDE ACCESS PANEL WHERE NECESSARY.

FOOT MINIMUM. ALL INTERIOR ROOF DRAIN PIPE SHALL BE

- REFER TO ARCHITECTURAL PLANS FOR EXACT LOCATION OF ROOF DRAINS AND OVERFLOW DRAINS.
- SPRINKLER SYSTEM NOTES:


INSULATED WITH 1" INSULATION.


- THE CONTRACTOR SHALL MODIFY THE EXISTING WET PIPE SPRINKLER SYSTEM AS NEEDED FOR A COMPLETE WORKING SYSTEM IN STRICT CONFORMITY WITH ALL LATEST REQUIREMENTS OF THE INTERNATIONAL BUILDING CODE, THE LOCAL FIRE DEPARTMENT, NFPA 13 - STANDARD FOR THE INSTALLATION O SPRINKLER SYSTEMS, AND NFPA 24 - PRIVATE FIRE SERVICE MAINS. SPRINKLER SYSTEM SHALL PROVIDE PROTECTION TO ENTIRE BUILDING. DRAWINGS DO NOT SHOW A COMPLETE SPRINKLER SYSTEM FOR THIS BUILDING. SPRINKLER MAINS, BRANCH PIPING, HEADS, ETC., ARE NOT SHOWN.
- SPRINKLER SYSTEM SHALL BE HYDRAULICALLY CALCULATED. SUBMIT COMPLETE CALCULATIONS AND SHOP DRAWINGS FOR APPROVAL. THE CONTRACTOR SHALL NOT BEGIN INSTALLATION OF THE SPRINKLER SYSTEM UNTIL APPROVAL OF THE SHOP DRAWINGS AND CALCULATIONS HAVE BEEN OBTAINED BY THE CONTRACTOR, THE OWNER'S FIRE INSURANCE COMPANY, THE AUTHORITY HAVING JURISDICTION AND THE ENGINEER.
- CONTRACTOR SHALL CONDUCT FLOW TEST TO ESTABLISH EXACT FLOW AND PRESSURE AVAILABLE ON THE SITE FOR PREPARATION OF HIS HYDRAULIC CALCULATIONS.
- COORDINATE LOCATION AND RELOCATION OF SPRINKLER HEADS WITH LIGHT FIXTURES, CEILING DIFFUSERS, GRILLES, AND ARCHITECTURAL CEILING GRID. PROVIDE PIPING OFFSETS AS REQUIRED. RECESS SPRINKLER HEADS IN OFFICE CEILING WITH CHROME ESCUTCHEONS. CENTER HEAD IN CEILING TILE IN ONE DIRECTION ONLY AND ADJUST OTHER DIRECTION AS NEEDED.
- SPRINKLER SYSTEM SHALL COVER ENTIRE BUILDING. OCCUPANCY CLASSIFICATIONS SHALL BE PER NFPA 13. HAZARD CLASSIFICATIONS ARE PER LOCAL FIRE MARSHAL APPROVAL.
- THE WATER SUPPLY FOR EACH SPRINKLER SYSTEM SHALL HAVE LISTED INDICATING CONTROL VALVE IN AN APPROVED. ACCESSIBLE LOCATION. SPRINKLER CONTROL VALVES SHALL BE 175 PSI, U.L. APPROVED, O. S. & Y GATE VALVES.
- CONTROL VALVES MORE THAN 7' 0" ABOVE FLOOR SHALL BE ACCESSIBLE BY MEANS OF A PERMANENT IRON LADDER AS PER
- INSTALL FIRE DEPARTMENT HOSE CONNECTION WITHIN 100 FEET
- SPRINKLERS SHALL BE 1/2 INCH ORIFICE, SEMI-RECESSED, PENDENT TYPE WHERE CEILING IS INSTALLED AND UPRIGHT TYPE WHERE NO CEILING IS INSTALLED. 10. ALL SPRINKLER SYSTEM COMPONENTS SHALL BE OF LISTED AND
- 11. ALL HANGER COMPONENTS SHALL BE OF LISTED AND APPROVED
- 12. PIPING SHALL BE HUNG FROM STRUCTURAL ELEMENTS. PIPING SHALL NOT BE HUNG FROM DUCTWORK OR FROM BOTTOM CHORD OF OPEN WEB STEEL BAR JOIST. 13. PIPING 1-1/2" AND LARGER SHALL BE STEEL, SCHEDULE 10, ASTM-A-135 AND ASTM-A-795. FITTINGS SHALL BE WELDED OR


APPROVED GROOVE TYPE ON ROLLED PIPE.

TESTING FOR ANY DAMAGE CAUSED BY LEAKS.

- 14. PIPING 1-1/4" AND SMALLER SHALL BE BLACK STEEL, SCHEDULE 40, ASTM 53. FITTINGS SHALL BE CLASS 125 SCREW TYPE. 15. CONTRACTOR SHALL RUN AND PAY FOR ALL TEST REQUIRED TO ENSURE THAT THE SYSTEM HAS ADEQUATE FLOW AND PRESSURE.
- 16. CONTRACTOR SHALL FURNISH AS-BUILT DRAWINGS 17. CONTRACTOR SHALL BE RESPONSIBLE DURING INSTALLATION AND

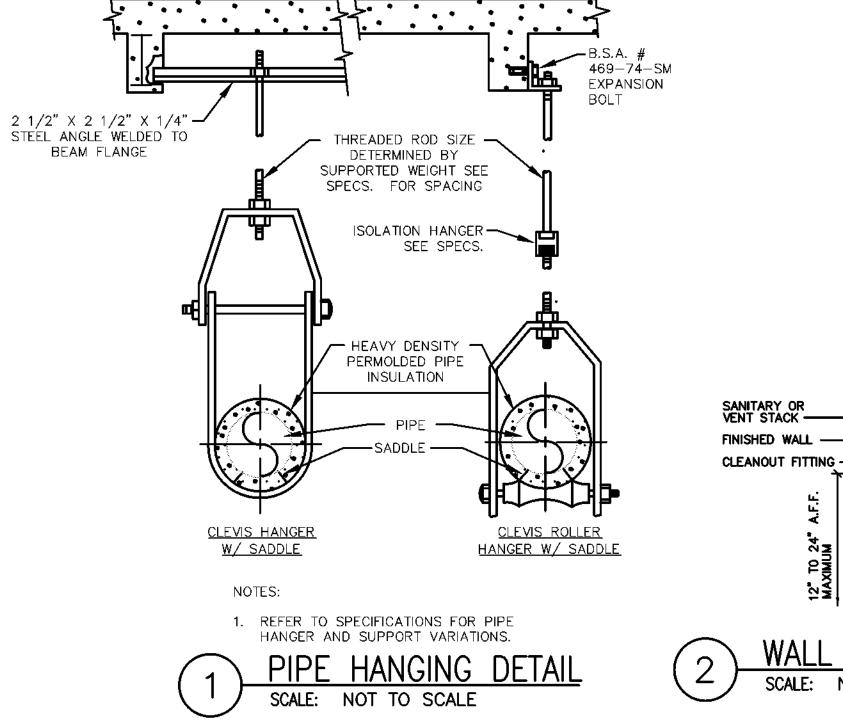

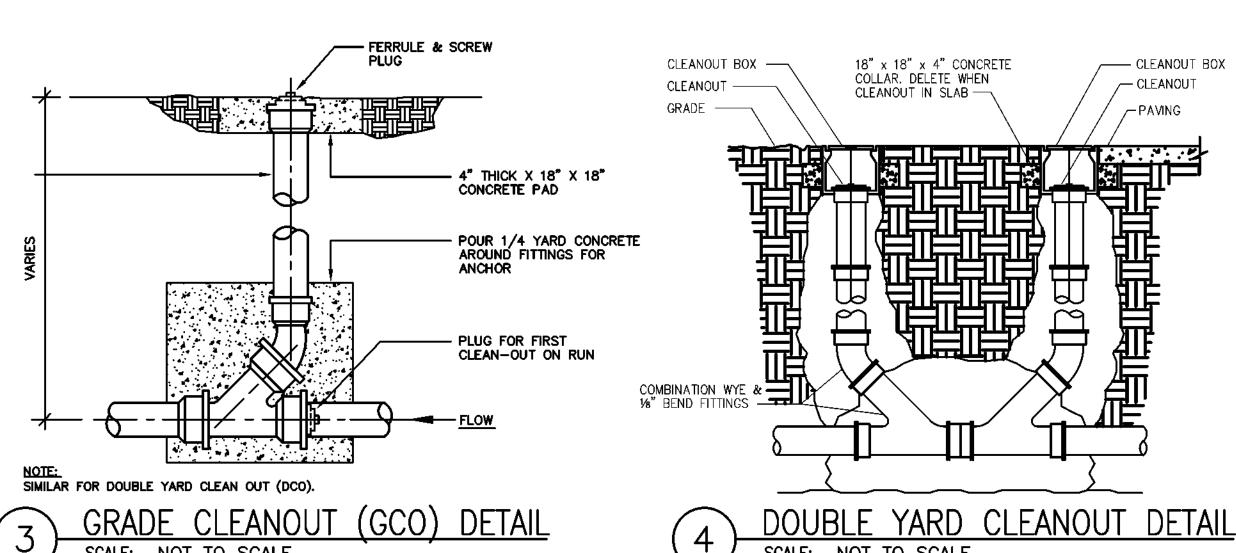

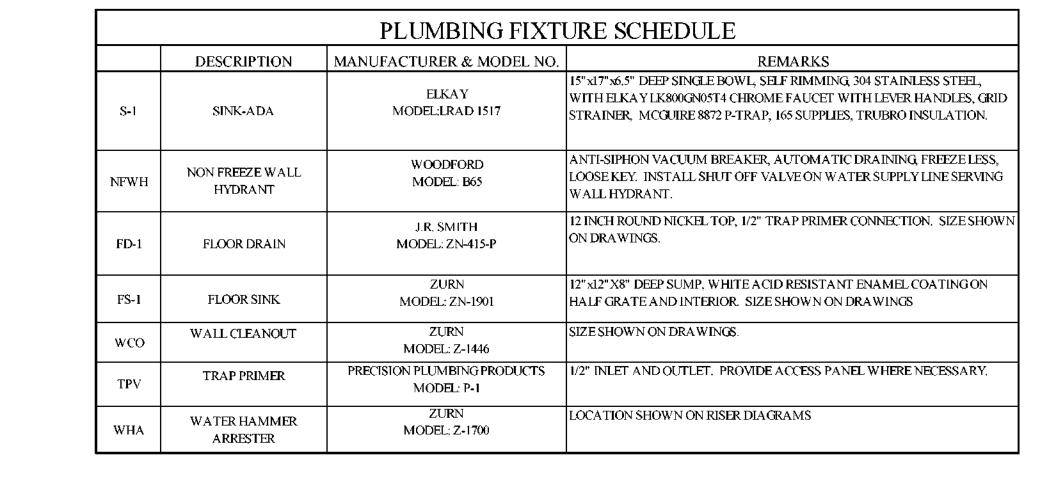

GAS WATER HEATER SCHEDULE											
MARK	SERVICE		MIN. EFF. %		RECOVERY GPH @100 °F		REMARKS				
GWH-1	DOMESTIC HOT WATER	199,000	97	100	233	120/1	A.O. SMITH BTH-199, NOTES 1-4				

- FURNISH W/5-YEAR TANK WARRANTY.
- FURNISH W/CONCENTRIC VENT TERMINATION FOR DIRECT VENTING. FURNISH WITH ACID NEUTRALIZATION BASIN.
- FURNISH THE UNIT SCHEDULED OR EQUAL BY LOCHINVAR OR RBI


CIRCULATING PUMP								
			FLOW	PUMP	MOTOR	PUMP		
			RATE	HEAD	SIZE	SPEED	ELECTRICAL	
MARK	SERVICE	LOCATION	(GPM)	(FT)	(WATTS)	(RPM)	CHARACTERISTICS	REMARKS
CP-1	HW CIRCULATION	MECH ROOM	3	15	45	3 SPEED	110V / 60 HZ / 1 PH	GRUNDFOS ALPHA 15-55SF


SAMPLE WELL BASIN

SCALE NONE DWG. NO.

DATE 10/2021 SWB-1

- CIRCULATING PUMP SHALL BE INSTALLED PER MANUFACTURER'S INSTRUCTIONS.
- DOMESTIC WATER CIRCULATING PUMPS SHALL HAVE NO STEEL OR CAST IRON WETTED PARTS. PUMPS SHALL HAVE BRONZE OR STAINLESS
- FURNISH RECIRC PUMP WITH MANUFACTURER'S TIMECLOCK. COORDINATE SCHEDULE WITH OWNER PRIOR TO TURNING THE SYSTEM OVER.

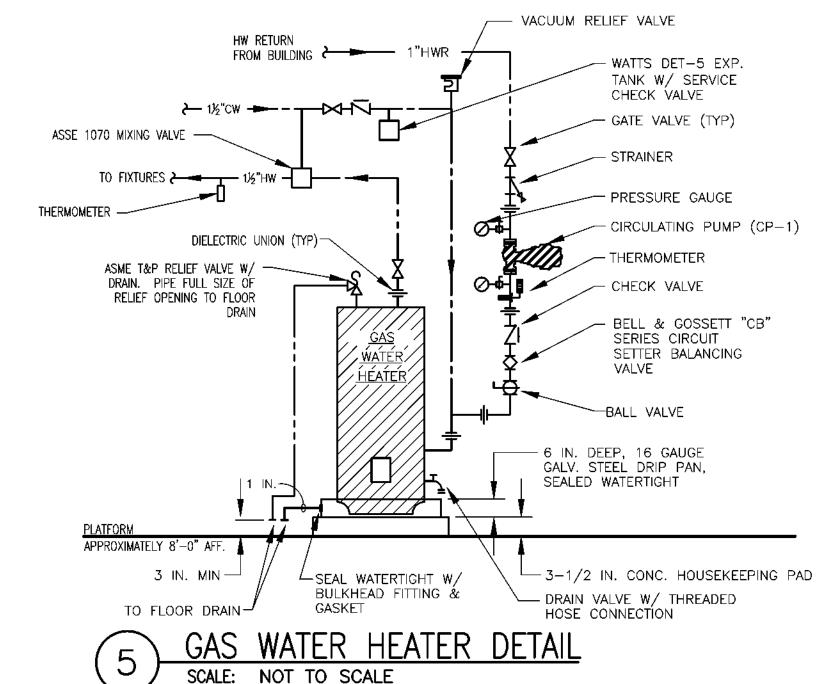

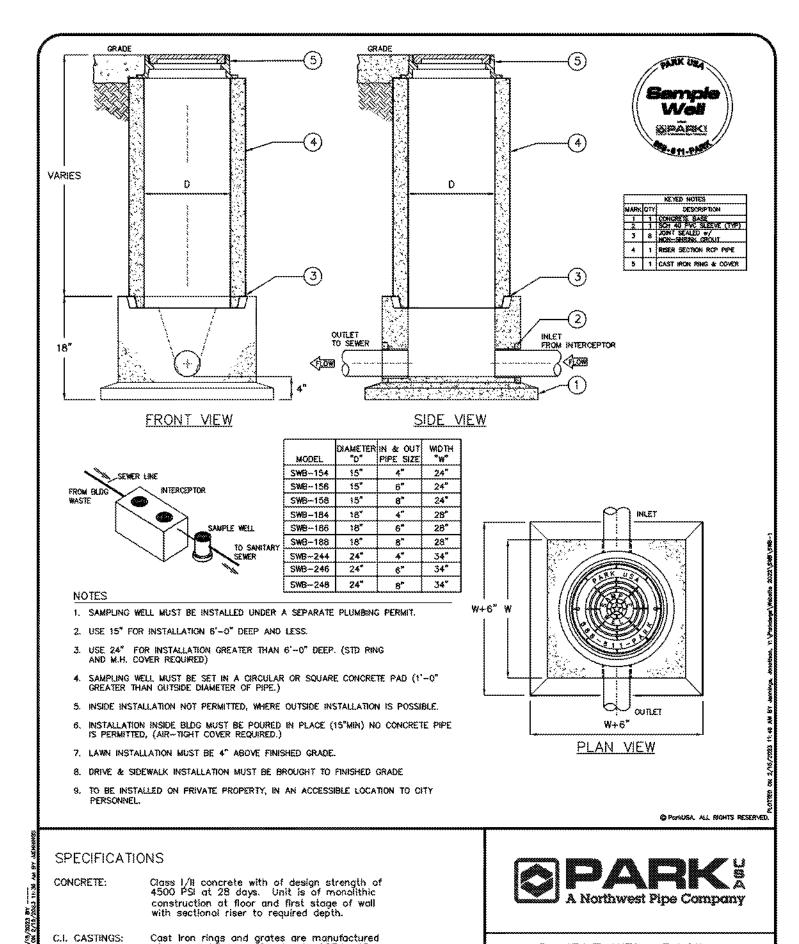

Member CASPE

-FINISHED WALL


CLEANOUT BOX

— CLEANOUT


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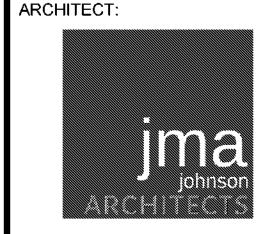
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GREASE INTERCEPTOR (GT-1) SCHEDULE				
CALCULATION AND SIZING DATA				
PEAK MEALS/HOUR: 40 MEALS/HR				
WASTE FLOW RATE: W/O DISHWASHING MACHINE				
RETENTION TIME: SINGLE SERVING KITCHEN				
STORAGE FACTOR: 8 HOURS ————————————————————————————————————				
GREASE OUTPUT (LBS.)= MEALS/HR x WASTE FLOW RATE x RETENTION TIME x STORAGE FACTOR. / QUARTER: = 300 GALLON CAPACITY				
DESCRIPTION/SPECIFICATION				
GREASE INTERCEPTOR SHALL HAVE 75 GPM FLOW CAPACITY AND A MINIMUM OF 1000 GALLON CAPACITY. GREASE INTERCEPTOR SHALL BE EQUAL TO PARK ENVIRONMENTAL GT-1000 AND HAVE 2,300 POUNDS GREASE CAPACITY.				



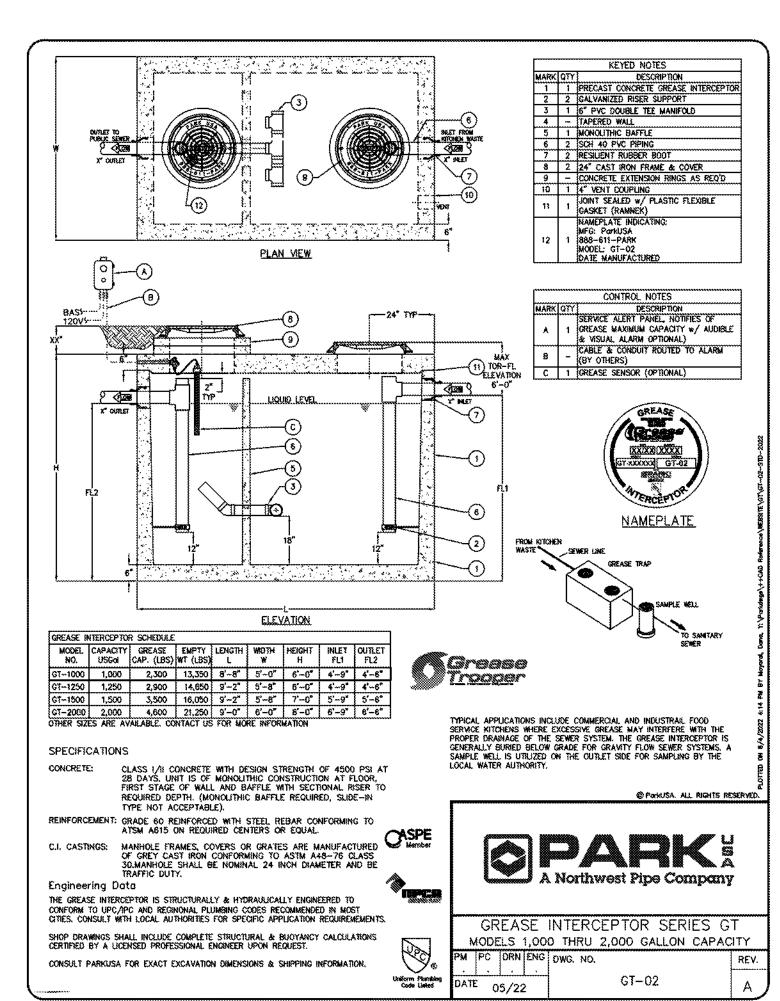

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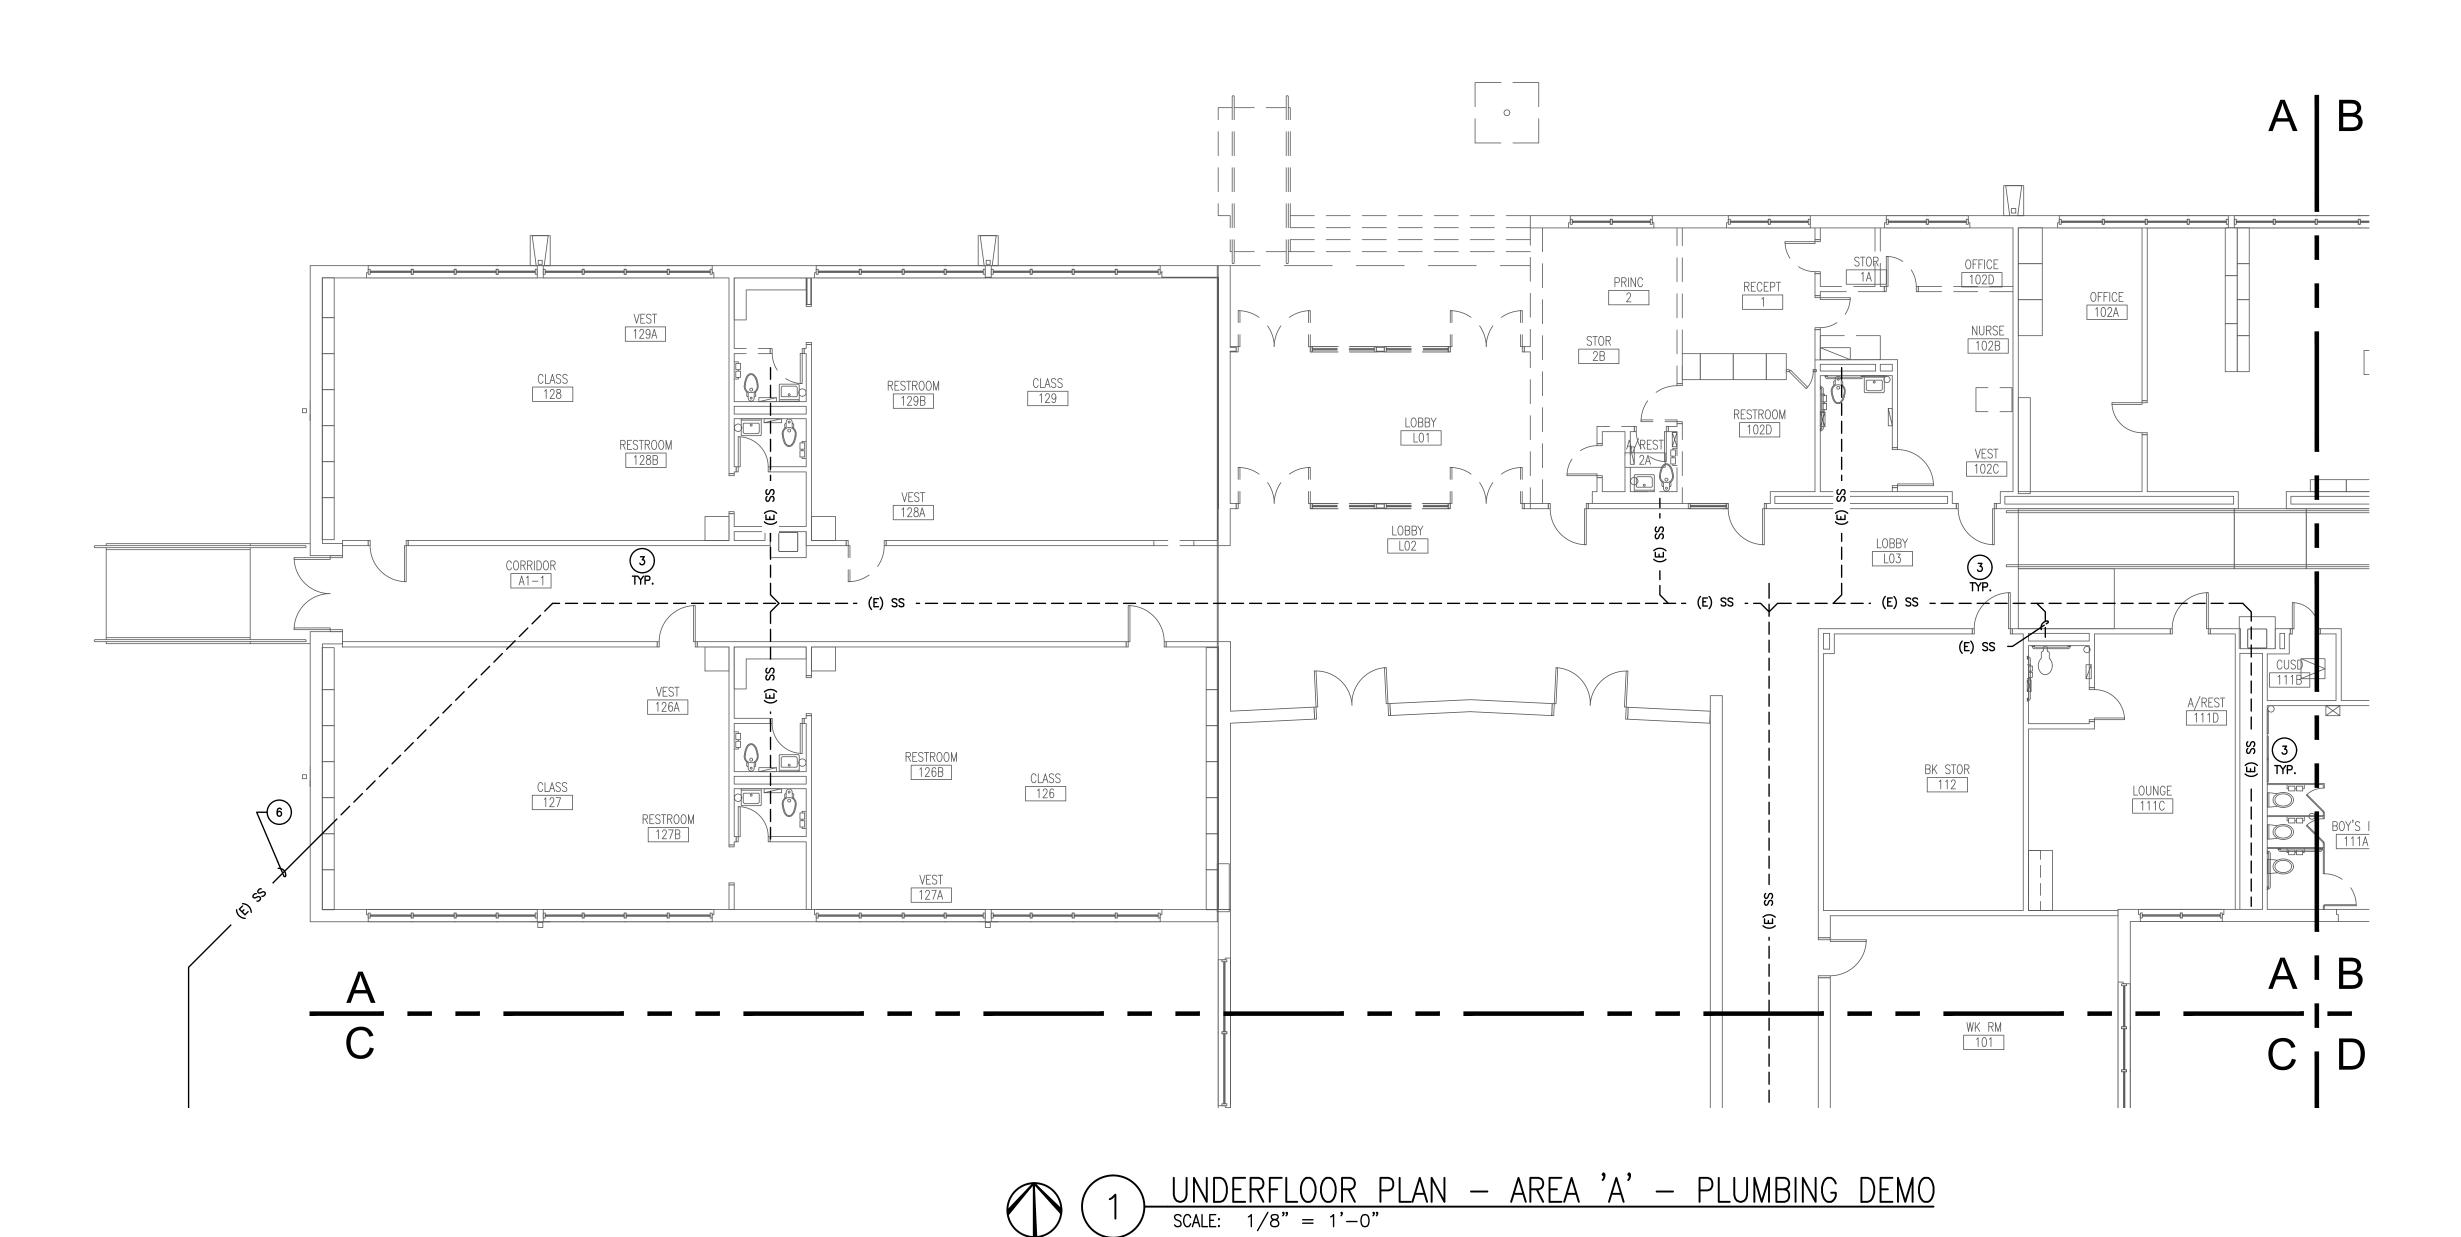
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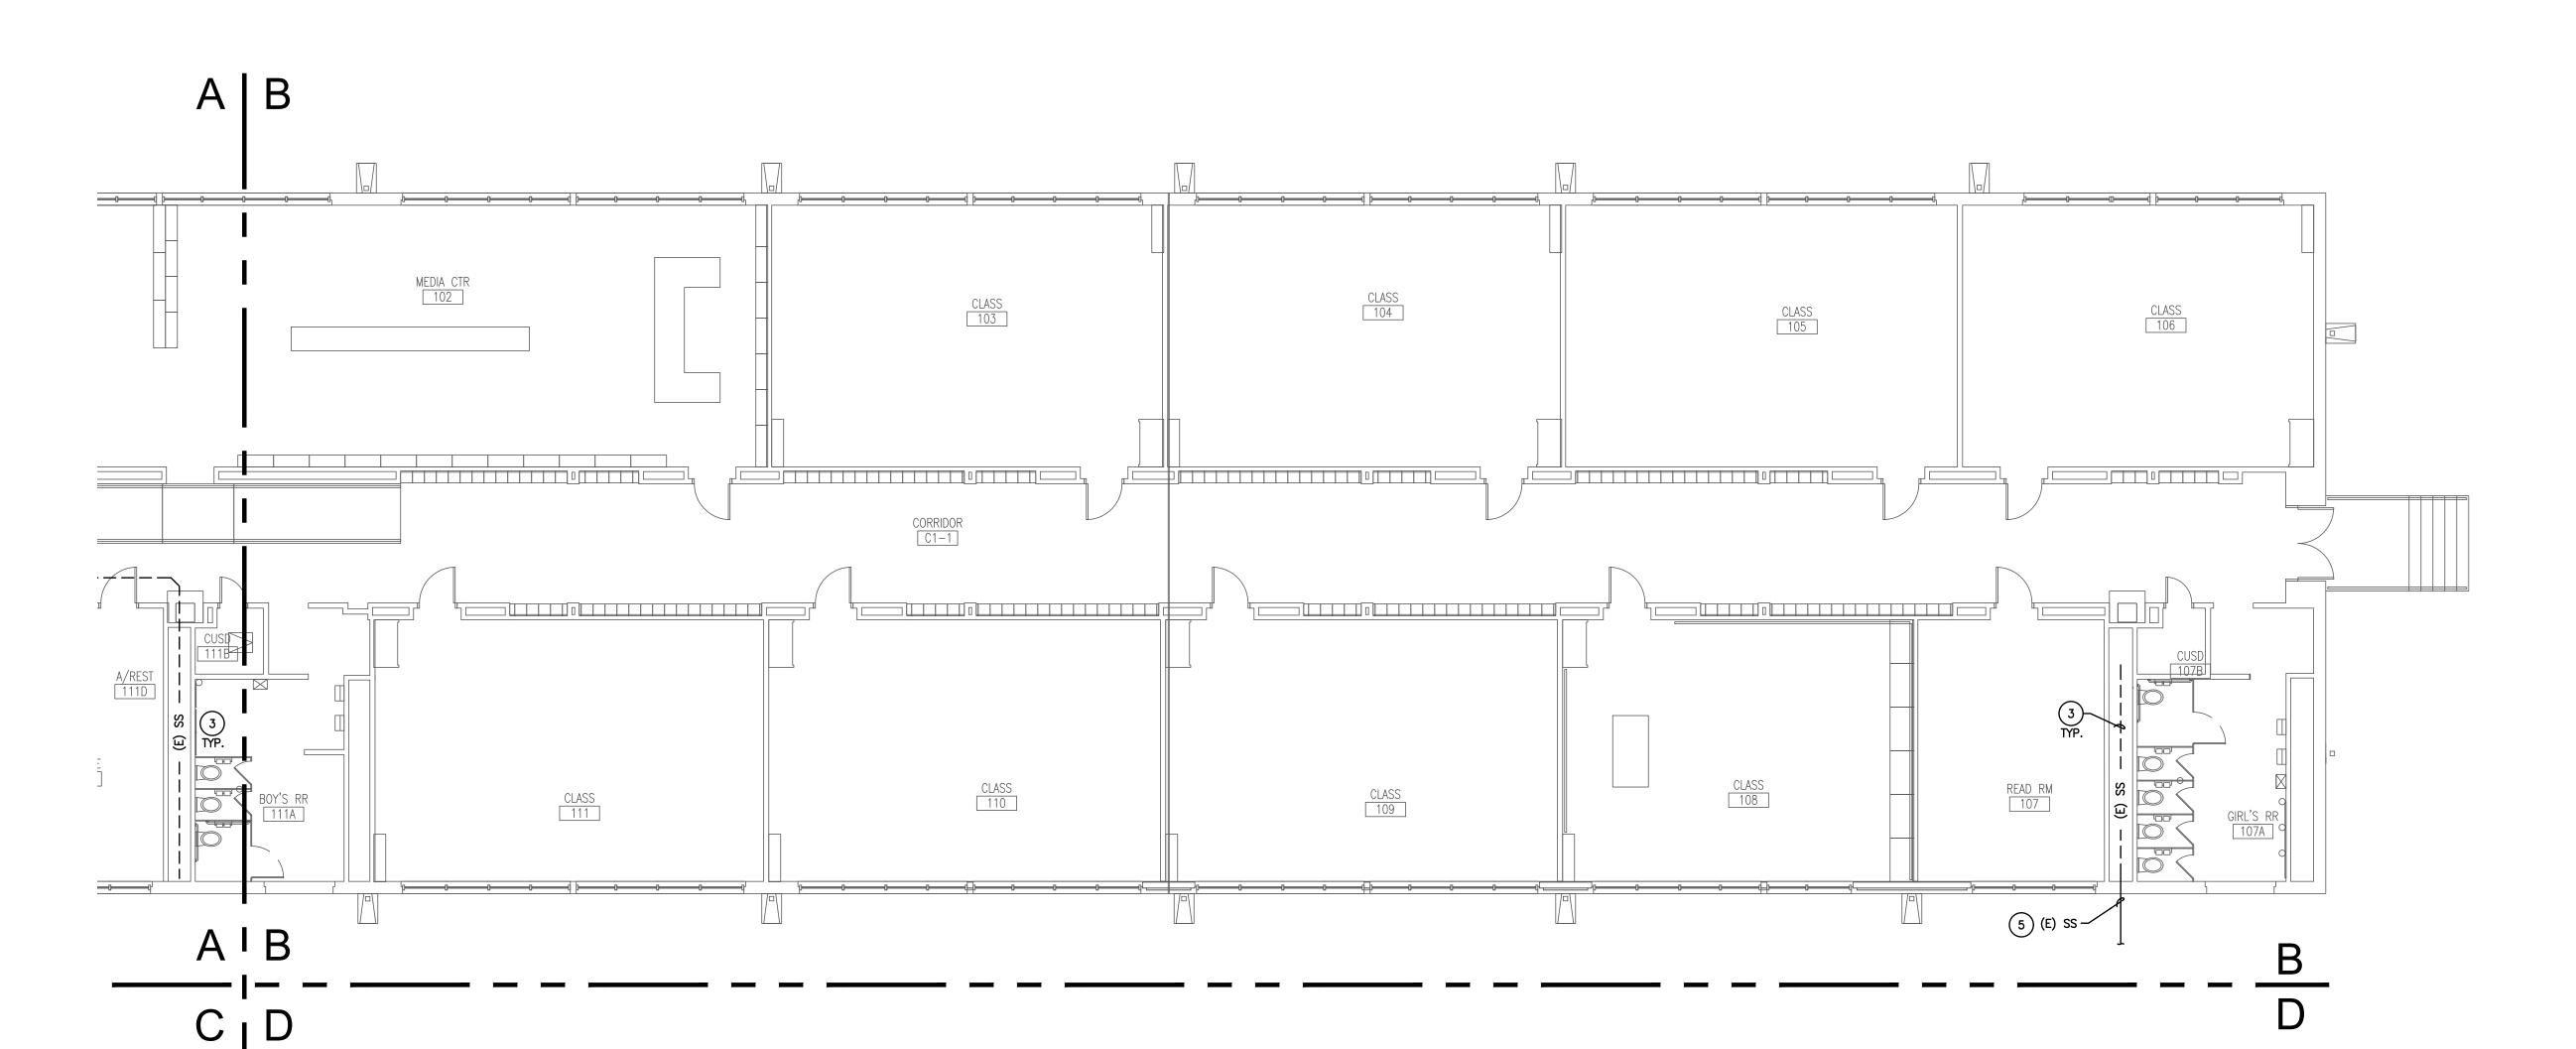
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KEY PLAN


Sheet Title **DETAILS & SCHEDULES**

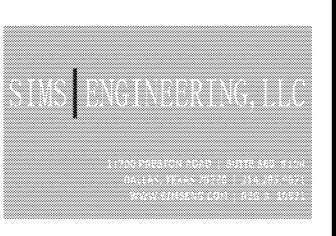



UNDERFLOOR PLAN — AREA 'B' — PLUMBING DEMO

SCALE: 1/8" = 1'-0"

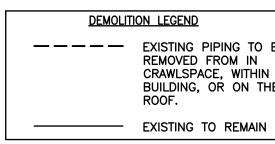

GENERAL PLUMBING NOTES:

- EVERY NOTE INDICATED BY SYMBOL IS NOT NECESSARILY USED ON THIS SHEET.
- 2. CONTRACTOR SHALL PATCH AND FILL ROOF, CEILING, AND WALLS AS
- 3. FOR ALL EXISTING PLUMBING FIXTURES TO REMAIN, CONTRACTOR SHALL DEMO EXISTING DOMESTIC WATER, SEWER AND VENT LINES TO A CONCEALED LOCATION BELOW THE FLOOR OR ABOVE THE CEILING AND PREPARE FIXTURE FOR RECONNECTION TO NEW PIPING WHERE POSSIBLE. WHERE RECONNECTION DIRECTLY TO EXISTING FIXTURE IS
- 4. CONTRACTOR SHALL COORDINATE WITH DISD FOR ANY ABATEMENT NECESSARY IN ASSOCIATION WITH THE WORK SHOWN ON THESE PLANS.

- 3. DEMO EXISTING SANITARY SEWER LINES IN CRAWLSPACE AND
- 6. CAP AND ABANDON EXISTING SEWER LINE BELOW GROUND.

————— EXISTING PIPING TO BE REMOVED FROM IN CRAWLSPACE, WITHIN THE BUILDING, OR ON THE ROOF.

- NOT POSSIBLE WITHOUT DESTRUCTION OF WALLS AND FLOOR, THE CONTRACTOR MAY LEAVE THE INACCESSIBLE PORTION OF THE EXISTING LINES TO RECONNECT TO NEW SYSTEMS. ANY ABANDONED PIPE SHALL BE CAPPED.
- 1. REMOVE EXISTING GREASE INTERCEPTOR.
- 2. REMOVE EXISTING SAMPLE WELL.
- CAP EXISTING LINE WHERE LINE ROUTES BELOW GROUND.
- 4. DEMO EXISTING GREASE WASTE LINE.
- 5. EXISTING SANITARY SEWER LINE SHALL REMAIN.

ARCHITECT:

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CONSULTANT:

<u>CONSTRUCTION</u>

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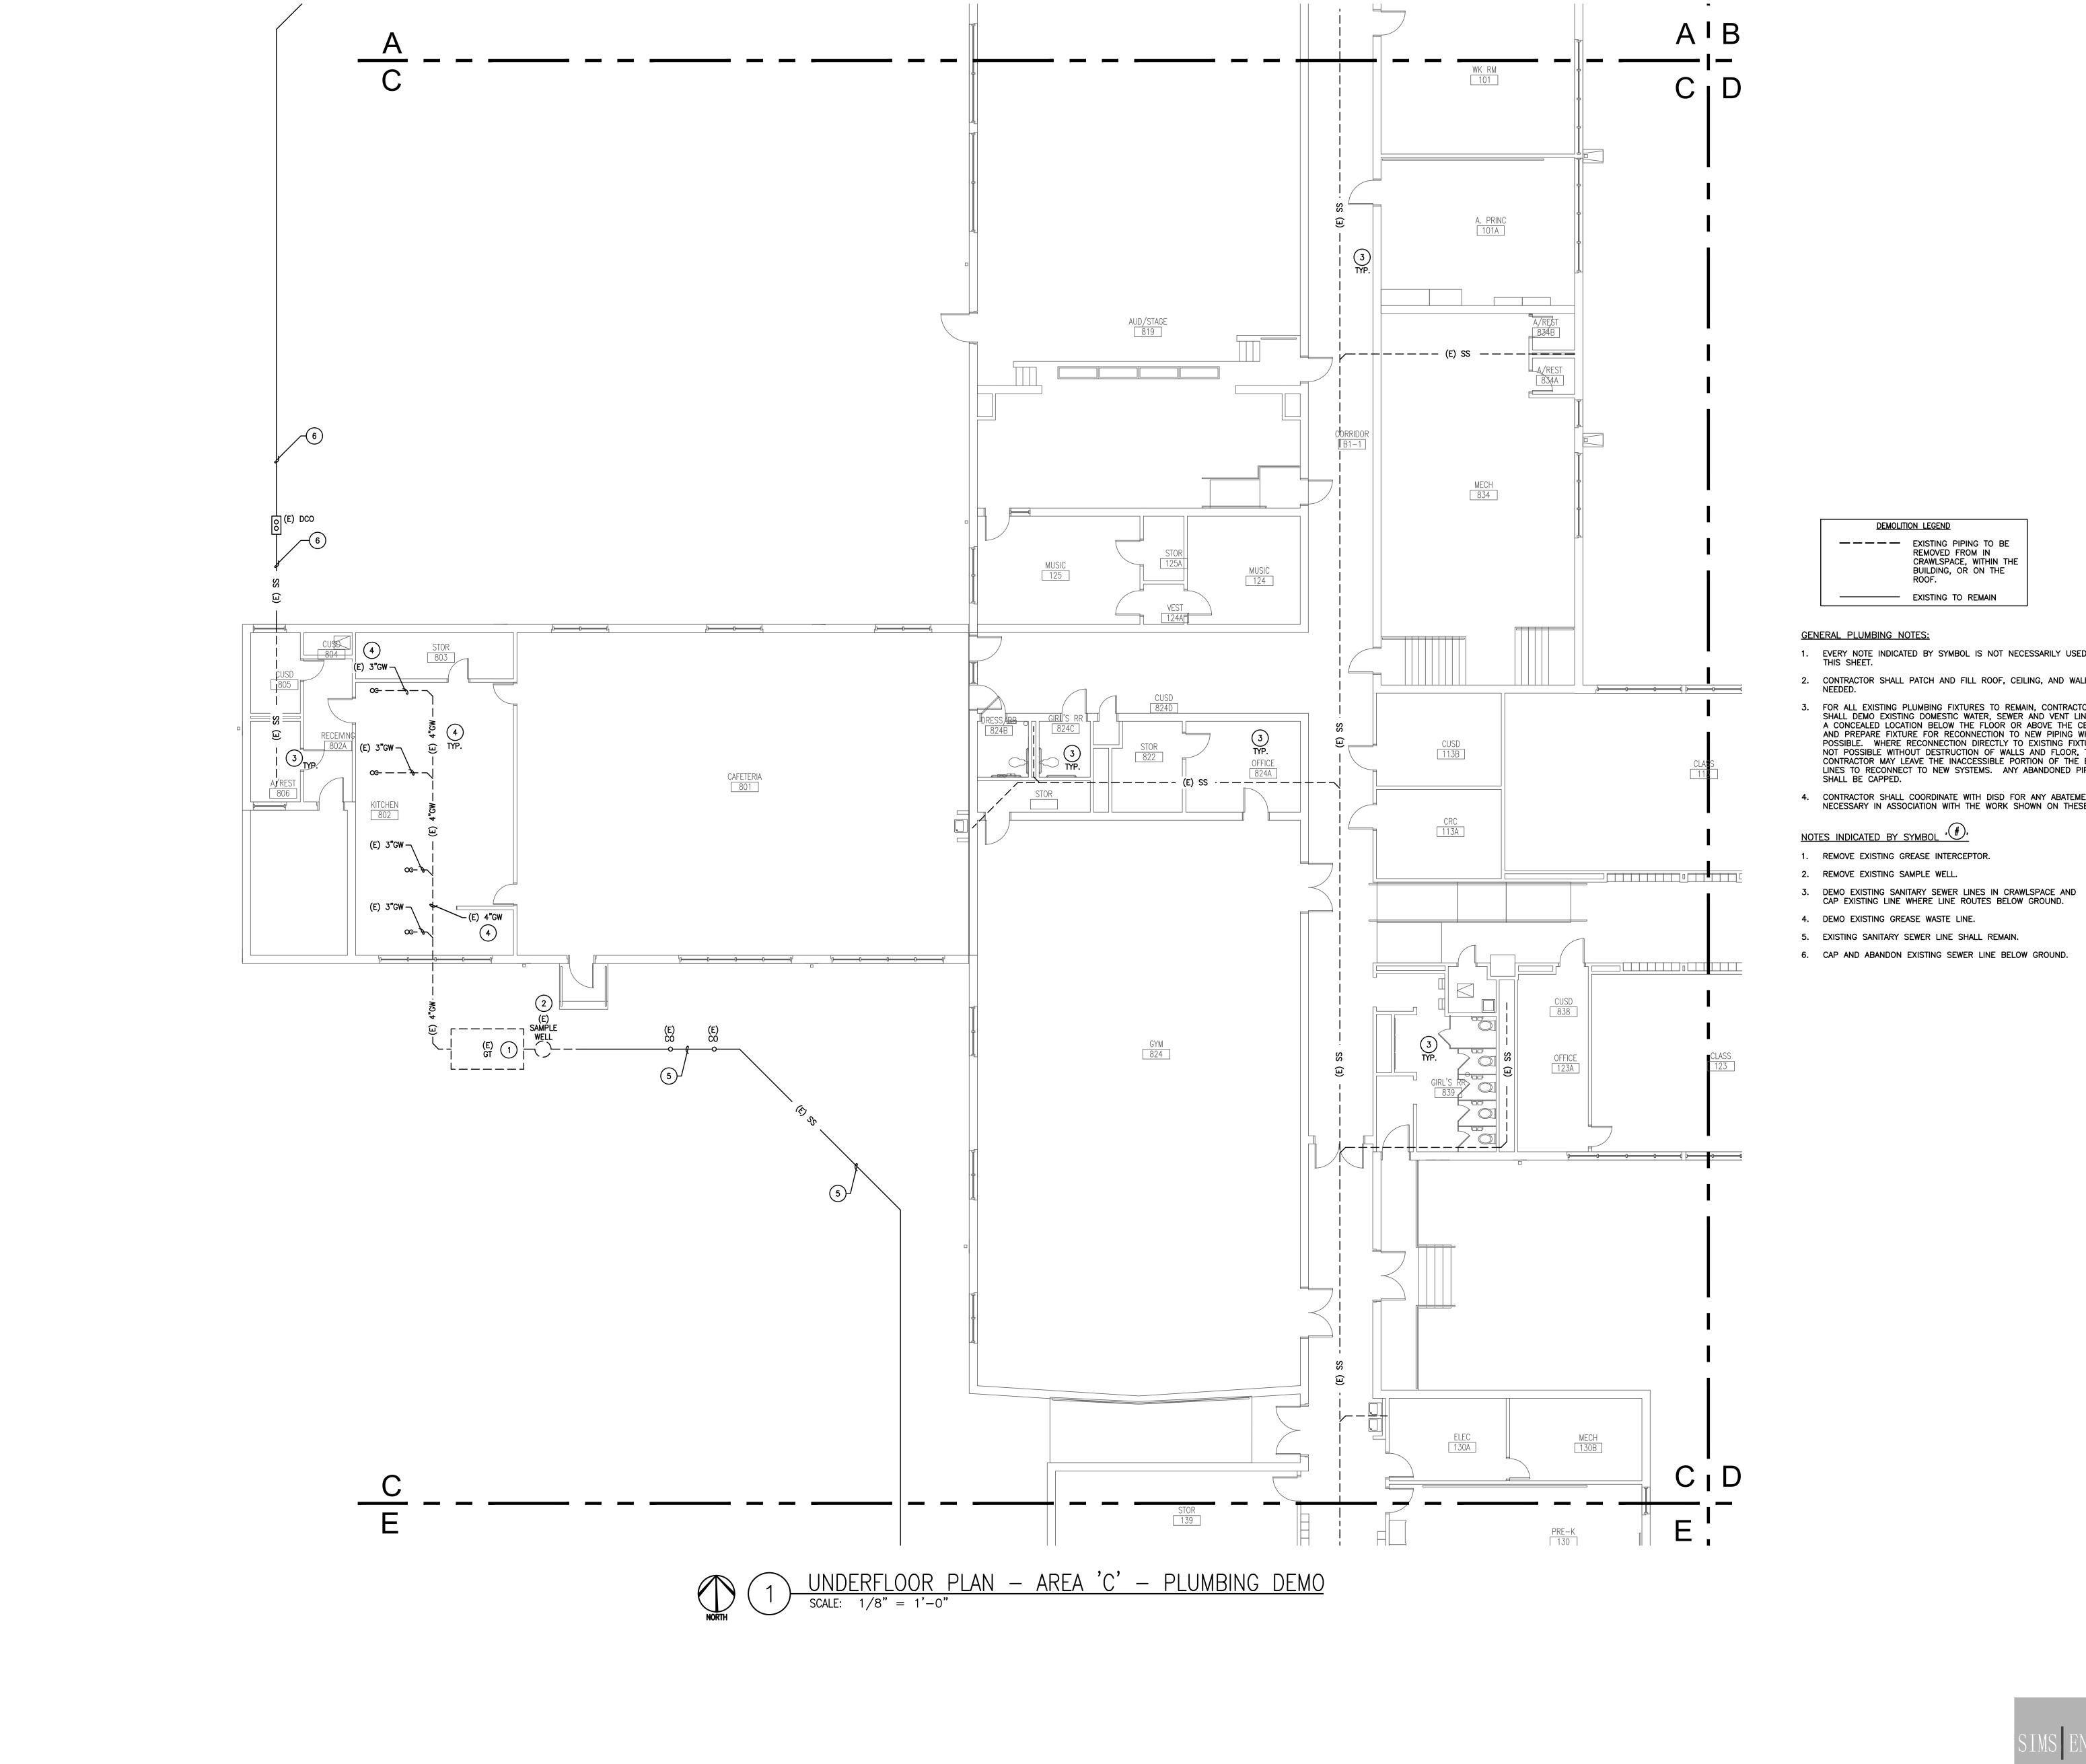
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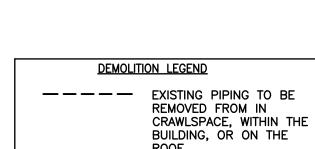
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UNDERFLOOR PLAN PLUMBING DEMO

Sheet Number





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- 2. CONTRACTOR SHALL PATCH AND FILL ROOF, CEILING, AND WALLS AS
- 3. FOR ALL EXISTING PLUMBING FIXTURES TO REMAIN, CONTRACTOR SHALL DEMO EXISTING DOMESTIC WATER, SEWER AND VENT LINES TO A CONCEALED LOCATION BELOW THE FLOOR OR ABOVE THE CEILING AND PREPARE FIXTURE FOR RECONNECTION TO NEW PIPING WHERE POSSIBLE. WHERE RECONNECTION DIRECTLY TO EXISTING FIXTURE IS NOT POSSIBLE WITHOUT DESTRUCTION OF WALLS AND FLOOR, THE CONTRACTOR MAY LEAVE THE INACCESSIBLE PORTION OF THE EXISTING LINES TO RECONNECT TO NEW SYSTEMS. ANY ABANDONED PIPE
- 4. CONTRACTOR SHALL COORDINATE WITH DISD FOR ANY ABATEMENT NECESSARY IN ASSOCIATION WITH THE WORK SHOWN ON THESE PLANS.
- 6. CAP AND ABANDON EXISTING SEWER LINE BELOW GROUND.

ARCHITECT:

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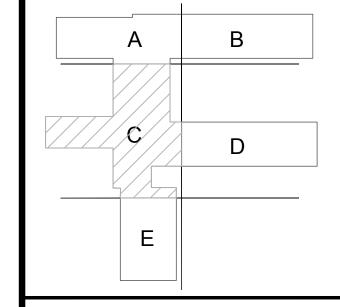
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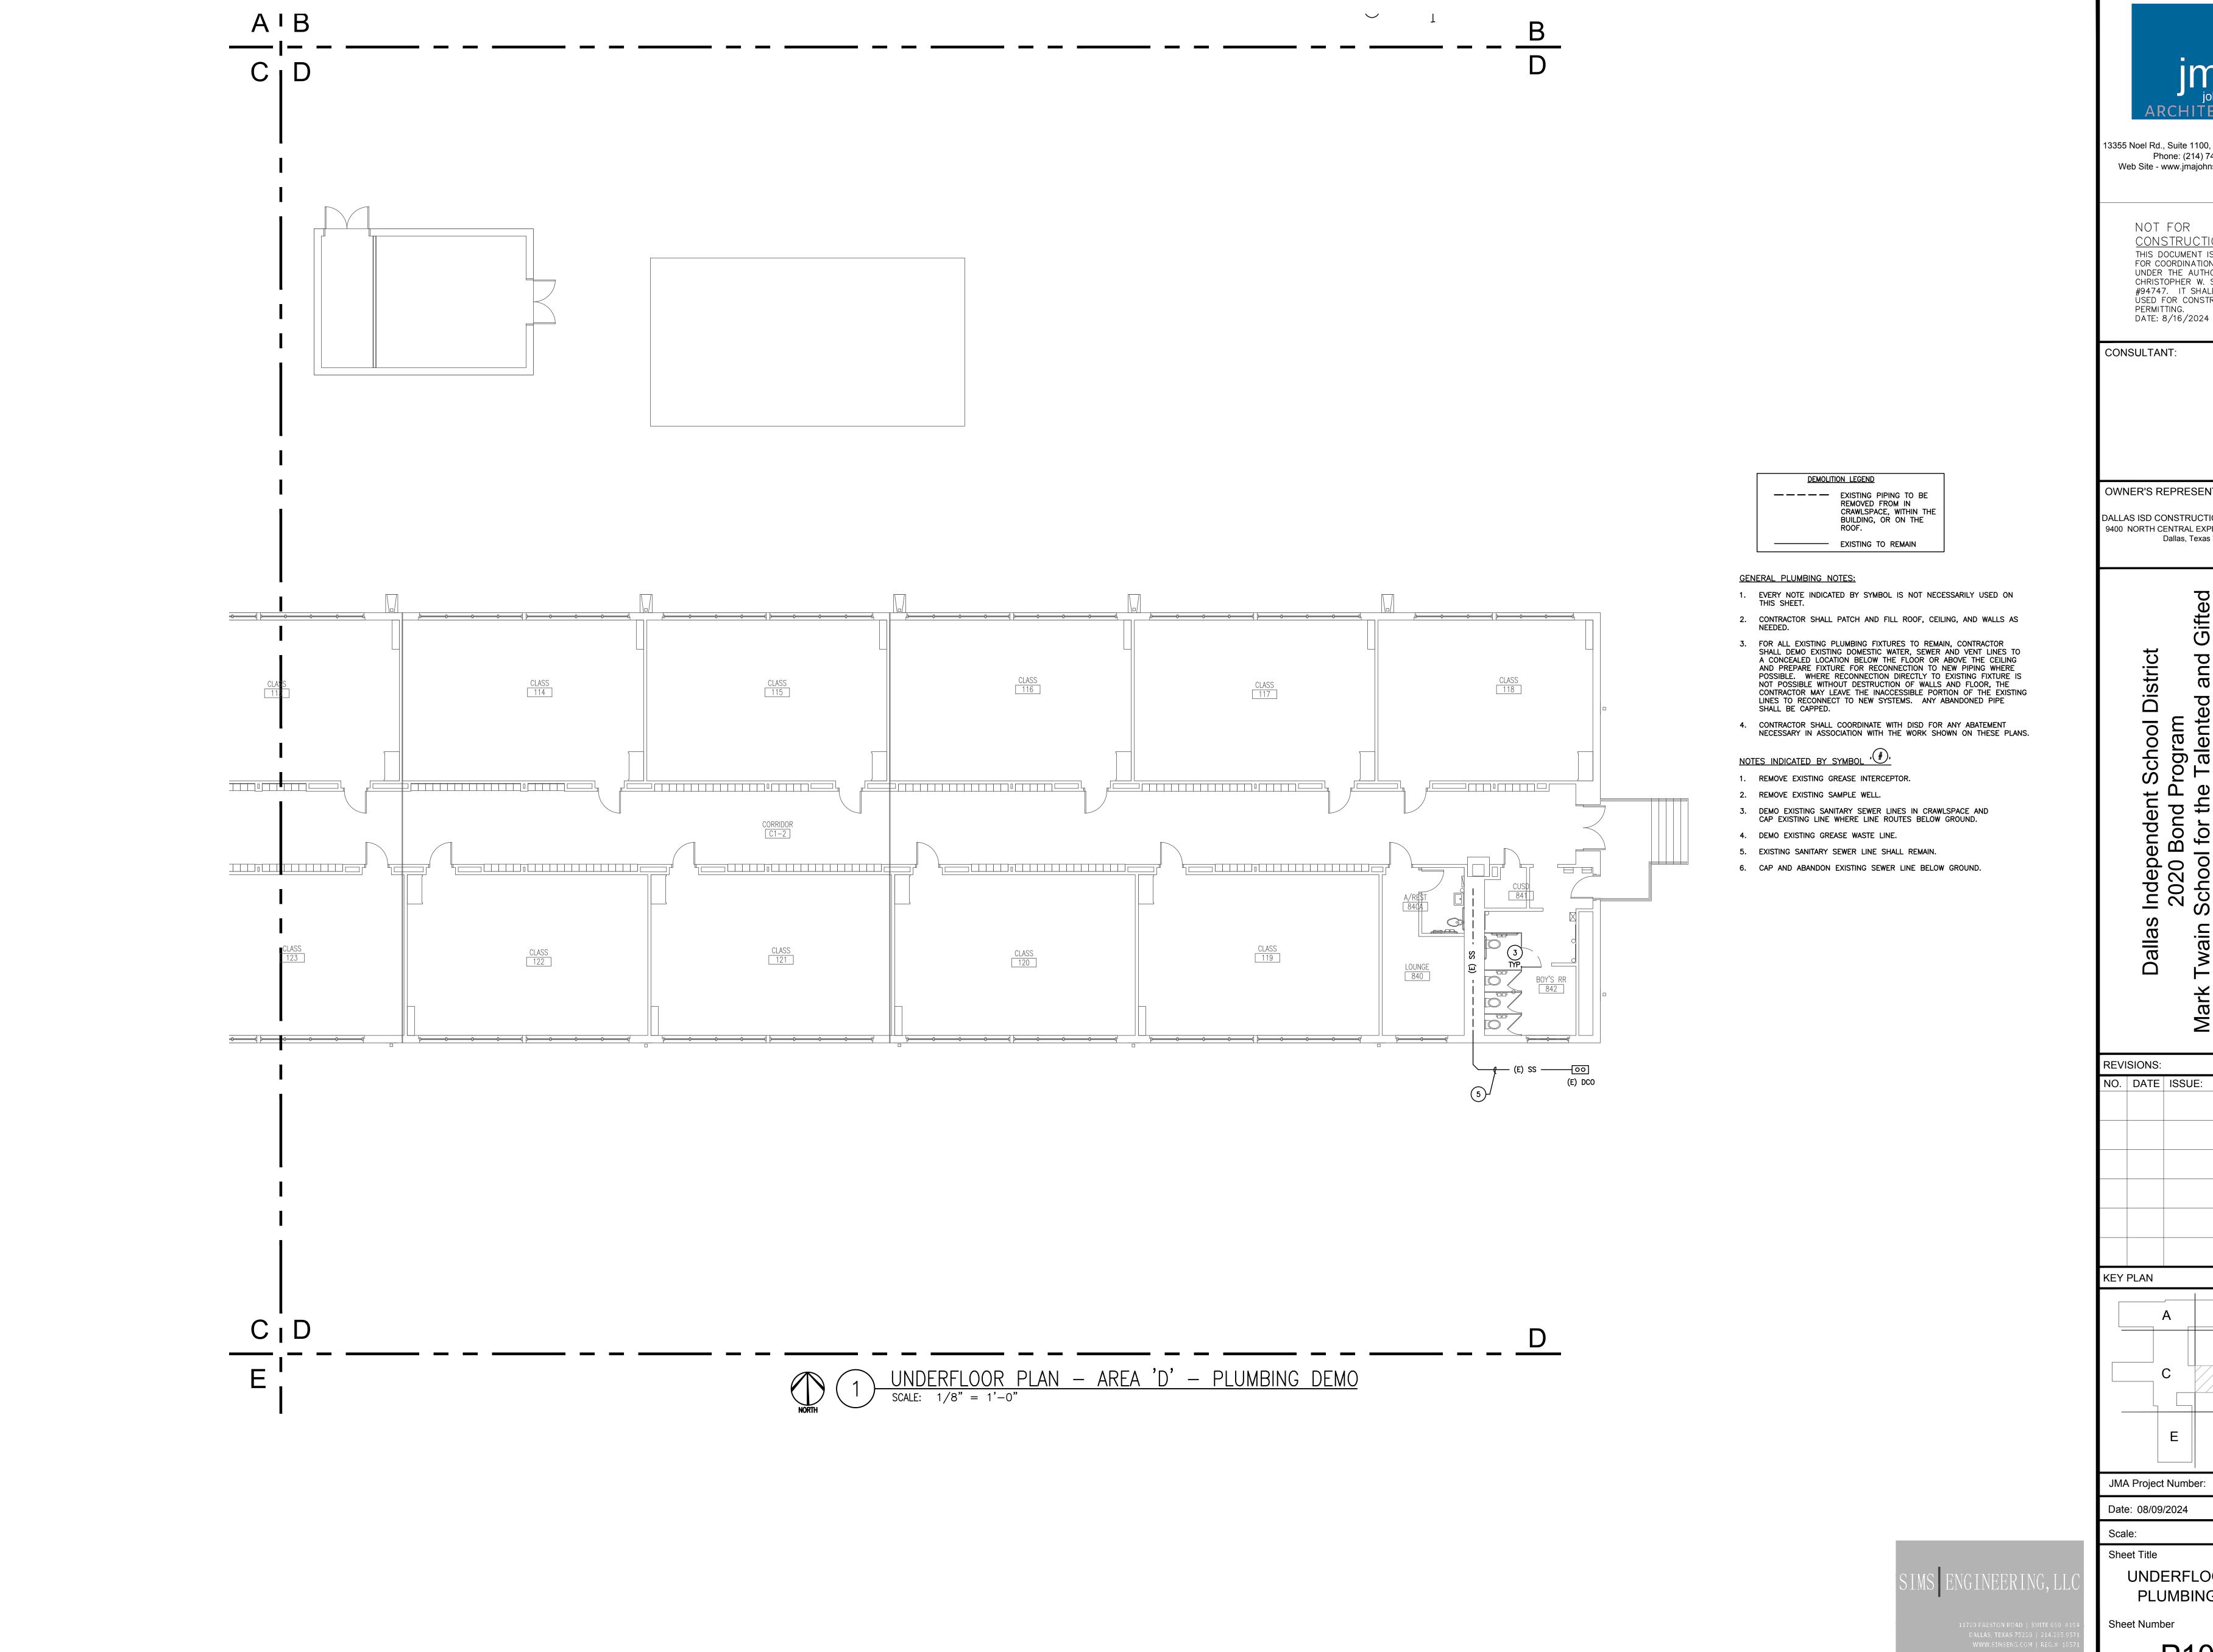
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UNDERFLOOR PLAN PLUMBING DEMO





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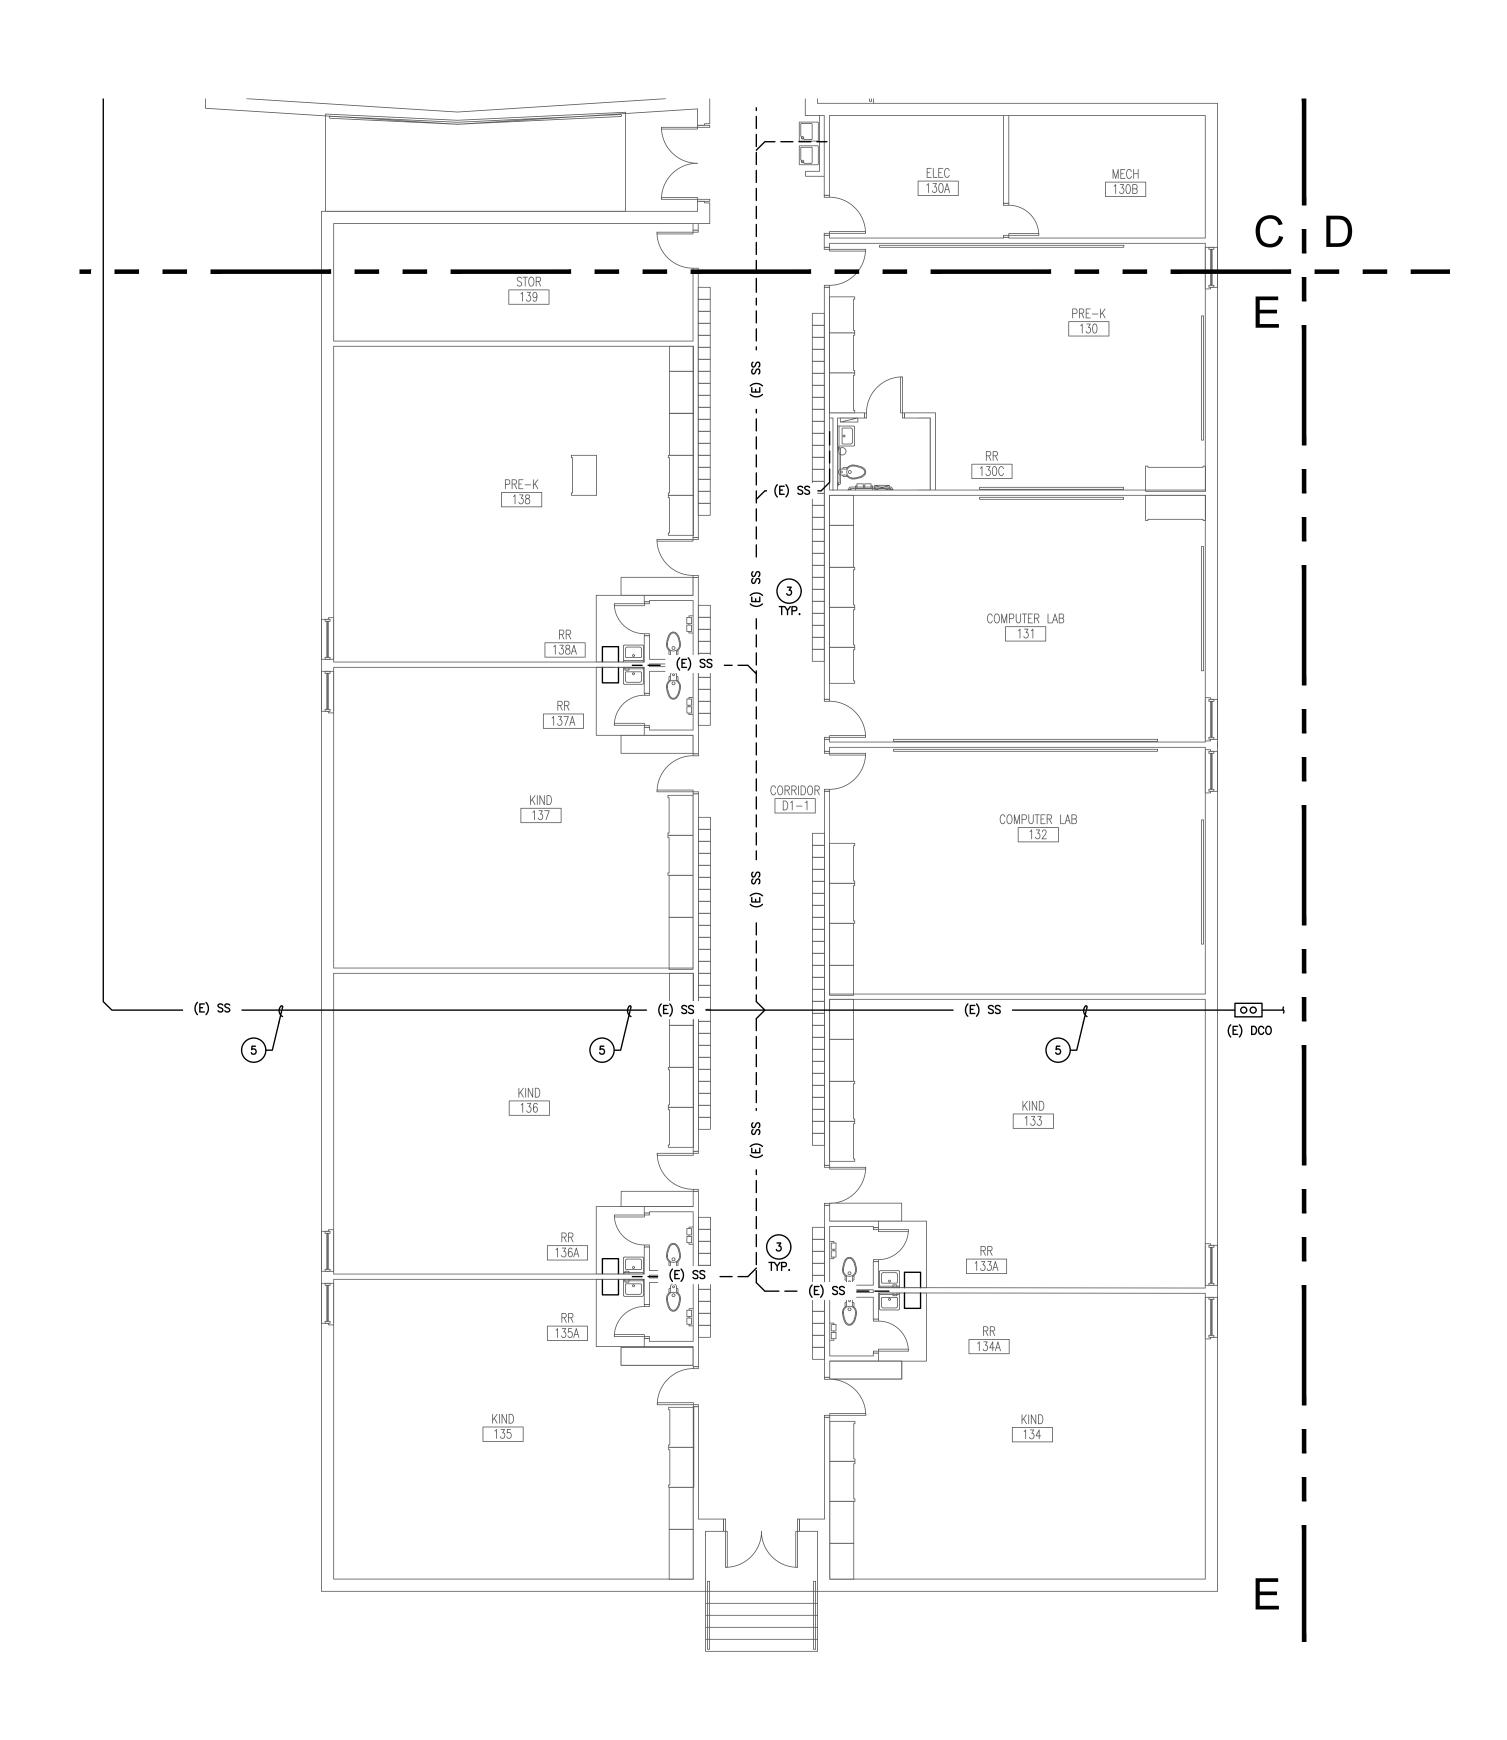
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UNDERFLOOR PLAN PLUMBING DEMO



DEMOLITION LEGEND ----- EXISTING TO REMAIN

GENERAL PLUMBING NOTES:

- EVERY NOTE INDICATED BY SYMBOL IS NOT NECESSARILY USED ON THIS SHEET.
- 2. CONTRACTOR SHALL PATCH AND FILL ROOF, CEILING, AND WALLS AS NEEDED.
- 3. FOR ALL EXISTING PLUMBING FIXTURES TO REMAIN, CONTRACTOR SHALL DEMO EXISTING DOMESTIC WATER, SEWER AND VENT LINES TO SHALL DEMO EXISTING DOMESTIC WATER, SEWER AND VENT LINES TO A CONCEALED LOCATION BELOW THE FLOOR OR ABOVE THE CEILING AND PREPARE FIXTURE FOR RECONNECTION TO NEW PIPING WHERE POSSIBLE. WHERE RECONNECTION DIRECTLY TO EXISTING FIXTURE IS NOT POSSIBLE WITHOUT DESTRUCTION OF WALLS AND FLOOR, THE CONTRACTOR MAY LEAVE THE INACCESSIBLE PORTION OF THE EXISTING LINES TO RECONNECT TO NEW SYSTEMS. ANY ABANDONED PIPE SHALL BE CAPPED.
- 4. CONTRACTOR SHALL COORDINATE WITH DISD FOR ANY ABATEMENT NECESSARY IN ASSOCIATION WITH THE WORK SHOWN ON THESE PLANS.

NOTES INDICATED BY SYMBOL ,#,

- 1. REMOVE EXISTING GREASE INTERCEPTOR.
- 2. REMOVE EXISTING SAMPLE WELL.
- DEMO EXISTING SANITARY SEWER LINES IN CRAWLSPACE AND CAP EXISTING LINE WHERE LINE ROUTES BELOW GROUND.
- 4. DEMO EXISTING GREASE WASTE LINE.
- 5. EXISTING SANITARY SEWER LINE SHALL REMAIN.
- 6. CAP AND ABANDON EXISTING SEWER LINE BELOW GROUND.

————— EXISTING PIPING TO BE REMOVED FROM IN CRAWLSPACE, WITHIN THE BUILDING, OR ON THE ROOF.

OWNER'S REPRESENTATIVE:

CONSULTANT:

ARCHITECT:

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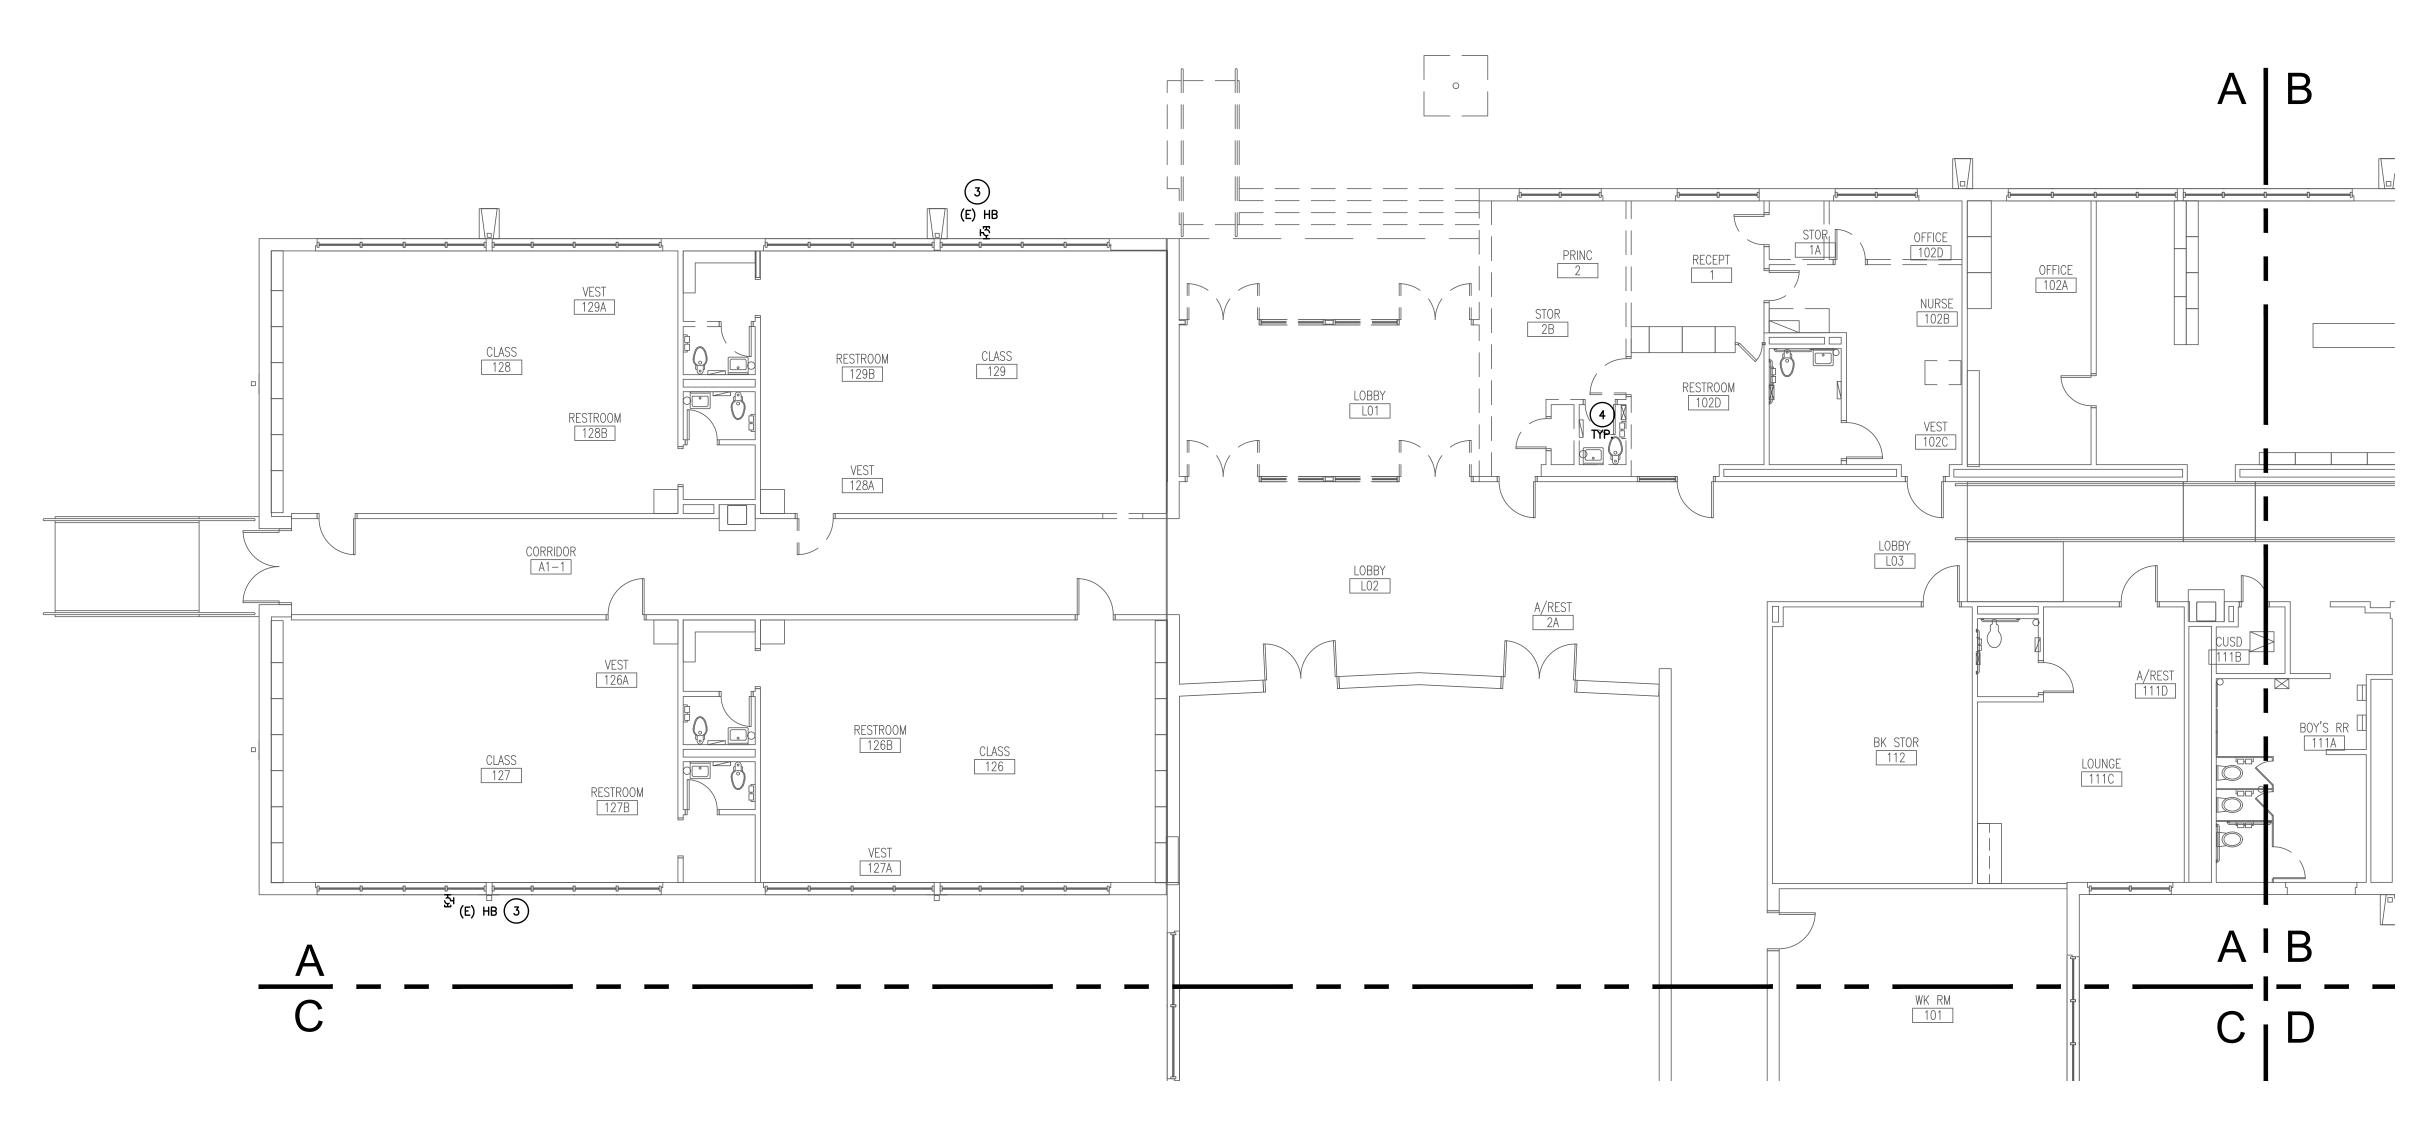
Sheet Title

UNDERFLOOR PLAN PLUMBING DEMO

P104


UNDERFLOOR PLAN — AREA 'E' — PLUMBING DEMO


SCALE: 1/8" = 1'-0"



FLOOR PLAN — AREA 'A' — PLUMBING DEMO

SCALE: 1/8" = 1'-0"

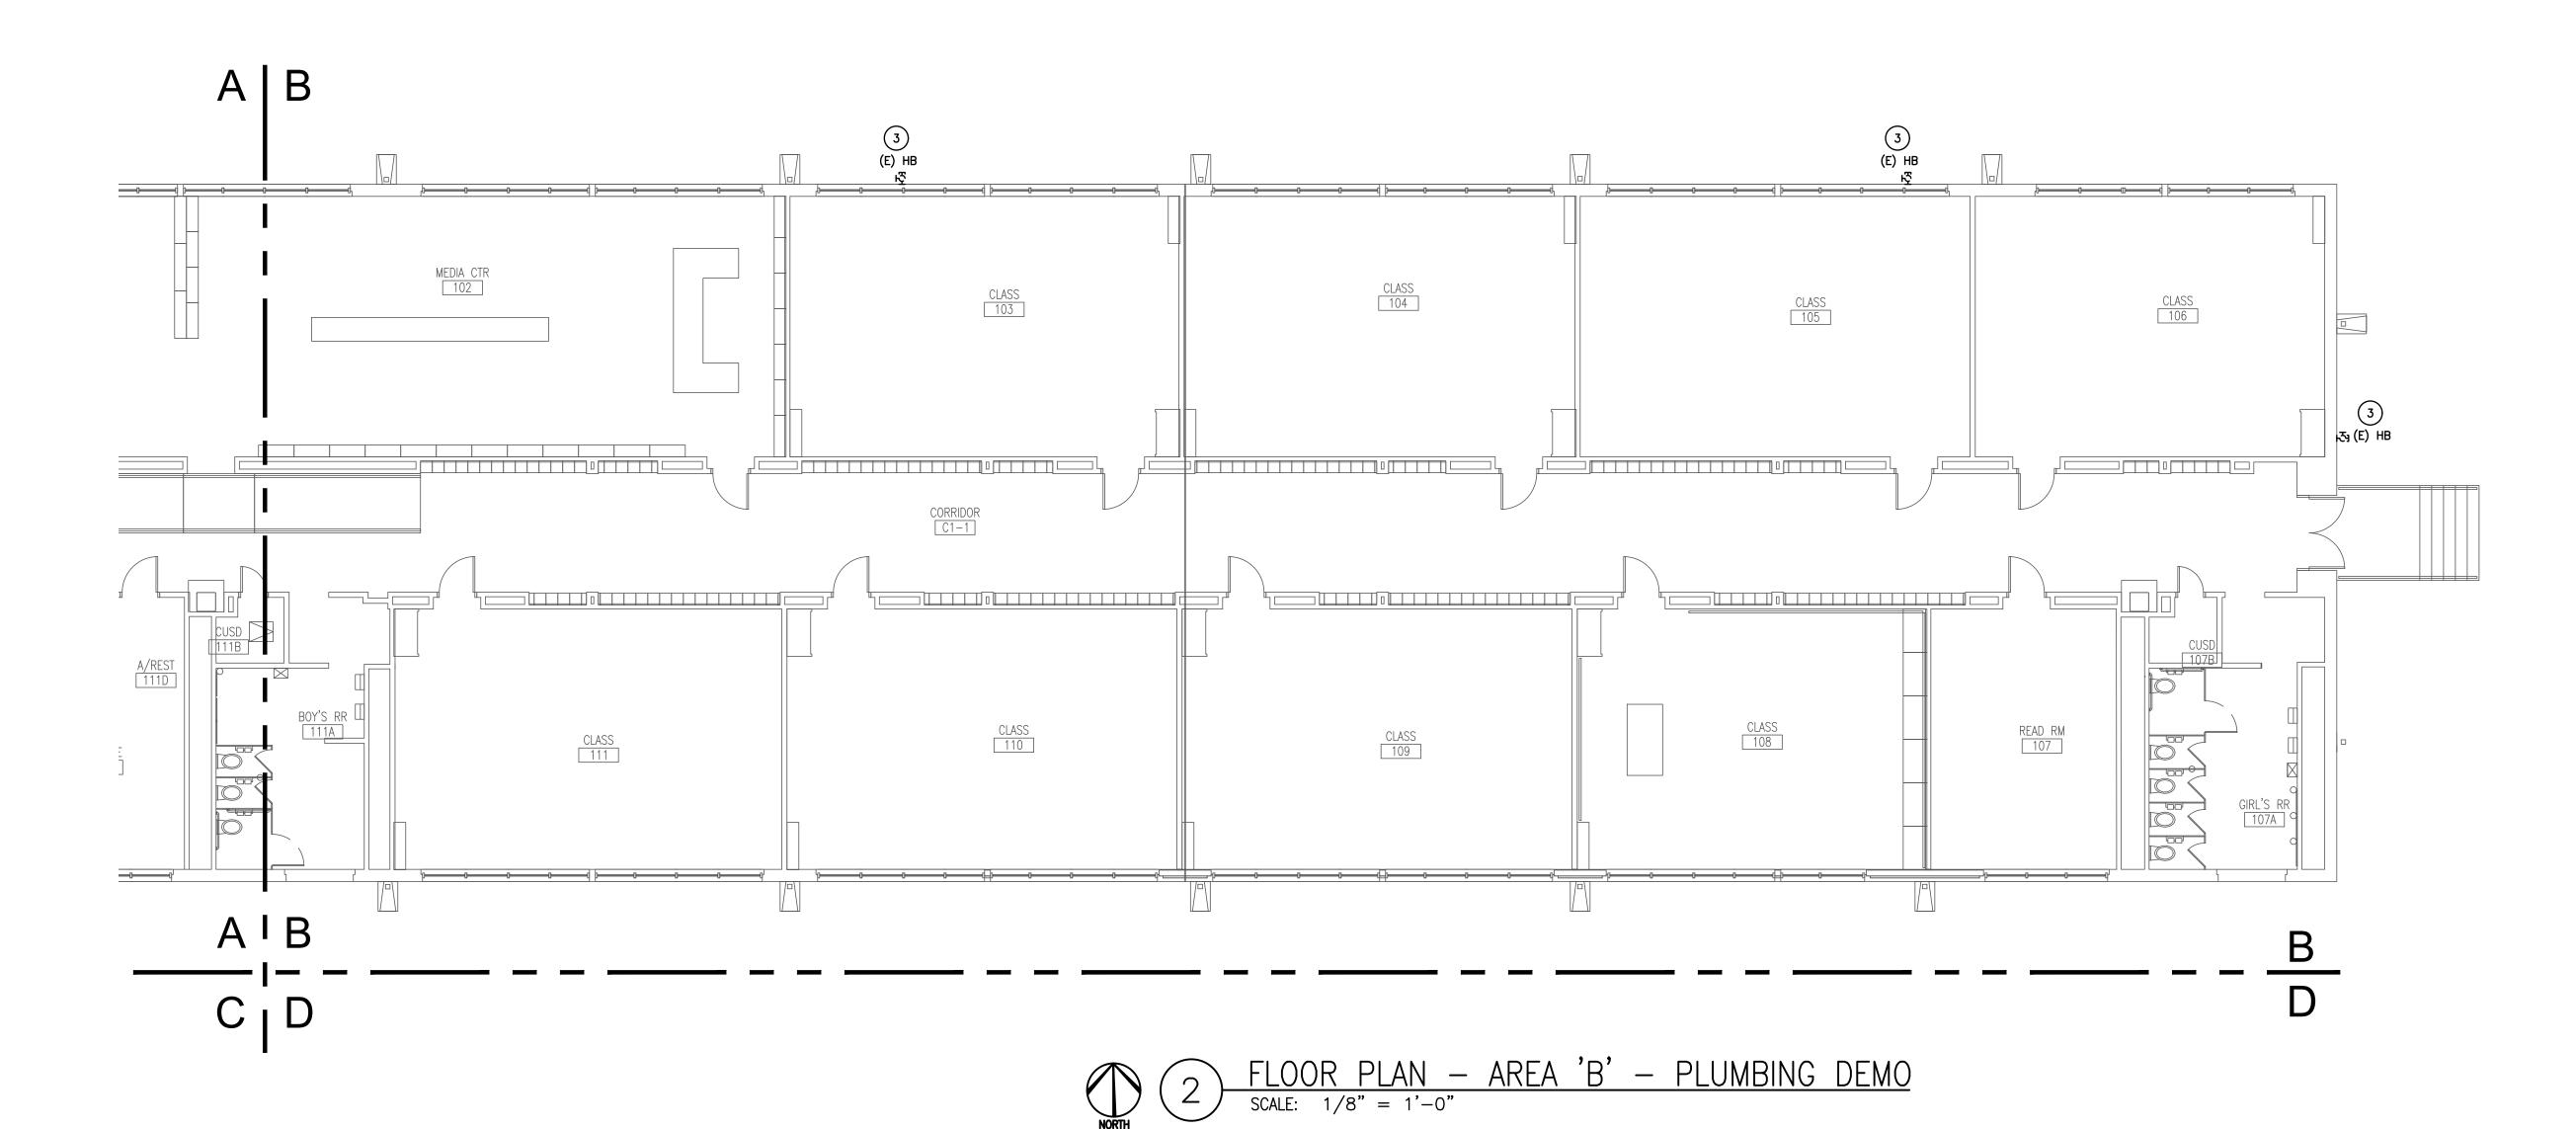

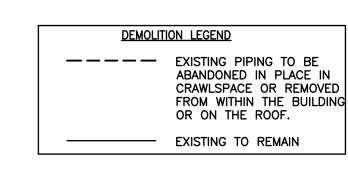

GENERAL PLUMBING NOTES:

- 1. EVERY KEYED NOTE IS NOT NECESSARILY USED ON THIS SHEET.
- CONTRACTOR SHALL PATCH AND FILL ROOF, CEILING, AND WALLS AS NEEDED.
- 3. ALL EXISTING PLUMBING FIXTURES REMAINING AFTER DEMO SHALL BE RECONNECTED TO DOMESTIC WATER, VENT AND SEWER AS NEED WHETHER OR NOT THE FIXTURE IS INDICATED ON THIS SET OF PLANS.
- 4. ALL GAS PIPING SHALL BE PAINTED YELLOW.
- 5. CONTRACTOR SHALL PROVIDE ANY ABATEMENT NECESSARY IN ASSOCIATION WITH THE WORK SHOWN ON THESE PLANS AND PER THE ASBESTOS SURVEY THAT IS A PART OF THE CONTRACT DOCUMENTS IN DIVISION 0.

NOTES INDICATED BY SYMBOL , #,

. REMOVE TWO EXISTING HOT WATER STORAGE TANKS AND METAL RACK SUPPORTING THE TANKS. DEMO ASSOCIATED HOT WATER PIPING TO THE POINT WHERE IT EXISTING THE BOILER ROOM AND PREPARE FOR CONNECTION TO NEW PIPING PER THE P2.X SERIES PLANS.

2. REMOVE EXISTING FLOOR SINK OR FLOOR DRAIN.

EXISTING GAS LINE AT THIS LOCATION.

- 3. REMOVE EXISTING HOSE BIBB. PREPARE EXISTING CW LINE FOR RECONNECTION TO NEW NON-FREEZE WALL HYDRANT. REFER TO P2XX SERIES FOR LOCATION.
- DEMO EXISTING PLUMBING FIXTURE. DEMO EXISTING PLUMBING LINES TO A CONCEALED LOCATION ABOVE CEILING OR BELOW FINISHED FLOOR AND CAP.
- 5. DEMO EXISTING LOCHINVAR DOMESTIC HOT WATER BOILER.
 DEMO ASSOCIATED PUMPS, MIXING VALVE, AND HOT WATER
- PIPING TO THE POINT WHERE THE PIPING EXISTING THE BOILER ROOM. PREPARE EXISTING HOT WATER PIPING AND GAS LINE FOR CONNECTION TO NEW PIPING PER THE P2.X SERIES PLANS.

 6. EXISTING BOILER AT THIS APPROXIMATE LOCATION IS BEING DEMO'ED AS A PART OF THE MECHANICAL SCOPE. CAP

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724 Green Cove Lane - Dallas, Texas 75232

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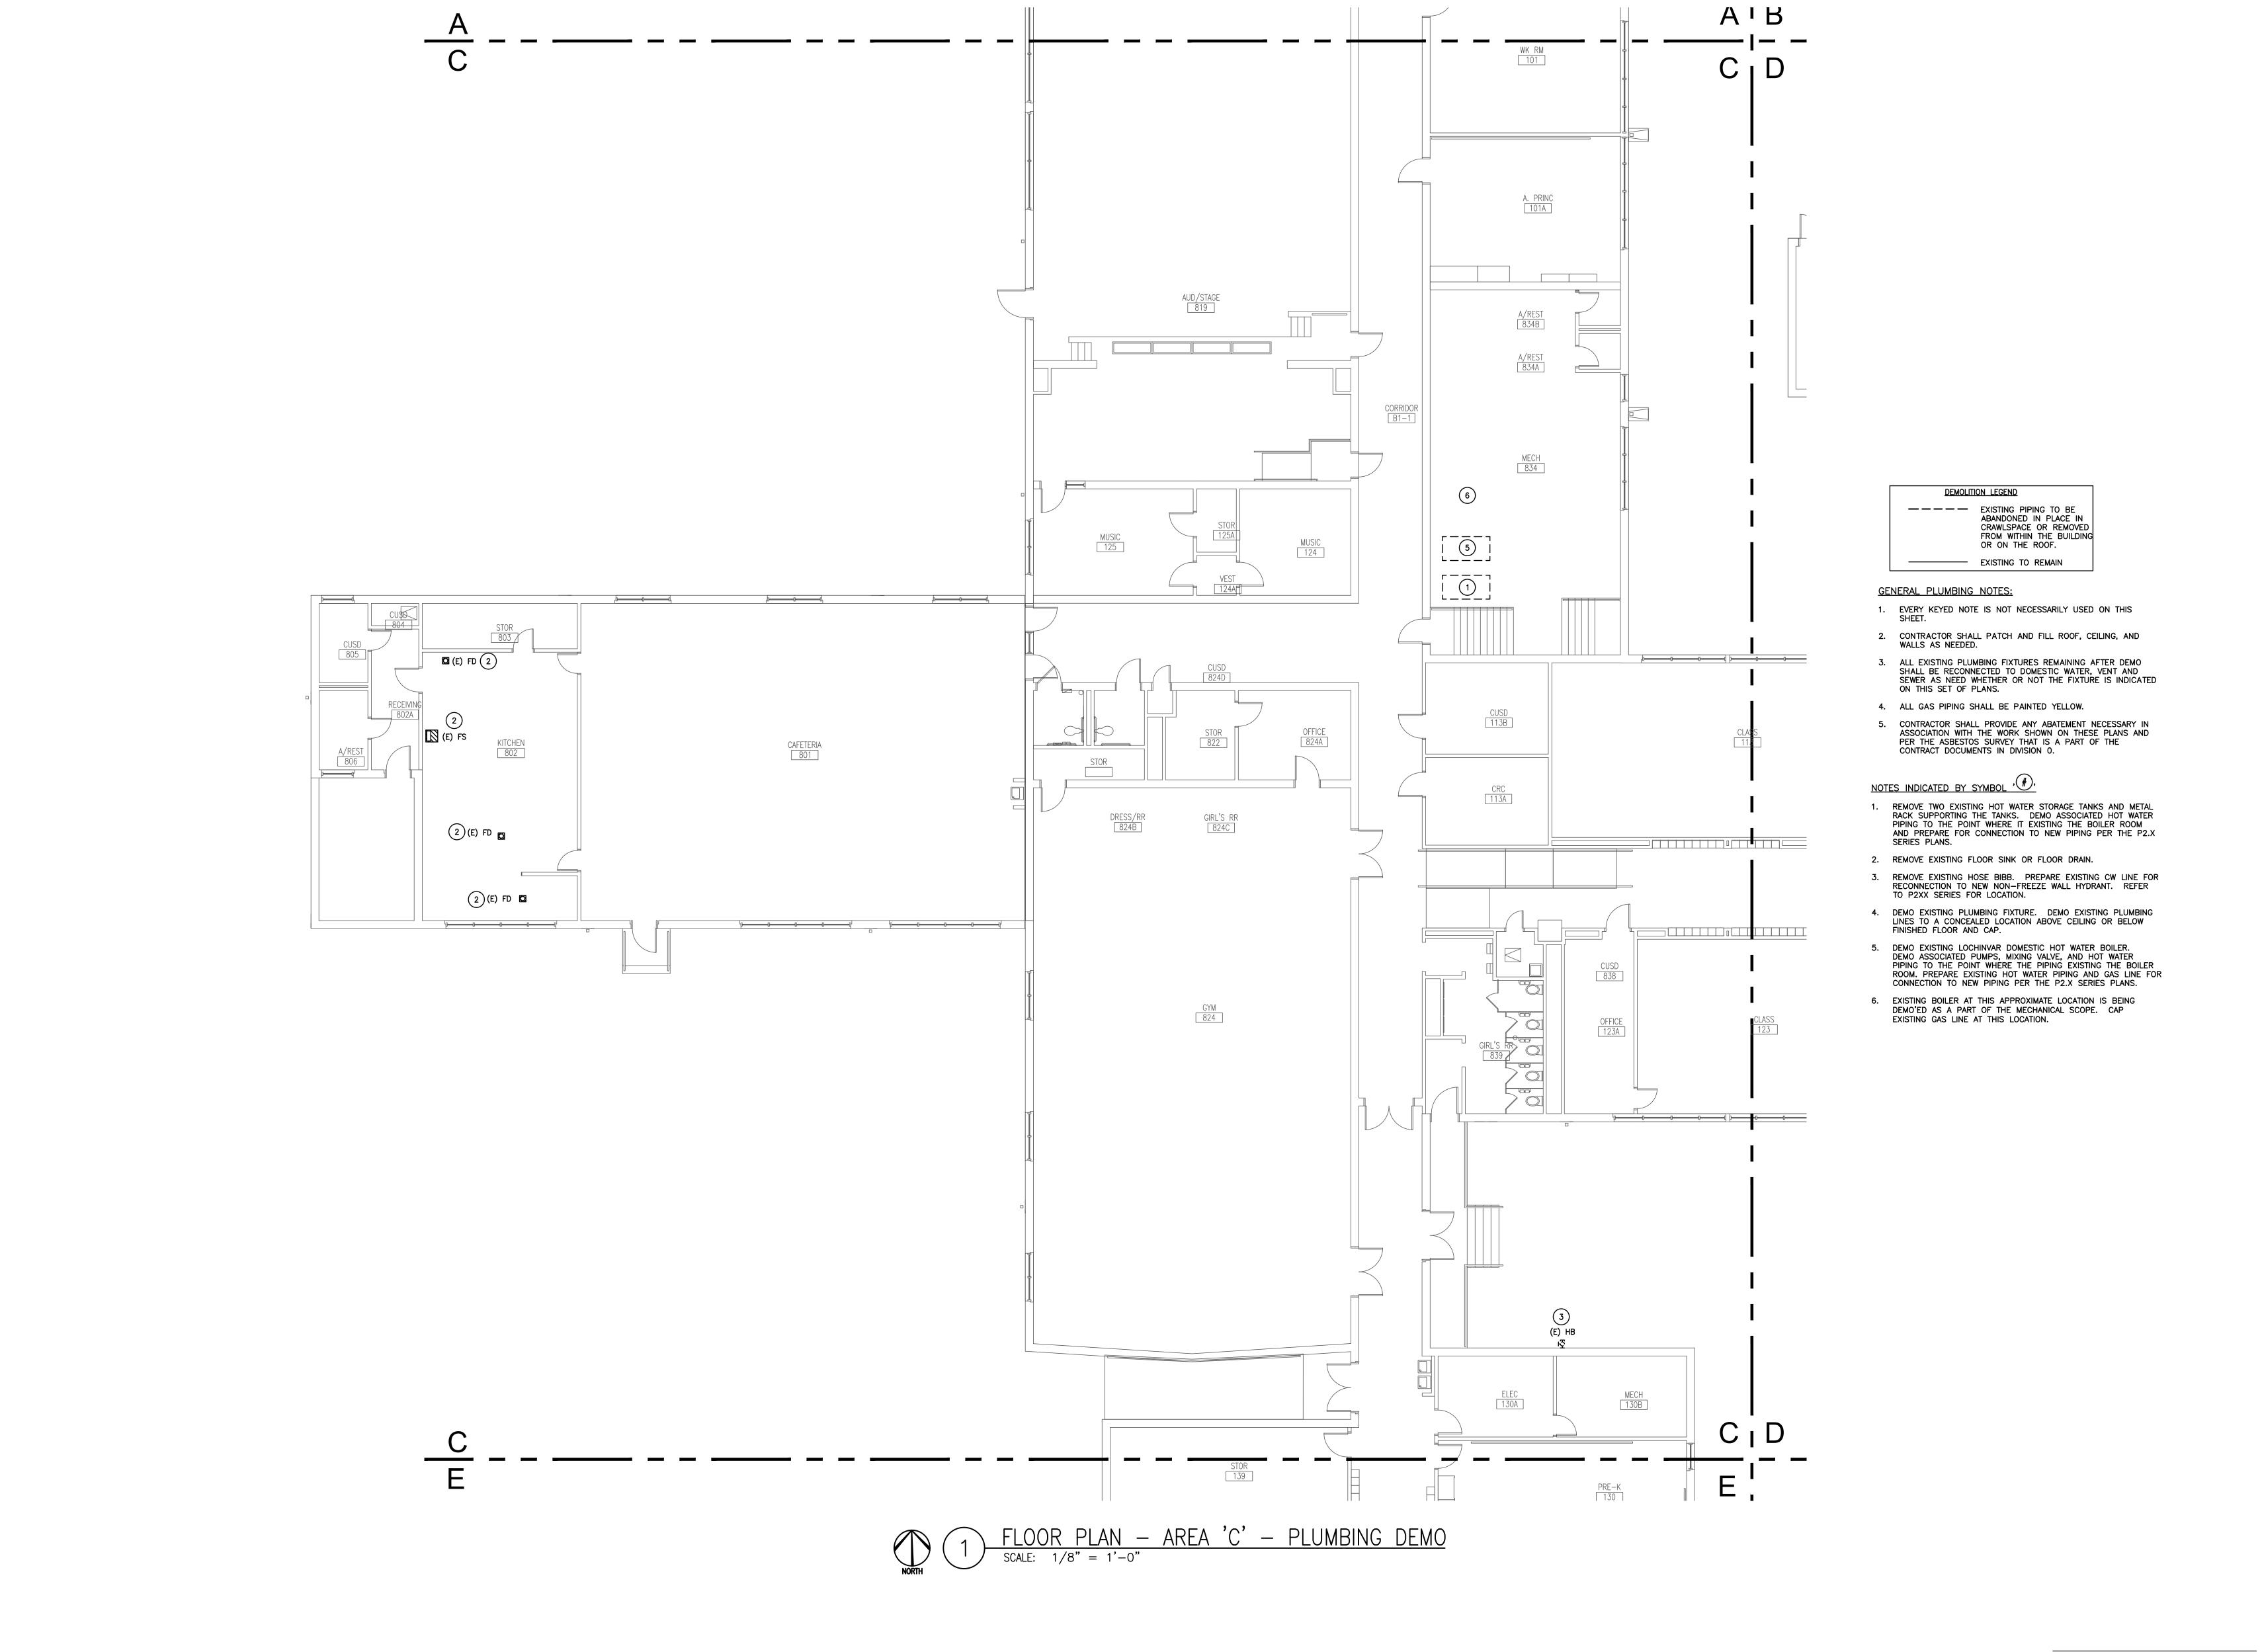
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FLOOR PLAN PLUMBING DEMO

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P111

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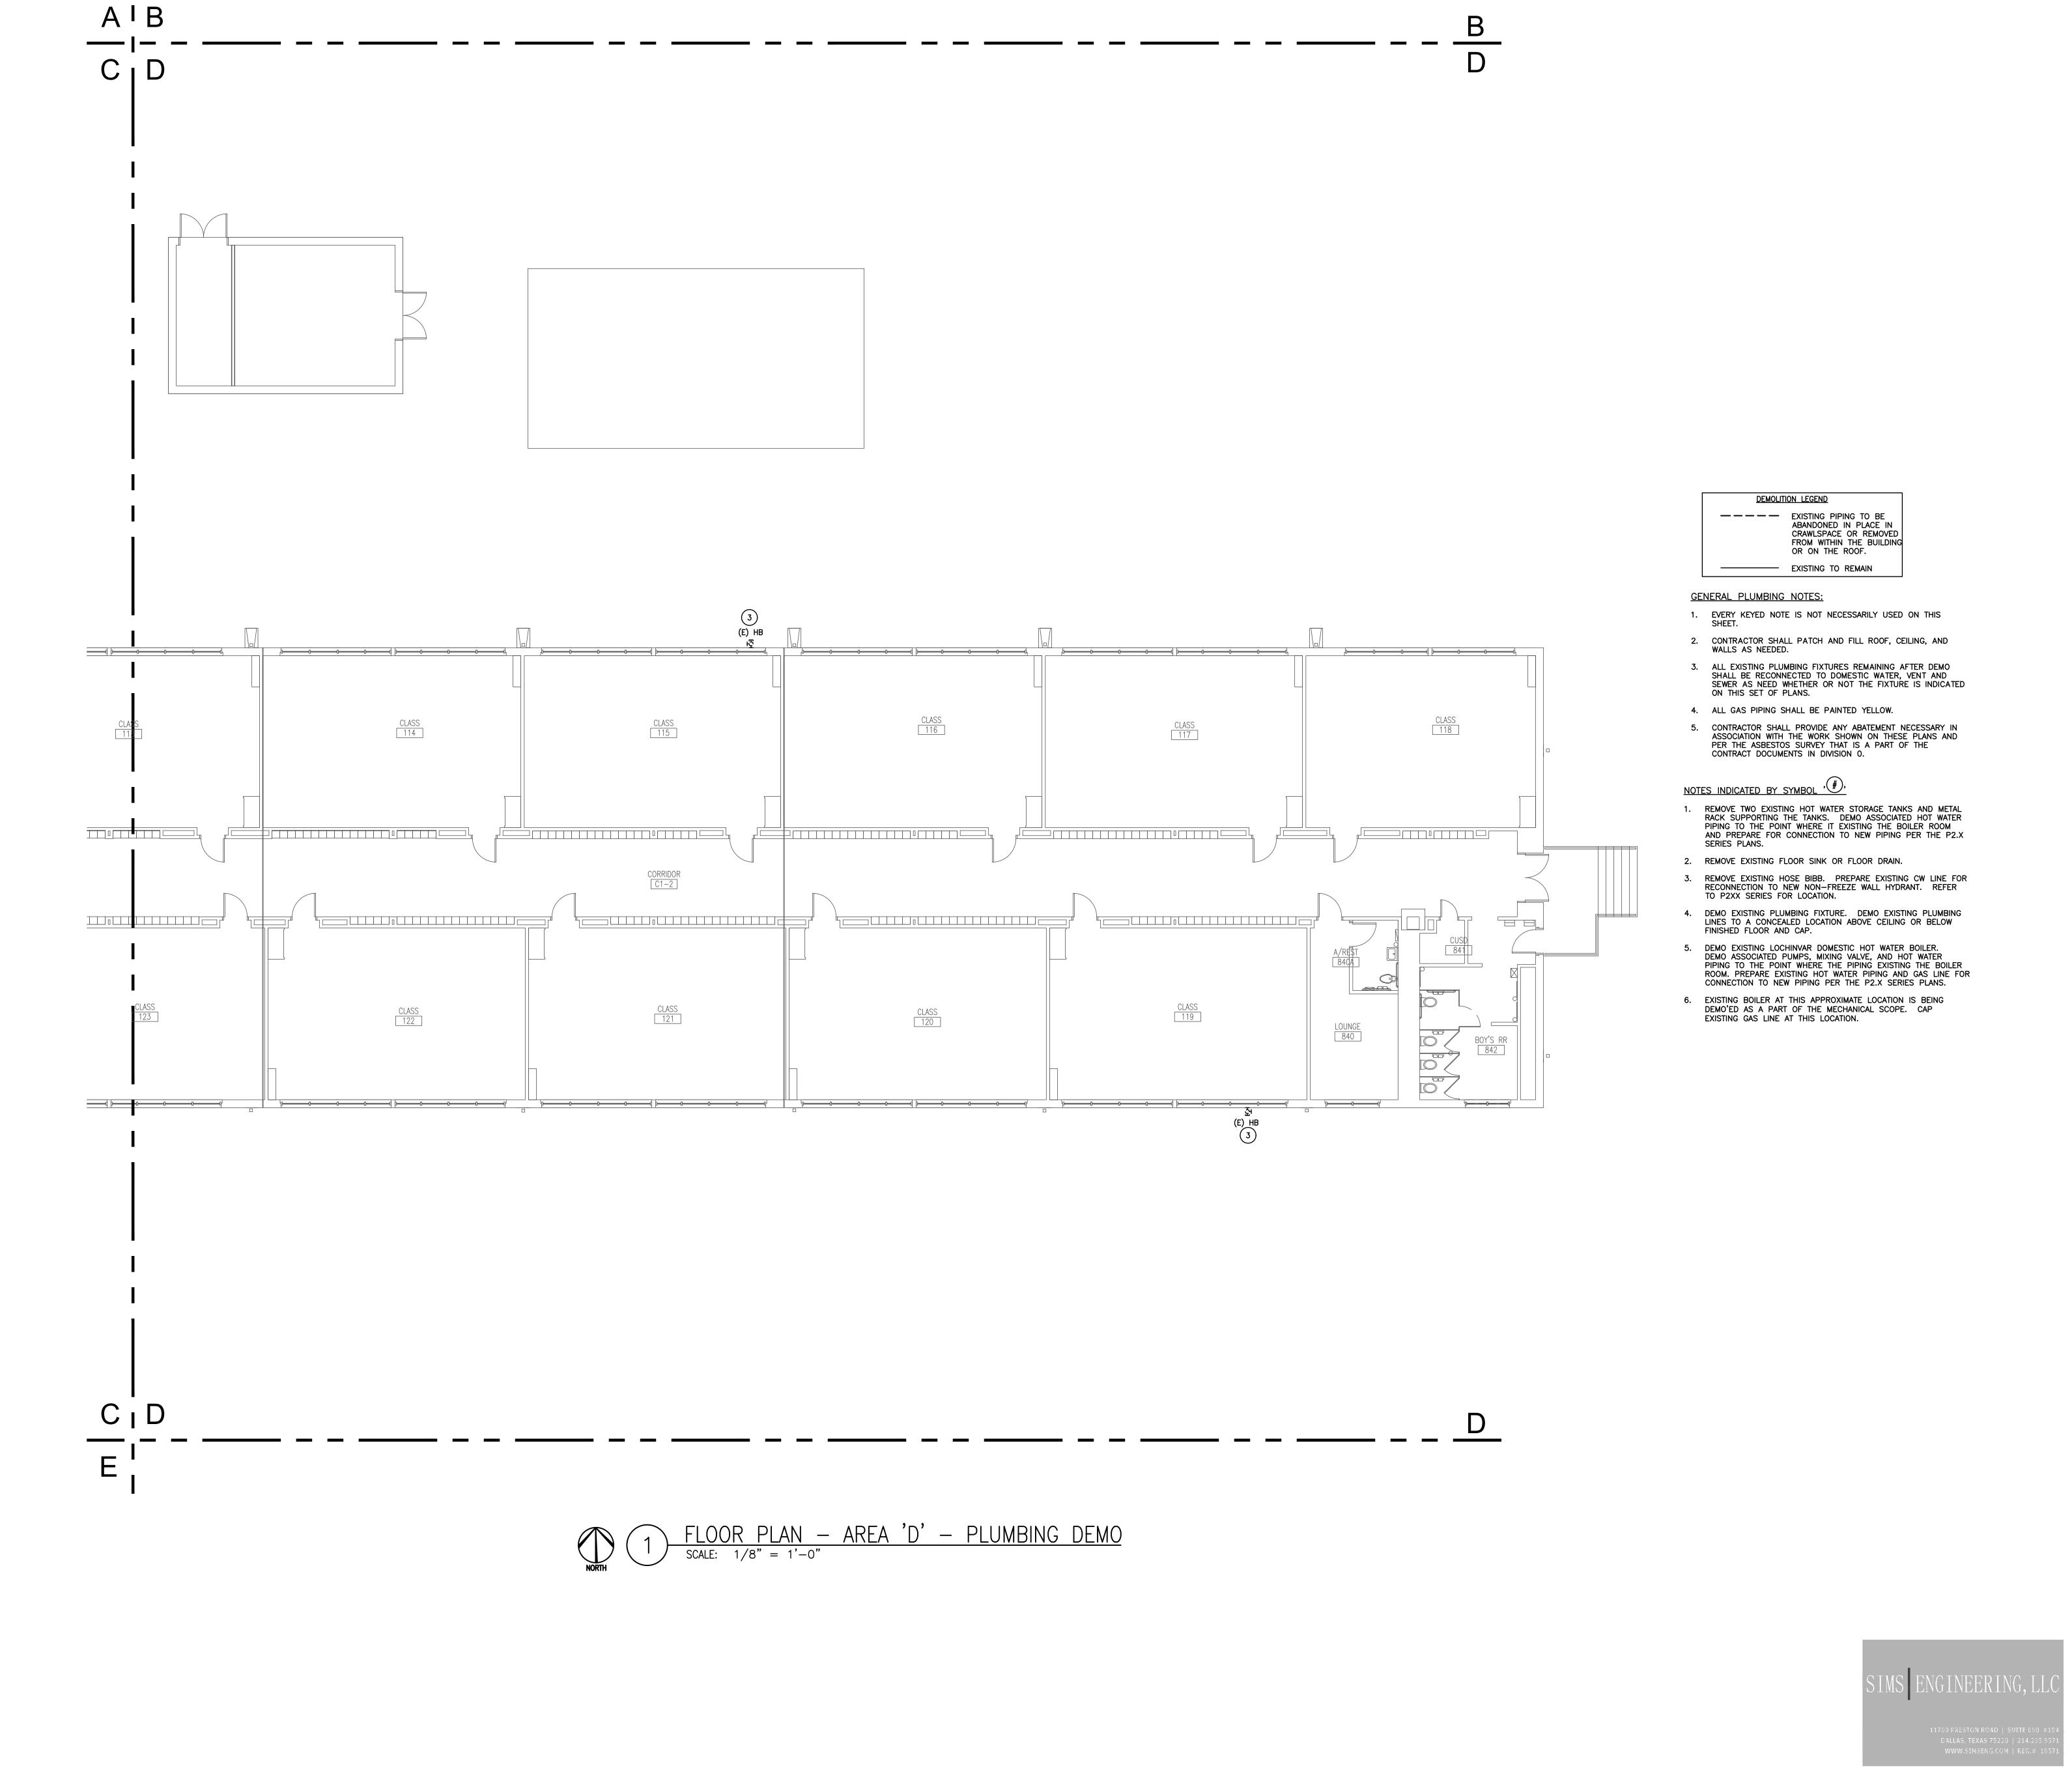
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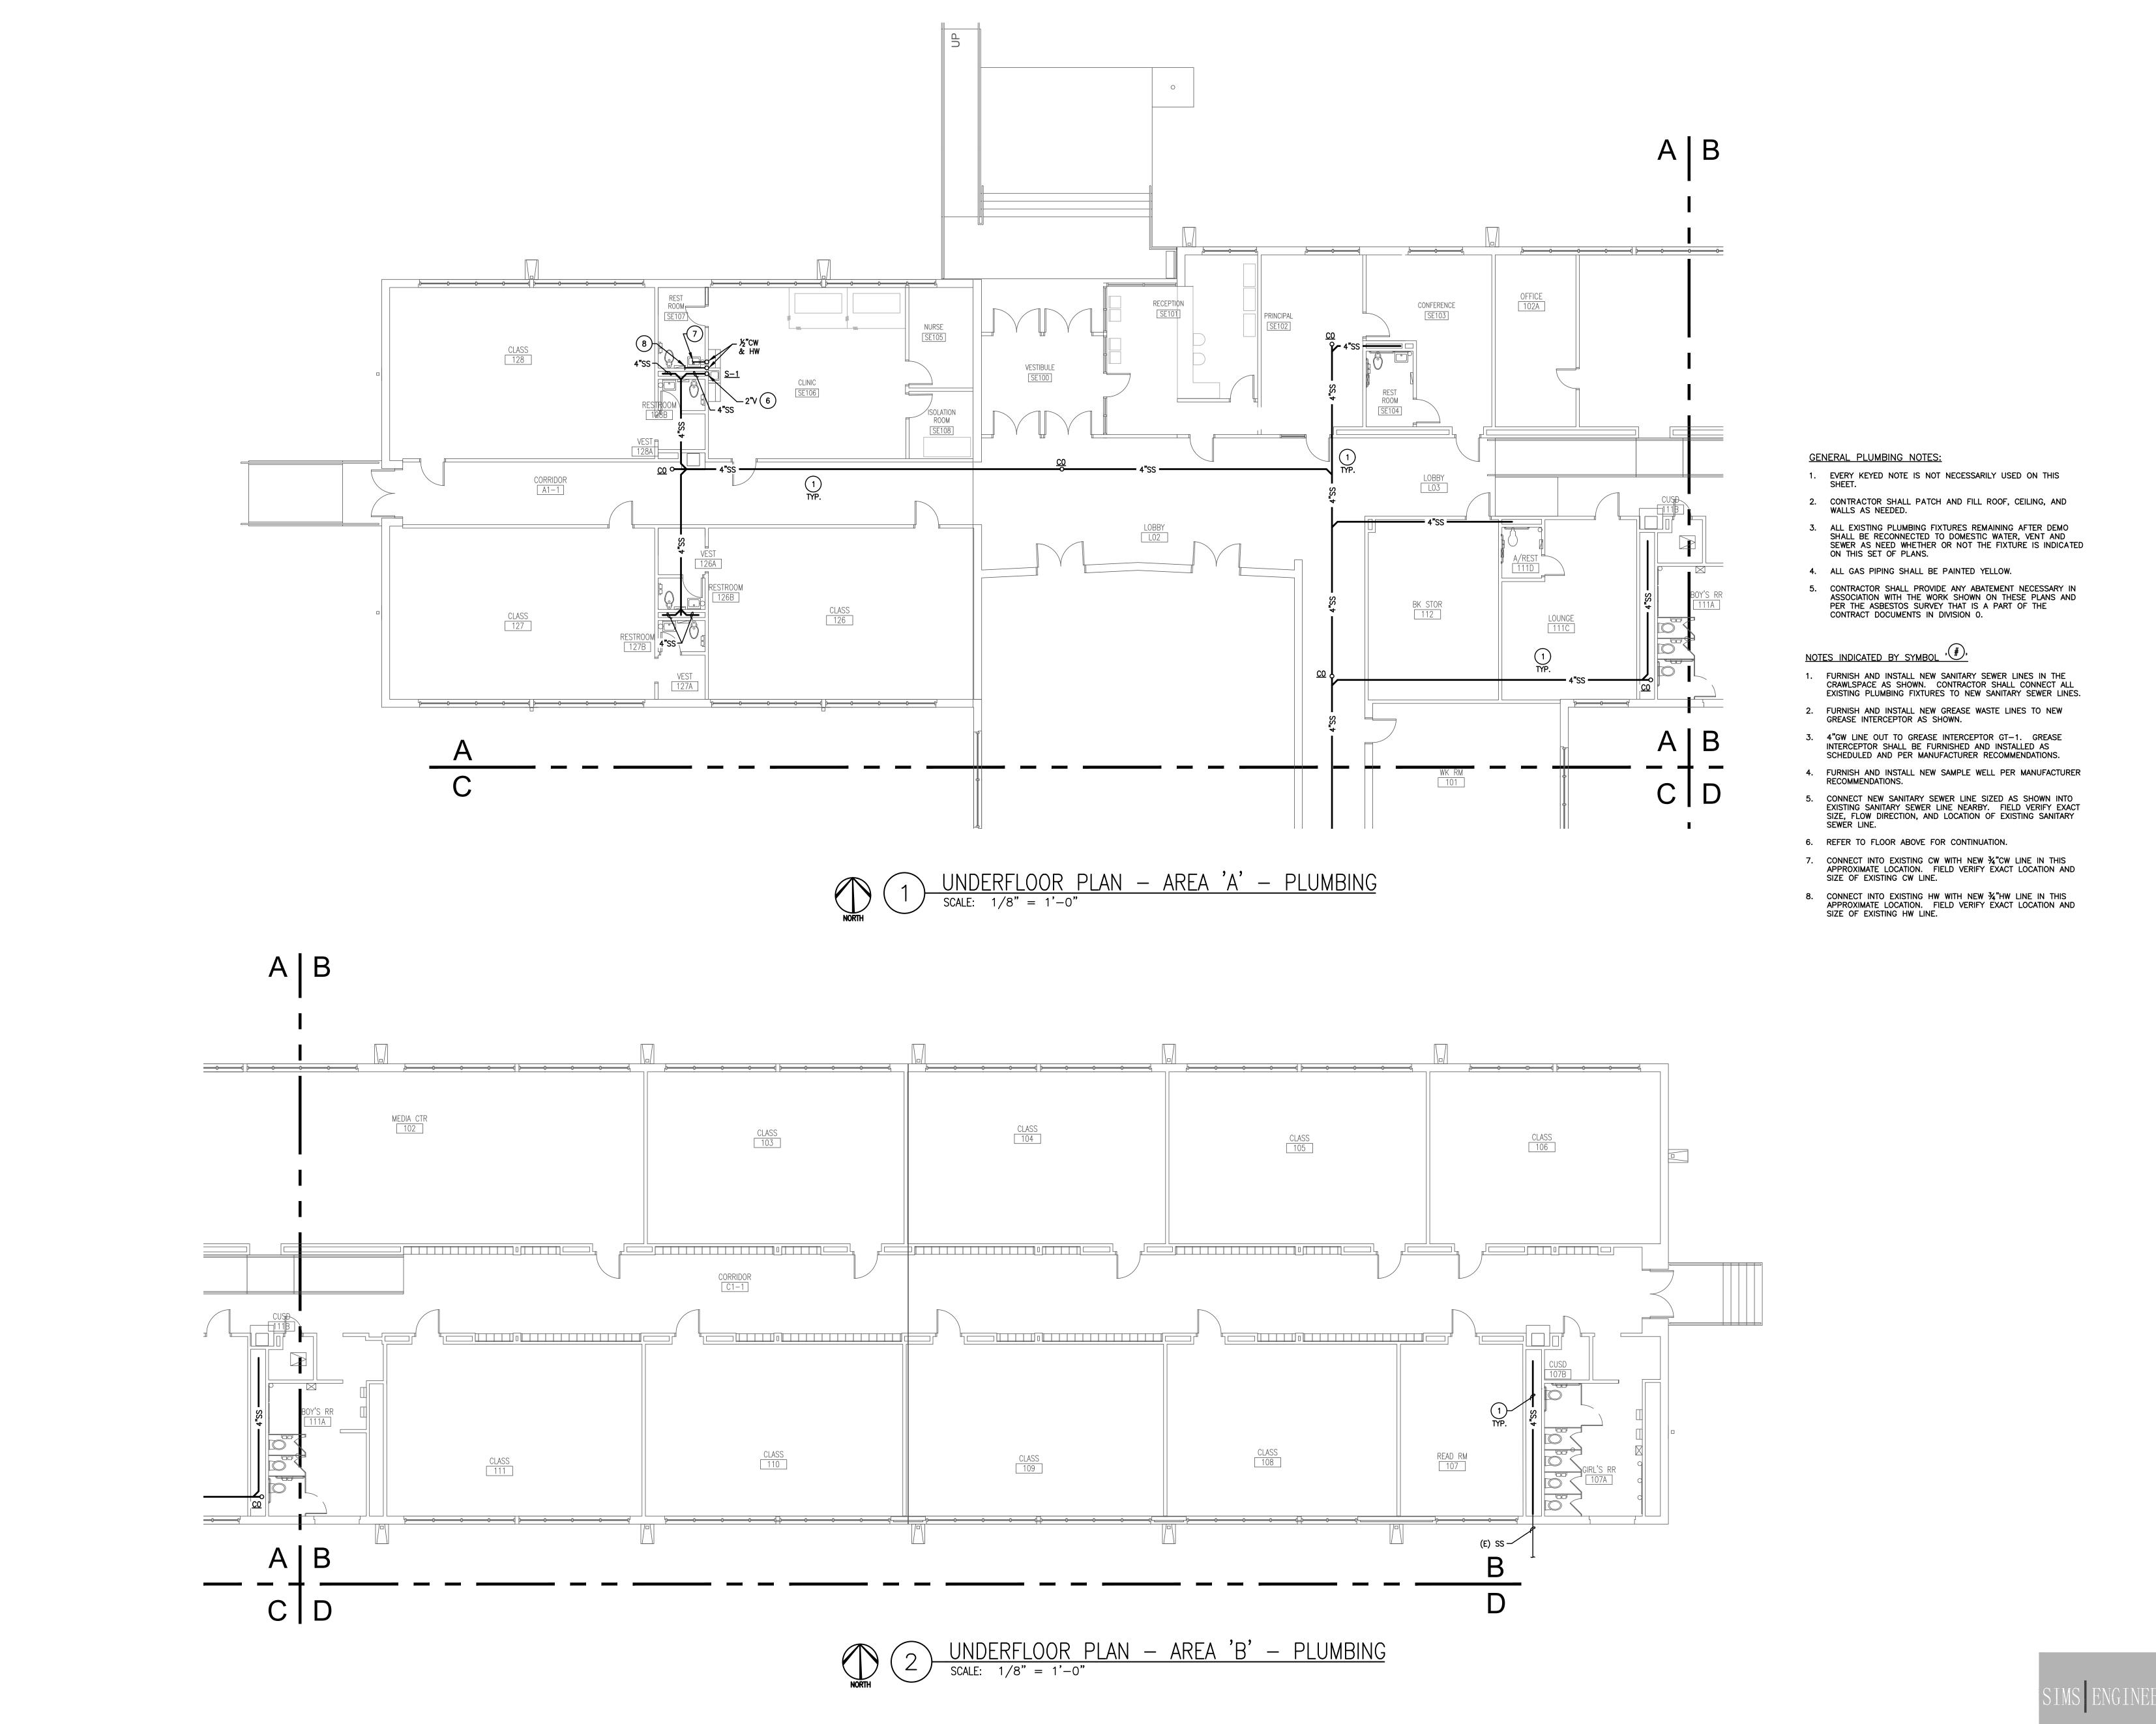
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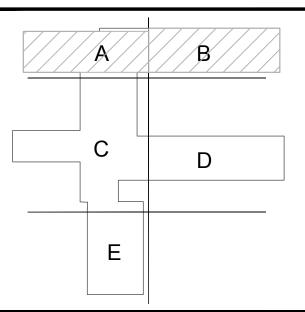
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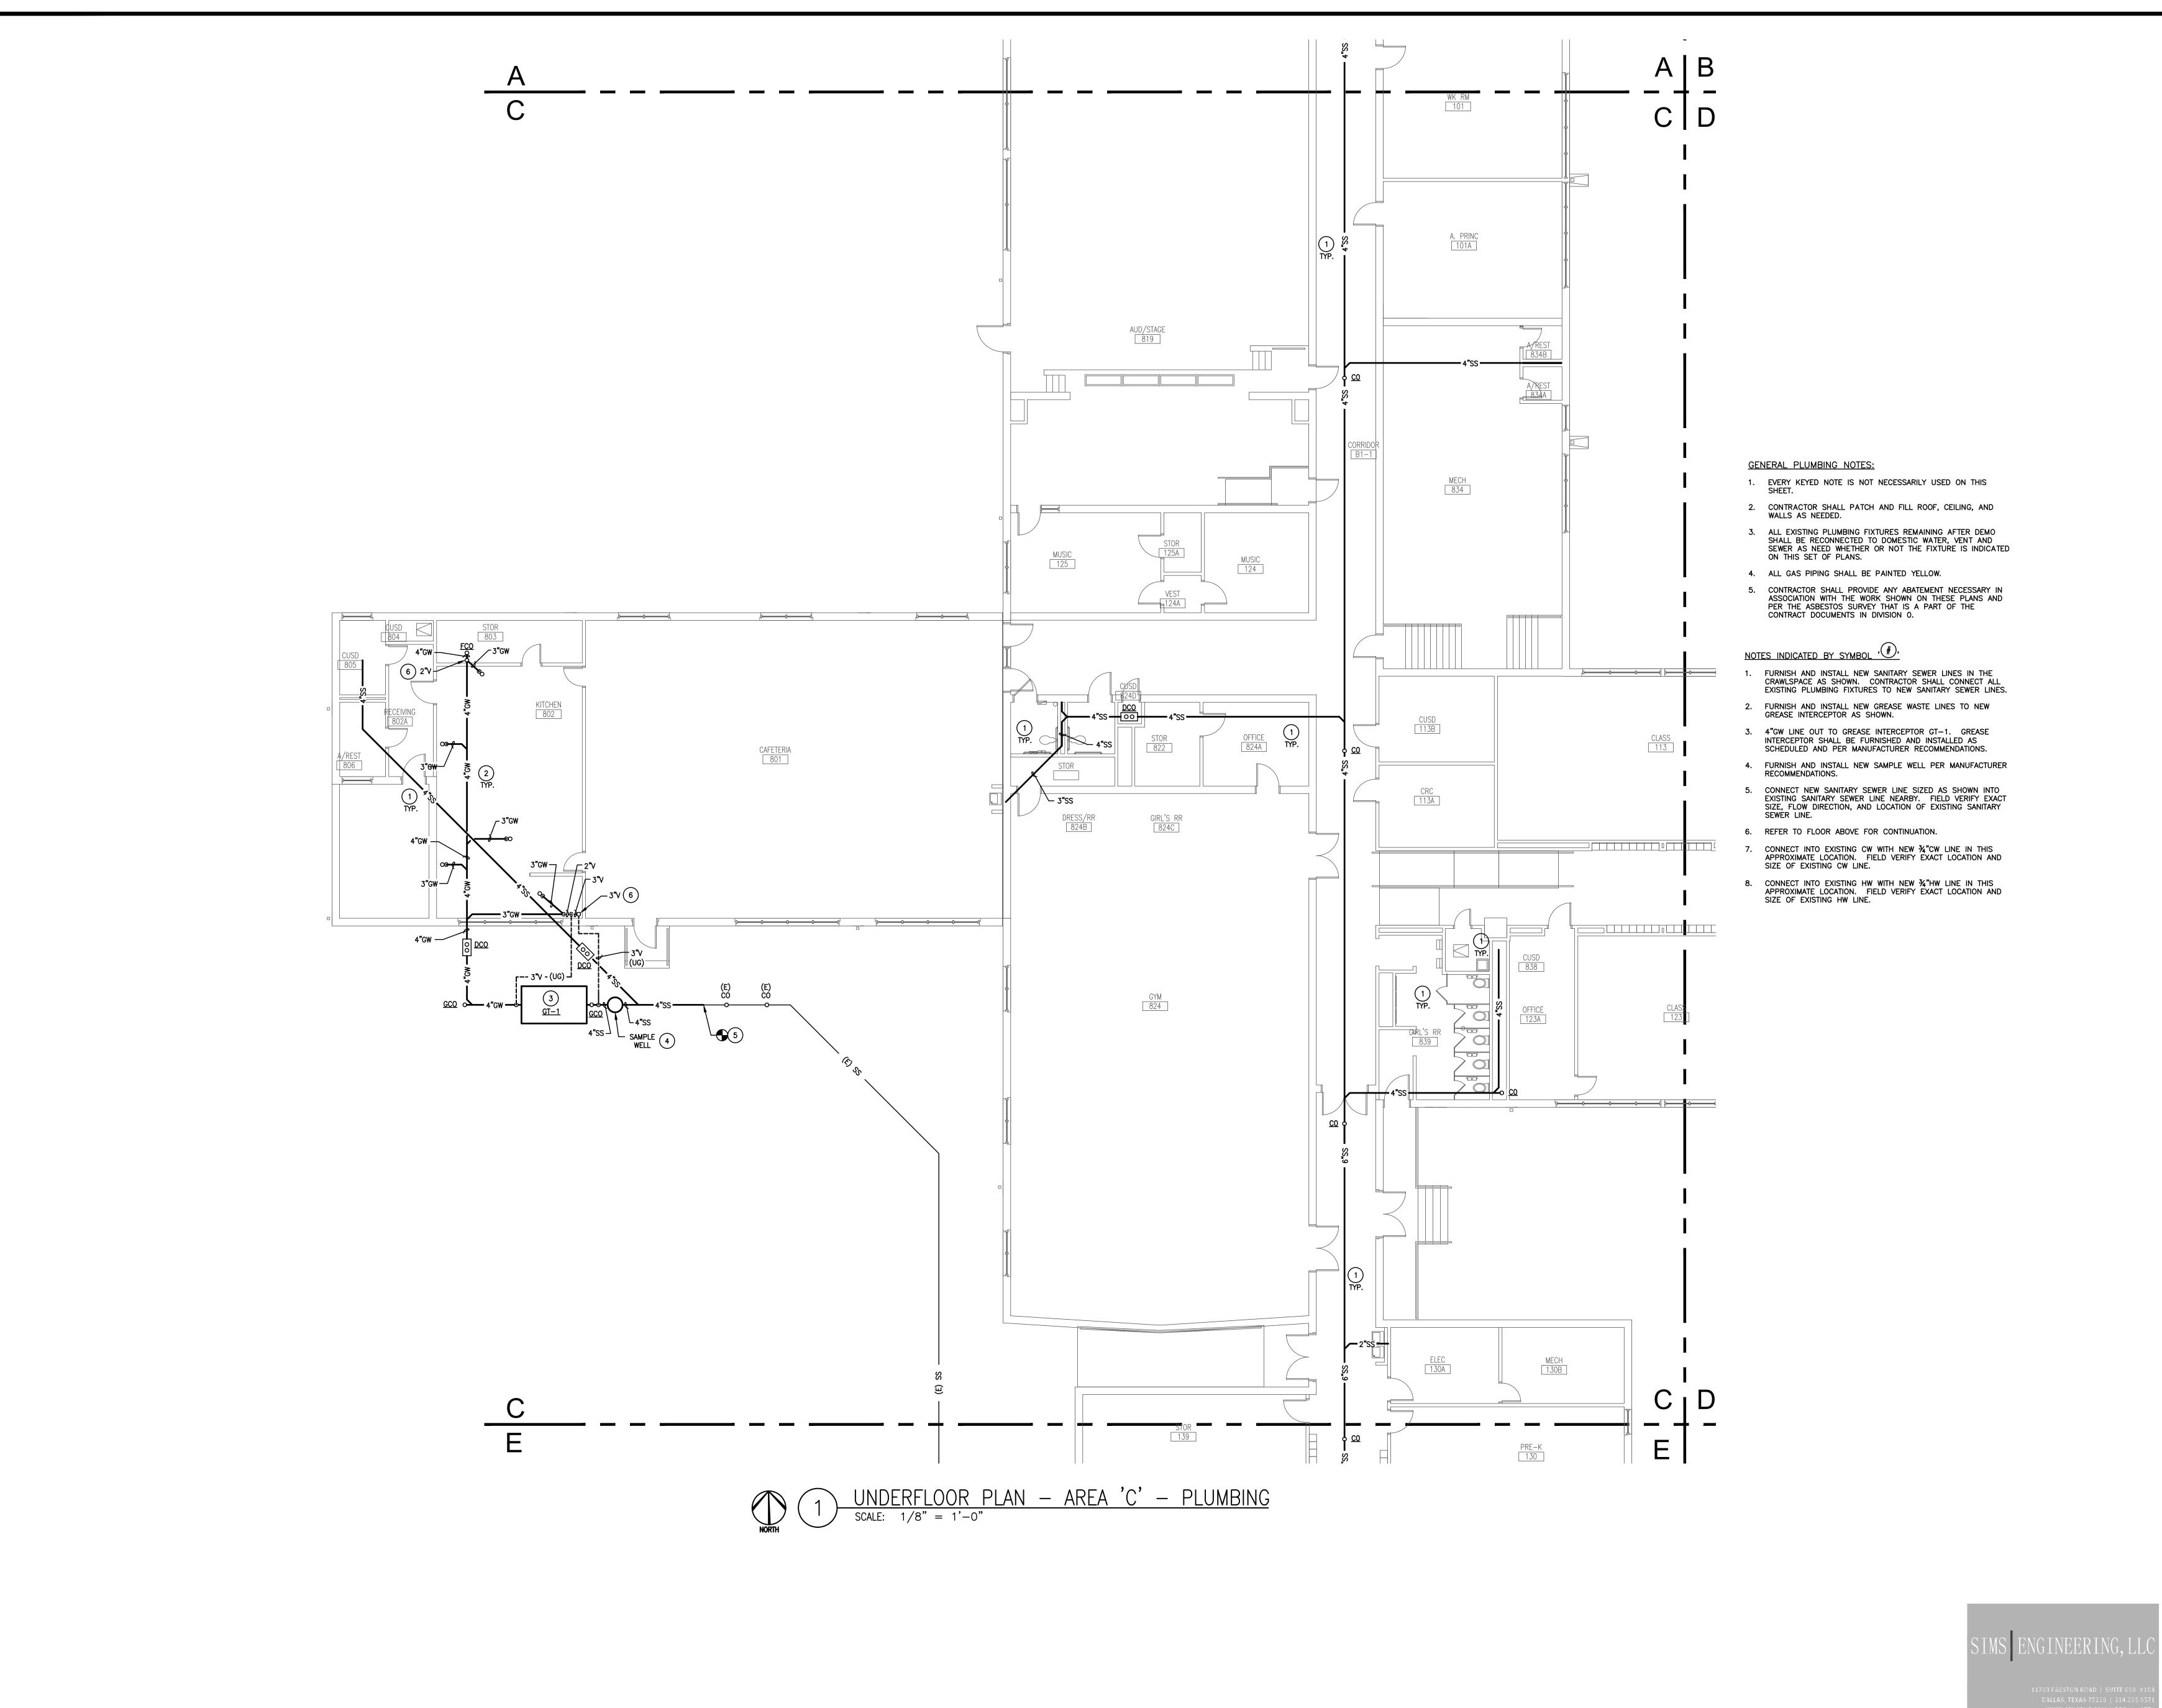
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P201

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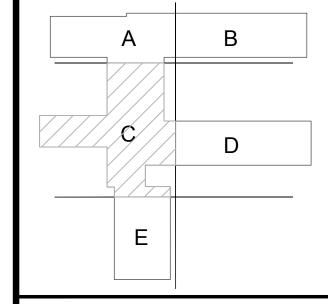
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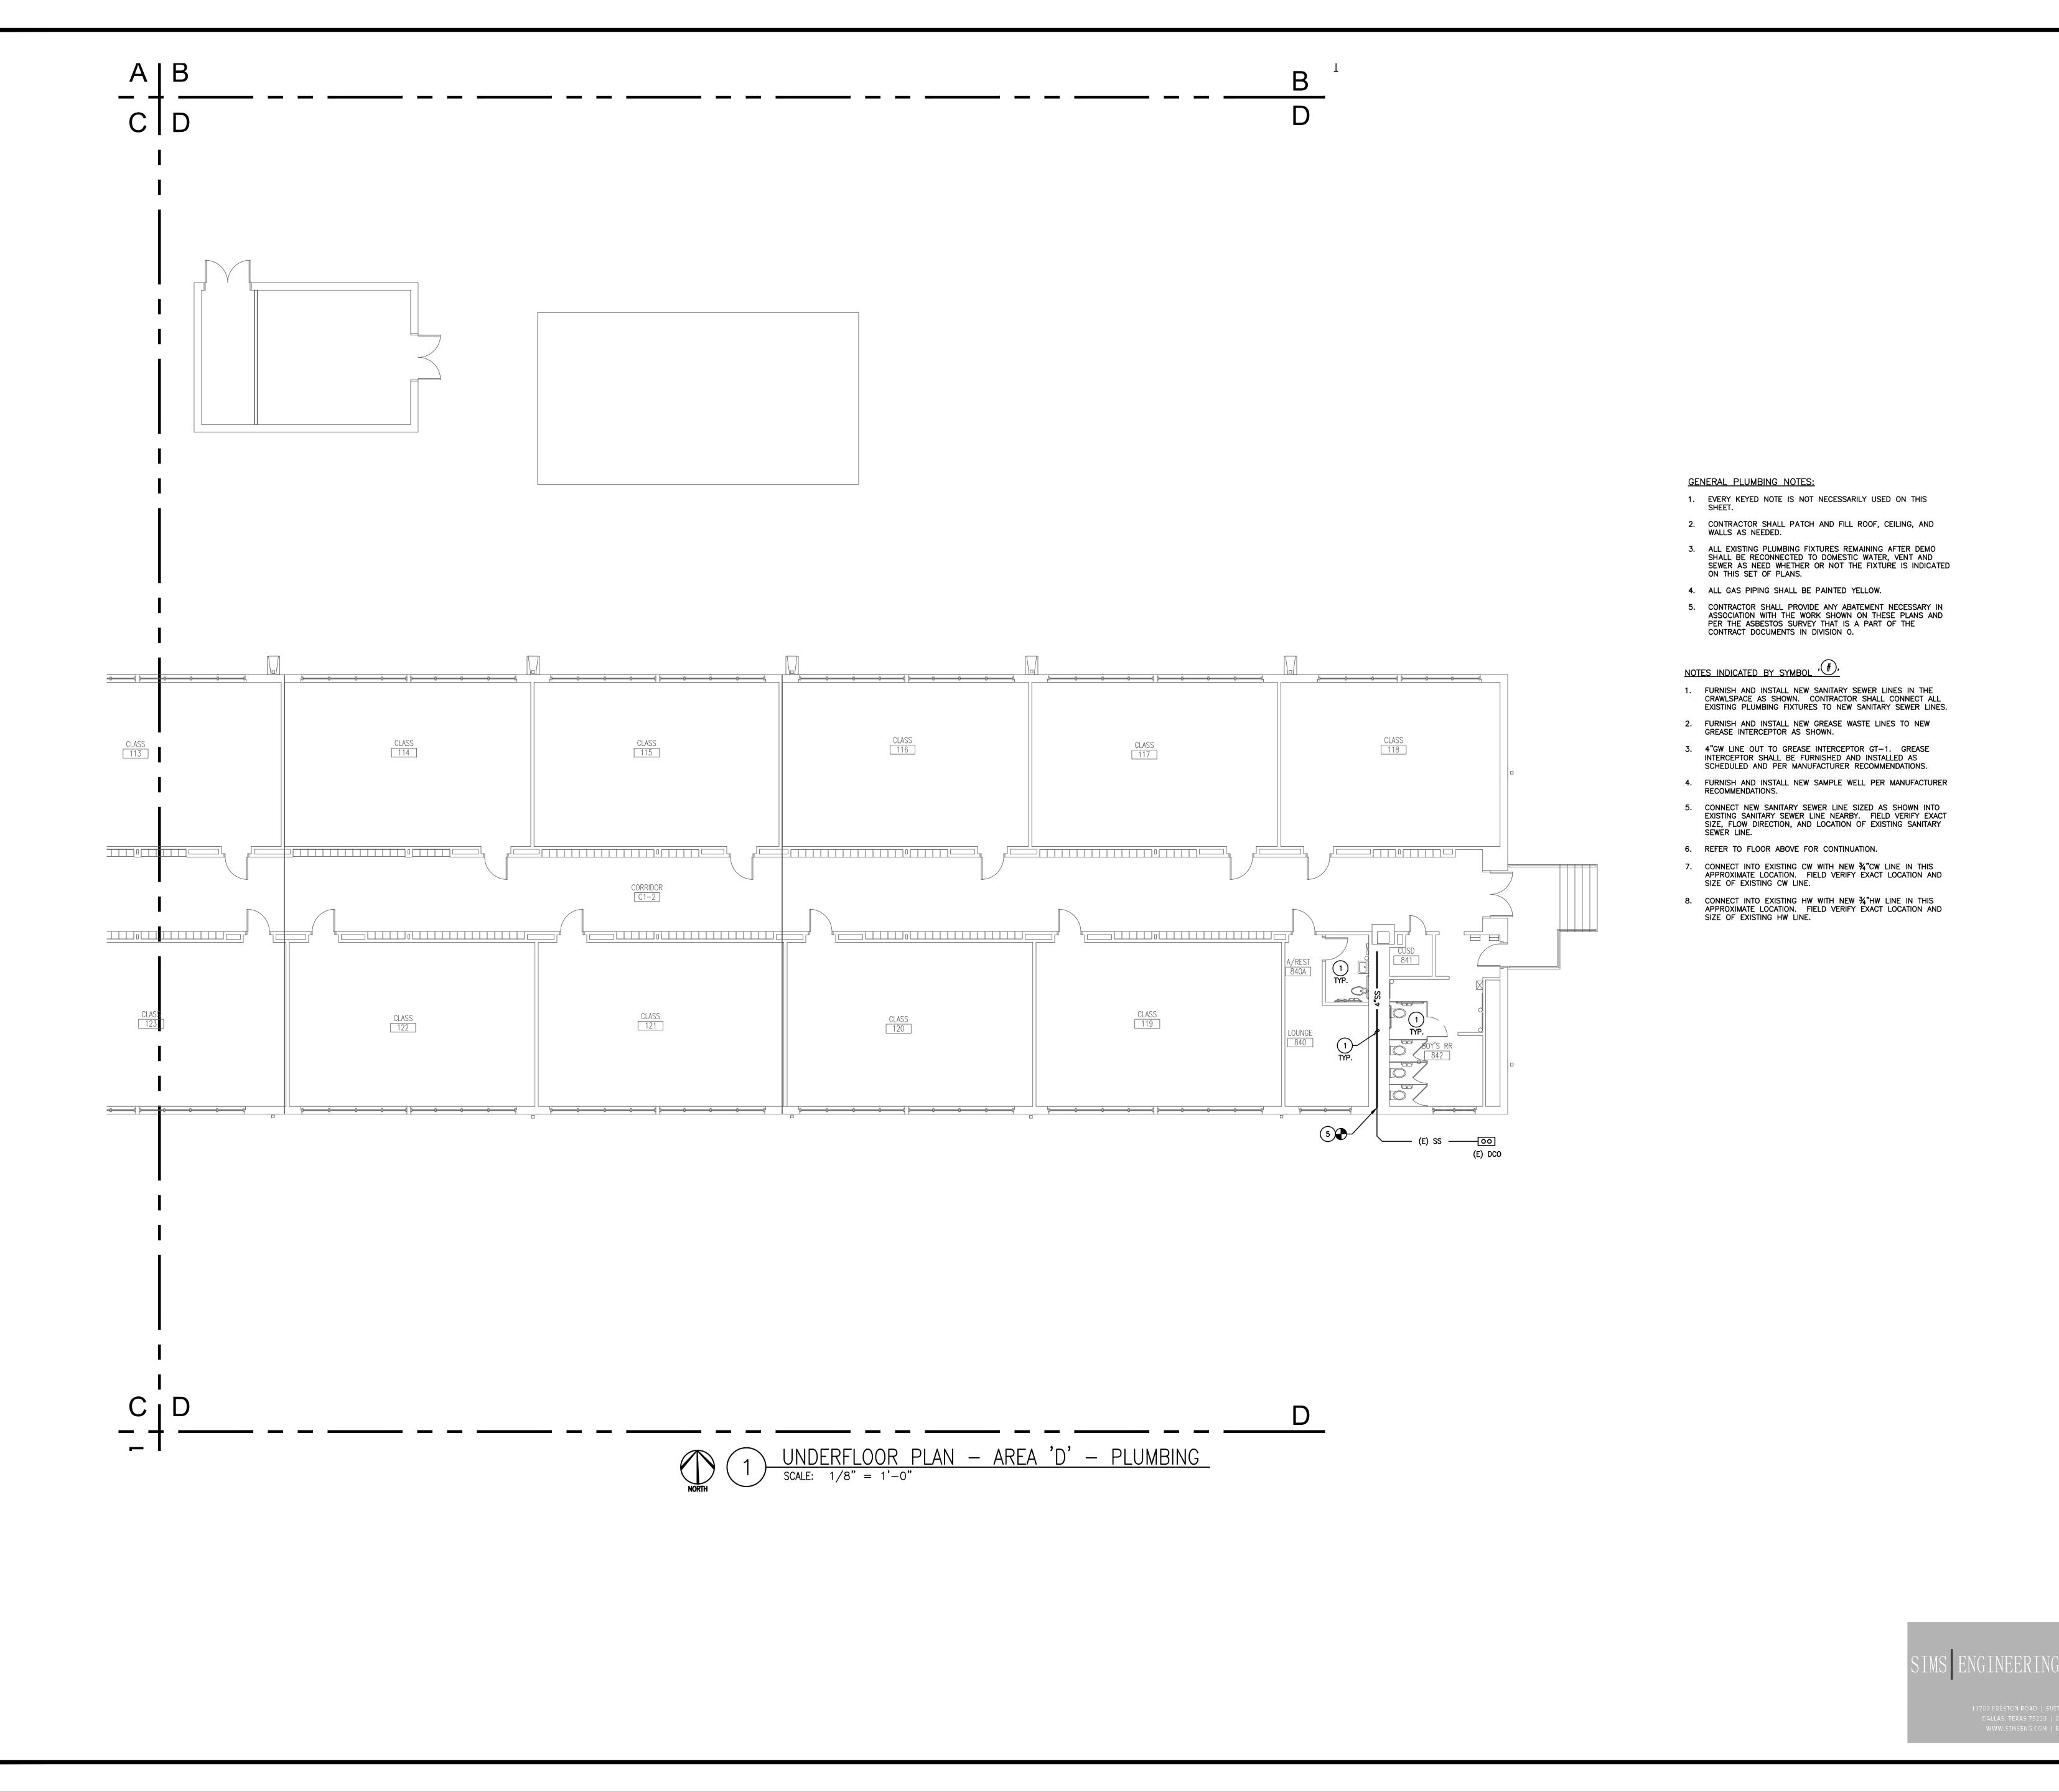
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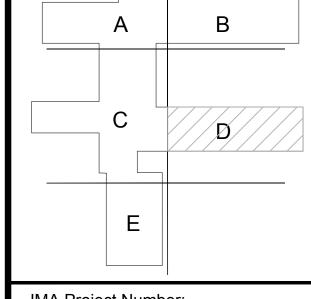
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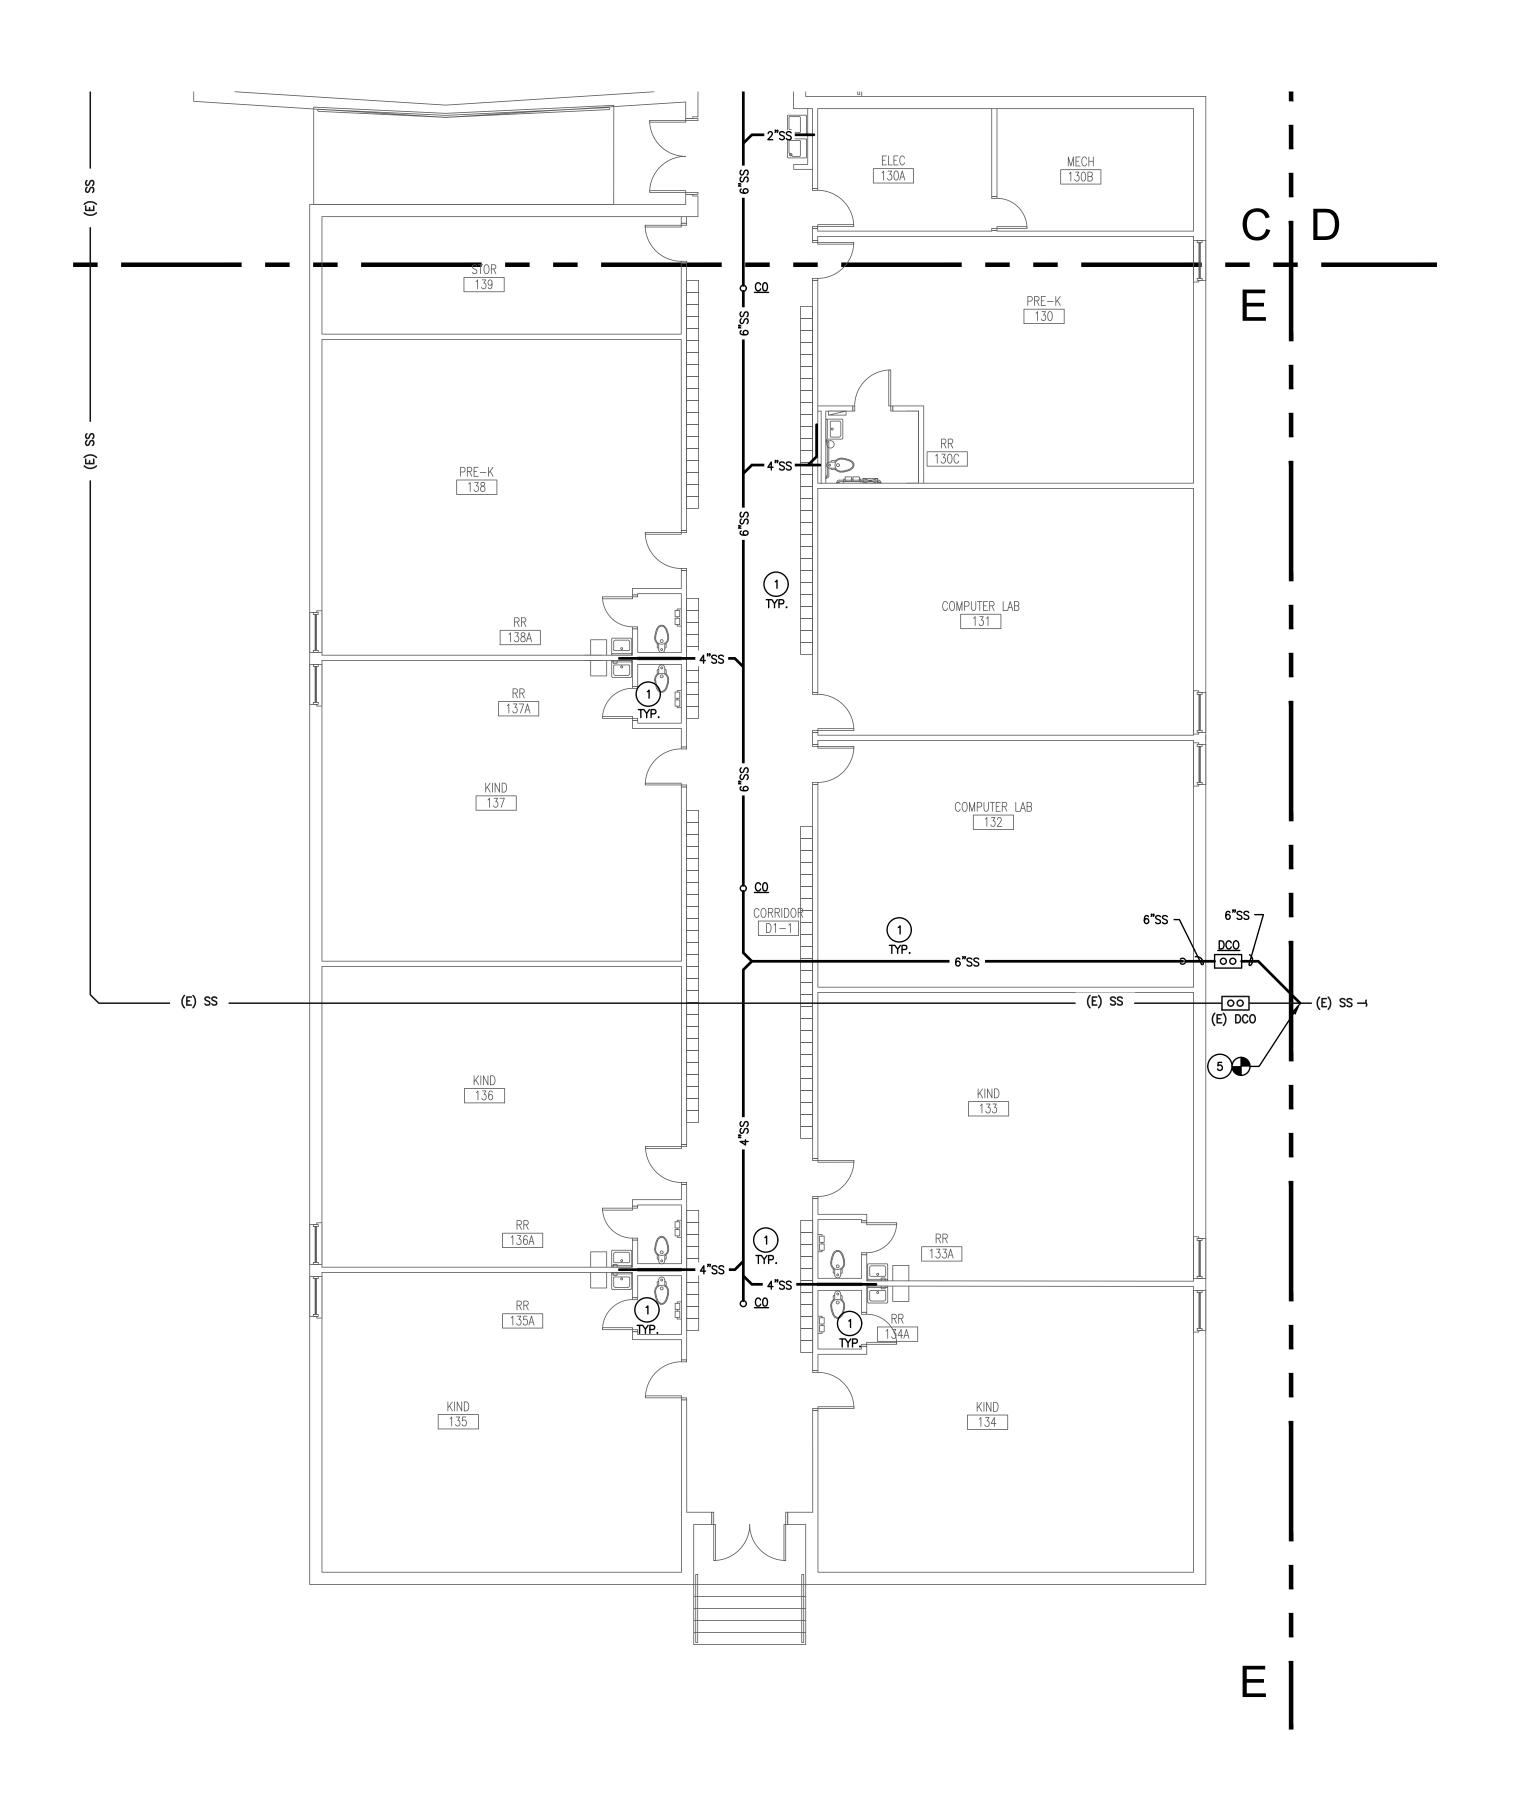
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UNDERFLOOR PLAN PLUMBING

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UNDERFLOOR PLAN - AREA 'E' - PLUMBING

SCALE: 1/8" = 1'-0"



- 1. EVERY KEYED NOTE IS NOT NECESSARILY USED ON THIS
- 2. CONTRACTOR SHALL PATCH AND FILL ROOF, CEILING, AND WALLS AS NEEDED.
- 3. ALL EXISTING PLUMBING FIXTURES REMAINING AFTER DEMO SHALL BE RECONNECTED TO DOMESTIC WATER, VENT AND SEWER AS NEED WHETHER OR NOT THE FIXTURE IS INDICATED ON THIS SET OF PLANS.
- 4. ALL GAS PIPING SHALL BE PAINTED YELLOW.
- 5. CONTRACTOR SHALL PROVIDE ANY ABATEMENT NECESSARY IN ASSOCIATION WITH THE WORK SHOWN ON THESE PLANS AND PER THE ASBESTOS SURVEY THAT IS A PART OF THE CONTRACT DOCUMENTS IN DIVISION 0.

NOTES INDICATED BY SYMBOL , #,

- FURNISH AND INSTALL NEW SANITARY SEWER LINES IN THE CRAWLSPACE AS SHOWN. CONTRACTOR SHALL CONNECT ALL EXISTING PLUMBING FIXTURES TO NEW SANITARY SEWER LINES.
- FURNISH AND INSTALL NEW GREASE WASTE LINES TO NEW GREASE INTERCEPTOR AS SHOWN.
- 3. 4"GW LINE OUT TO GREASE INTERCEPTOR GT-1. GREASE
- INTERCEPTOR SHALL BE FURNISHED AND INSTALLED AS SCHEDULED AND PER MANUFACTURER RECOMMENDATIONS. 4. FURNISH AND INSTALL NEW SAMPLE WELL PER MANUFACTURER RECOMMENDATIONS.
- CONNECT NEW SANITARY SEWER LINE SIZED AS SHOWN INTO EXISTING SANITARY SEWER LINE NEARBY. FIELD VERIFY EXACT SIZE, FLOW DIRECTION, AND LOCATION OF EXISTING SANITARY SEWER LINE.
- 6. REFER TO FLOOR ABOVE FOR CONTINUATION.
- 7. CONNECT INTO EXISTING CW WITH NEW 3/4"CW LINE IN THIS APPROXIMATE LOCATION. FIELD VERIFY EXACT LOCATION AND SIZE OF EXISTING CW LINE.
- 8. CONNECT INTO EXISTING HW WITH NEW 3/4"HW LINE IN THIS APPROXIMATE LOCATION. FIELD VERIFY EXACT LOCATION AND SIZE OF EXISTING HW LINE.

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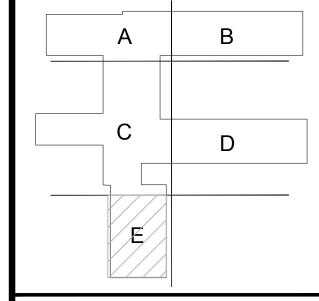
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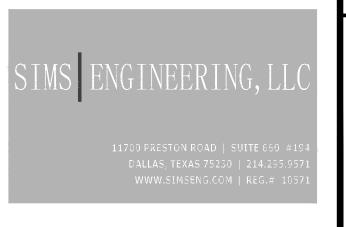



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UNDERFLOOR PLAN **PLUMBING**







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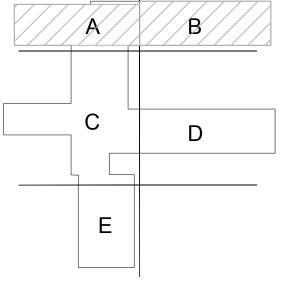
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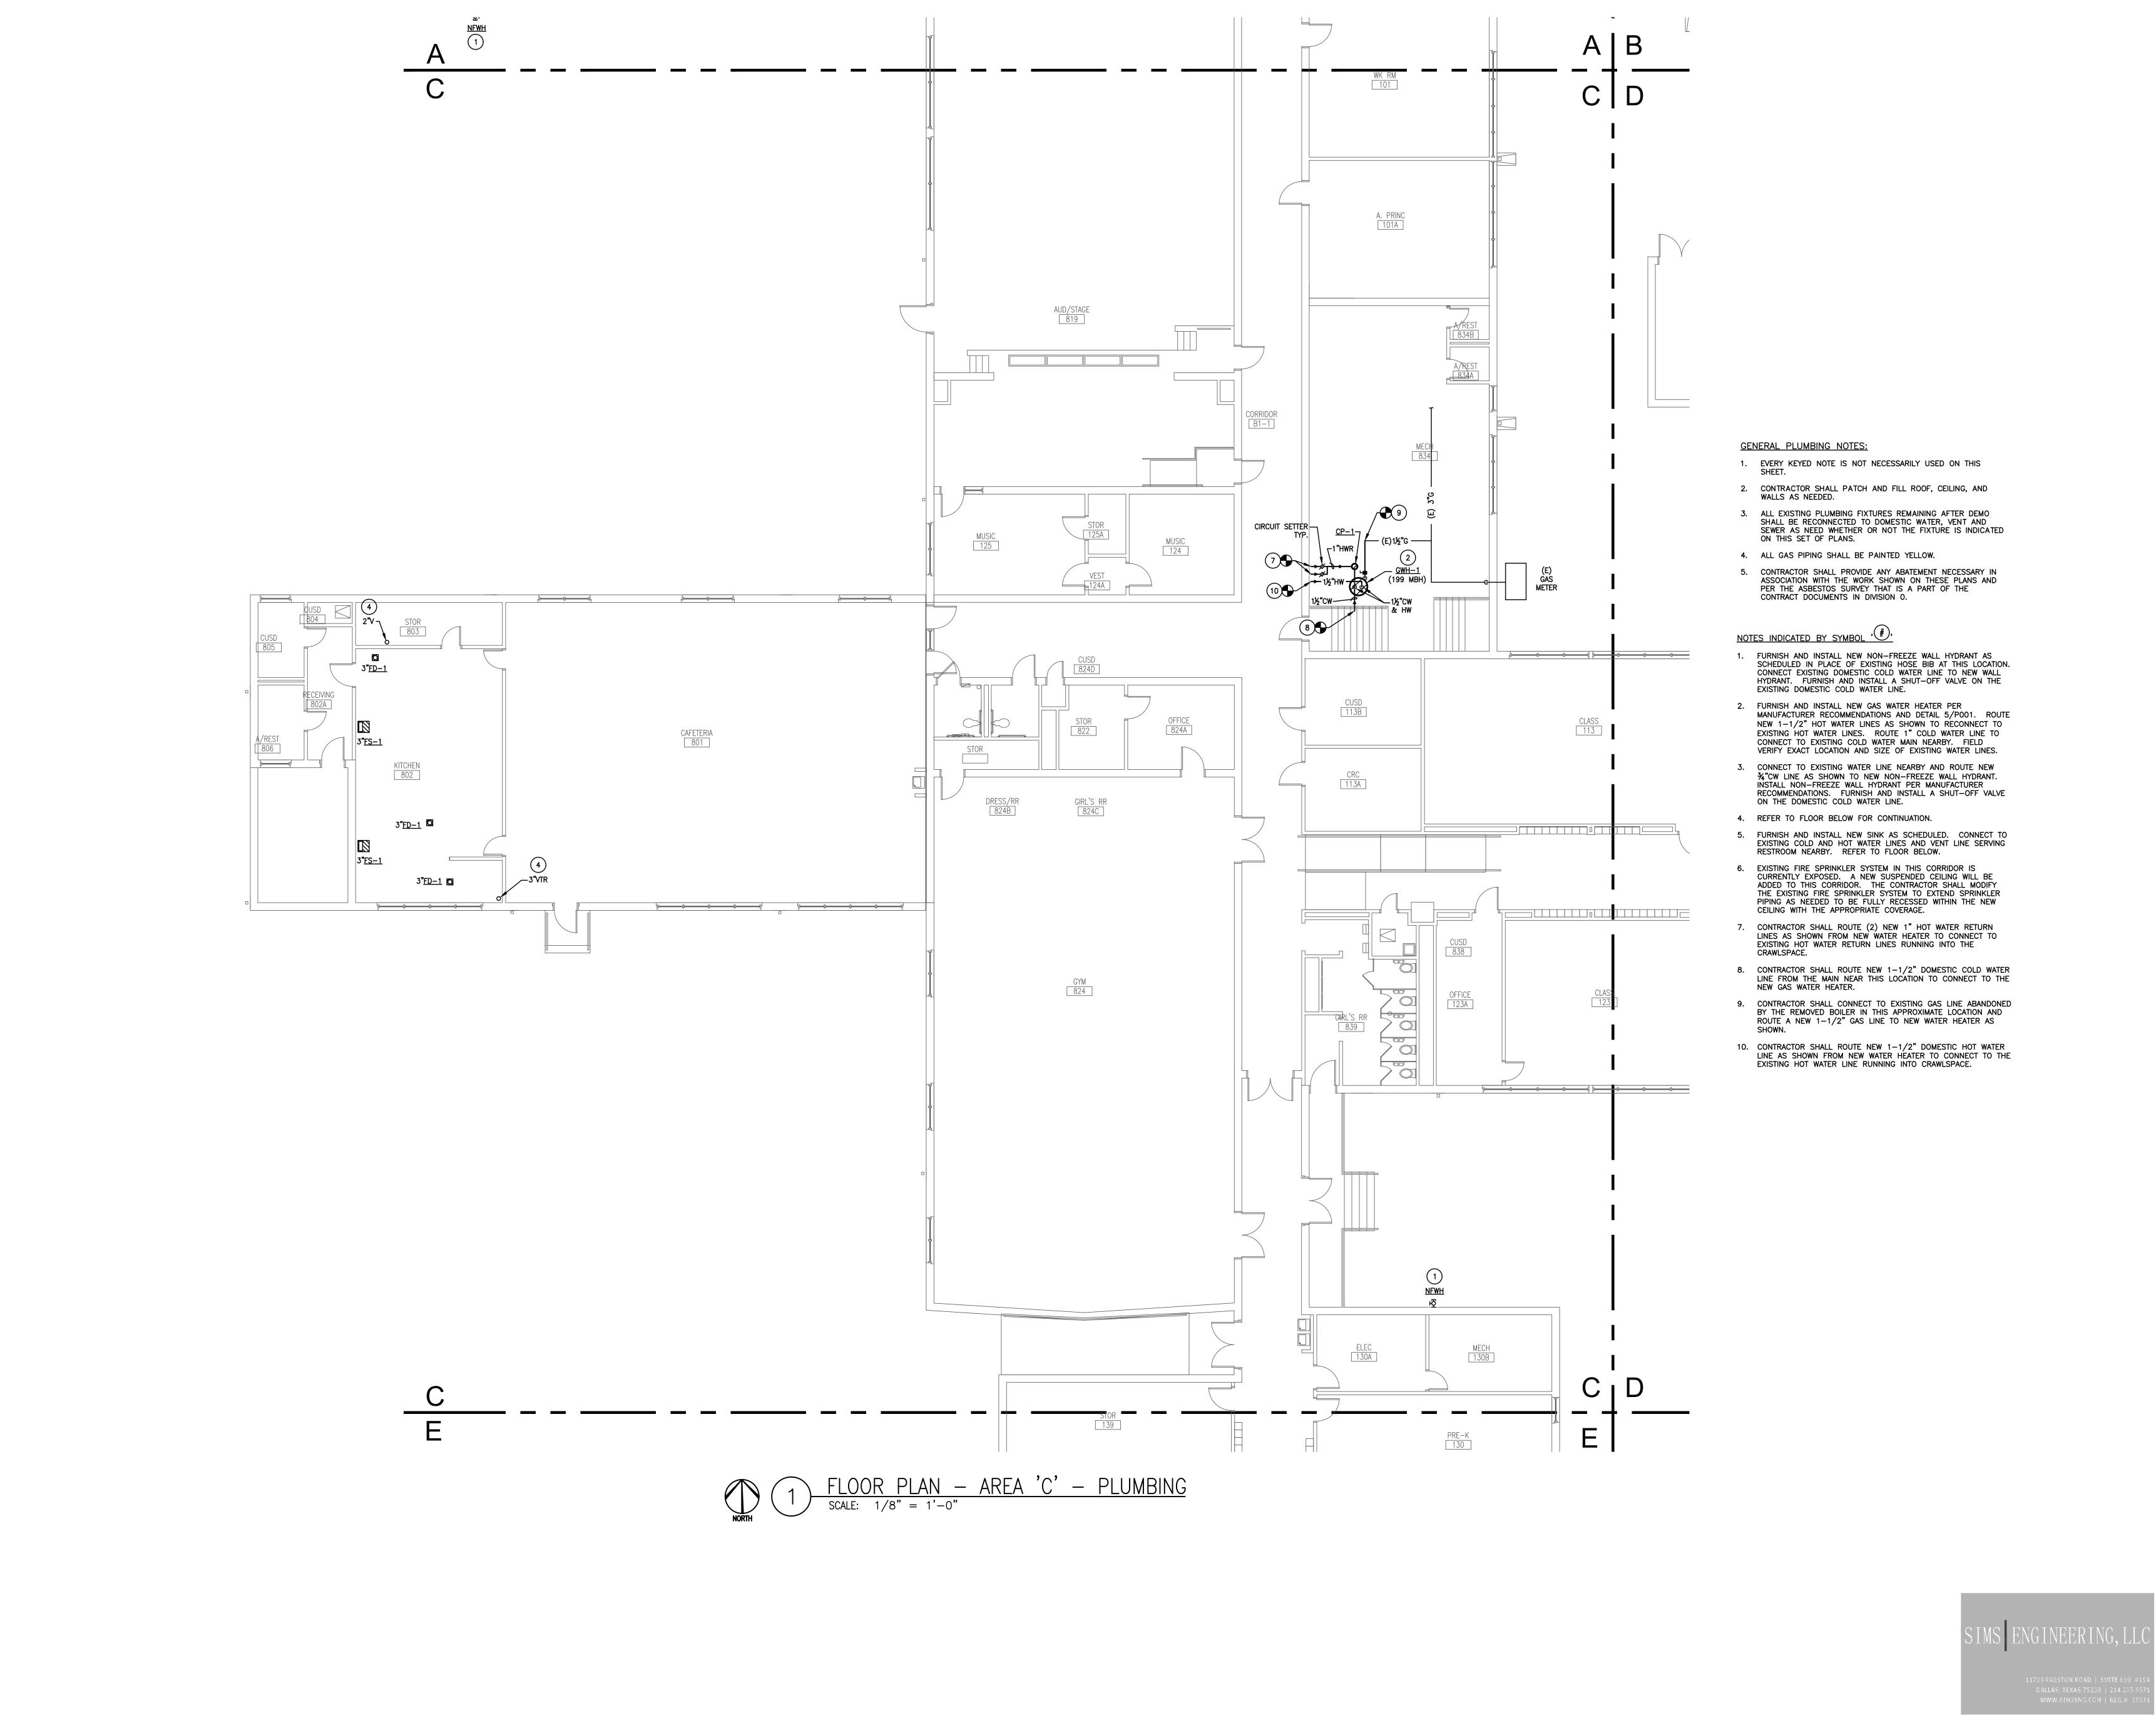
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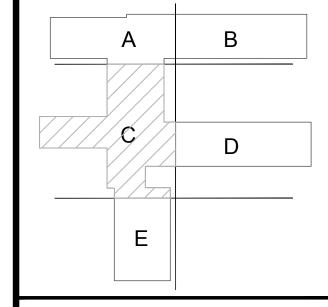
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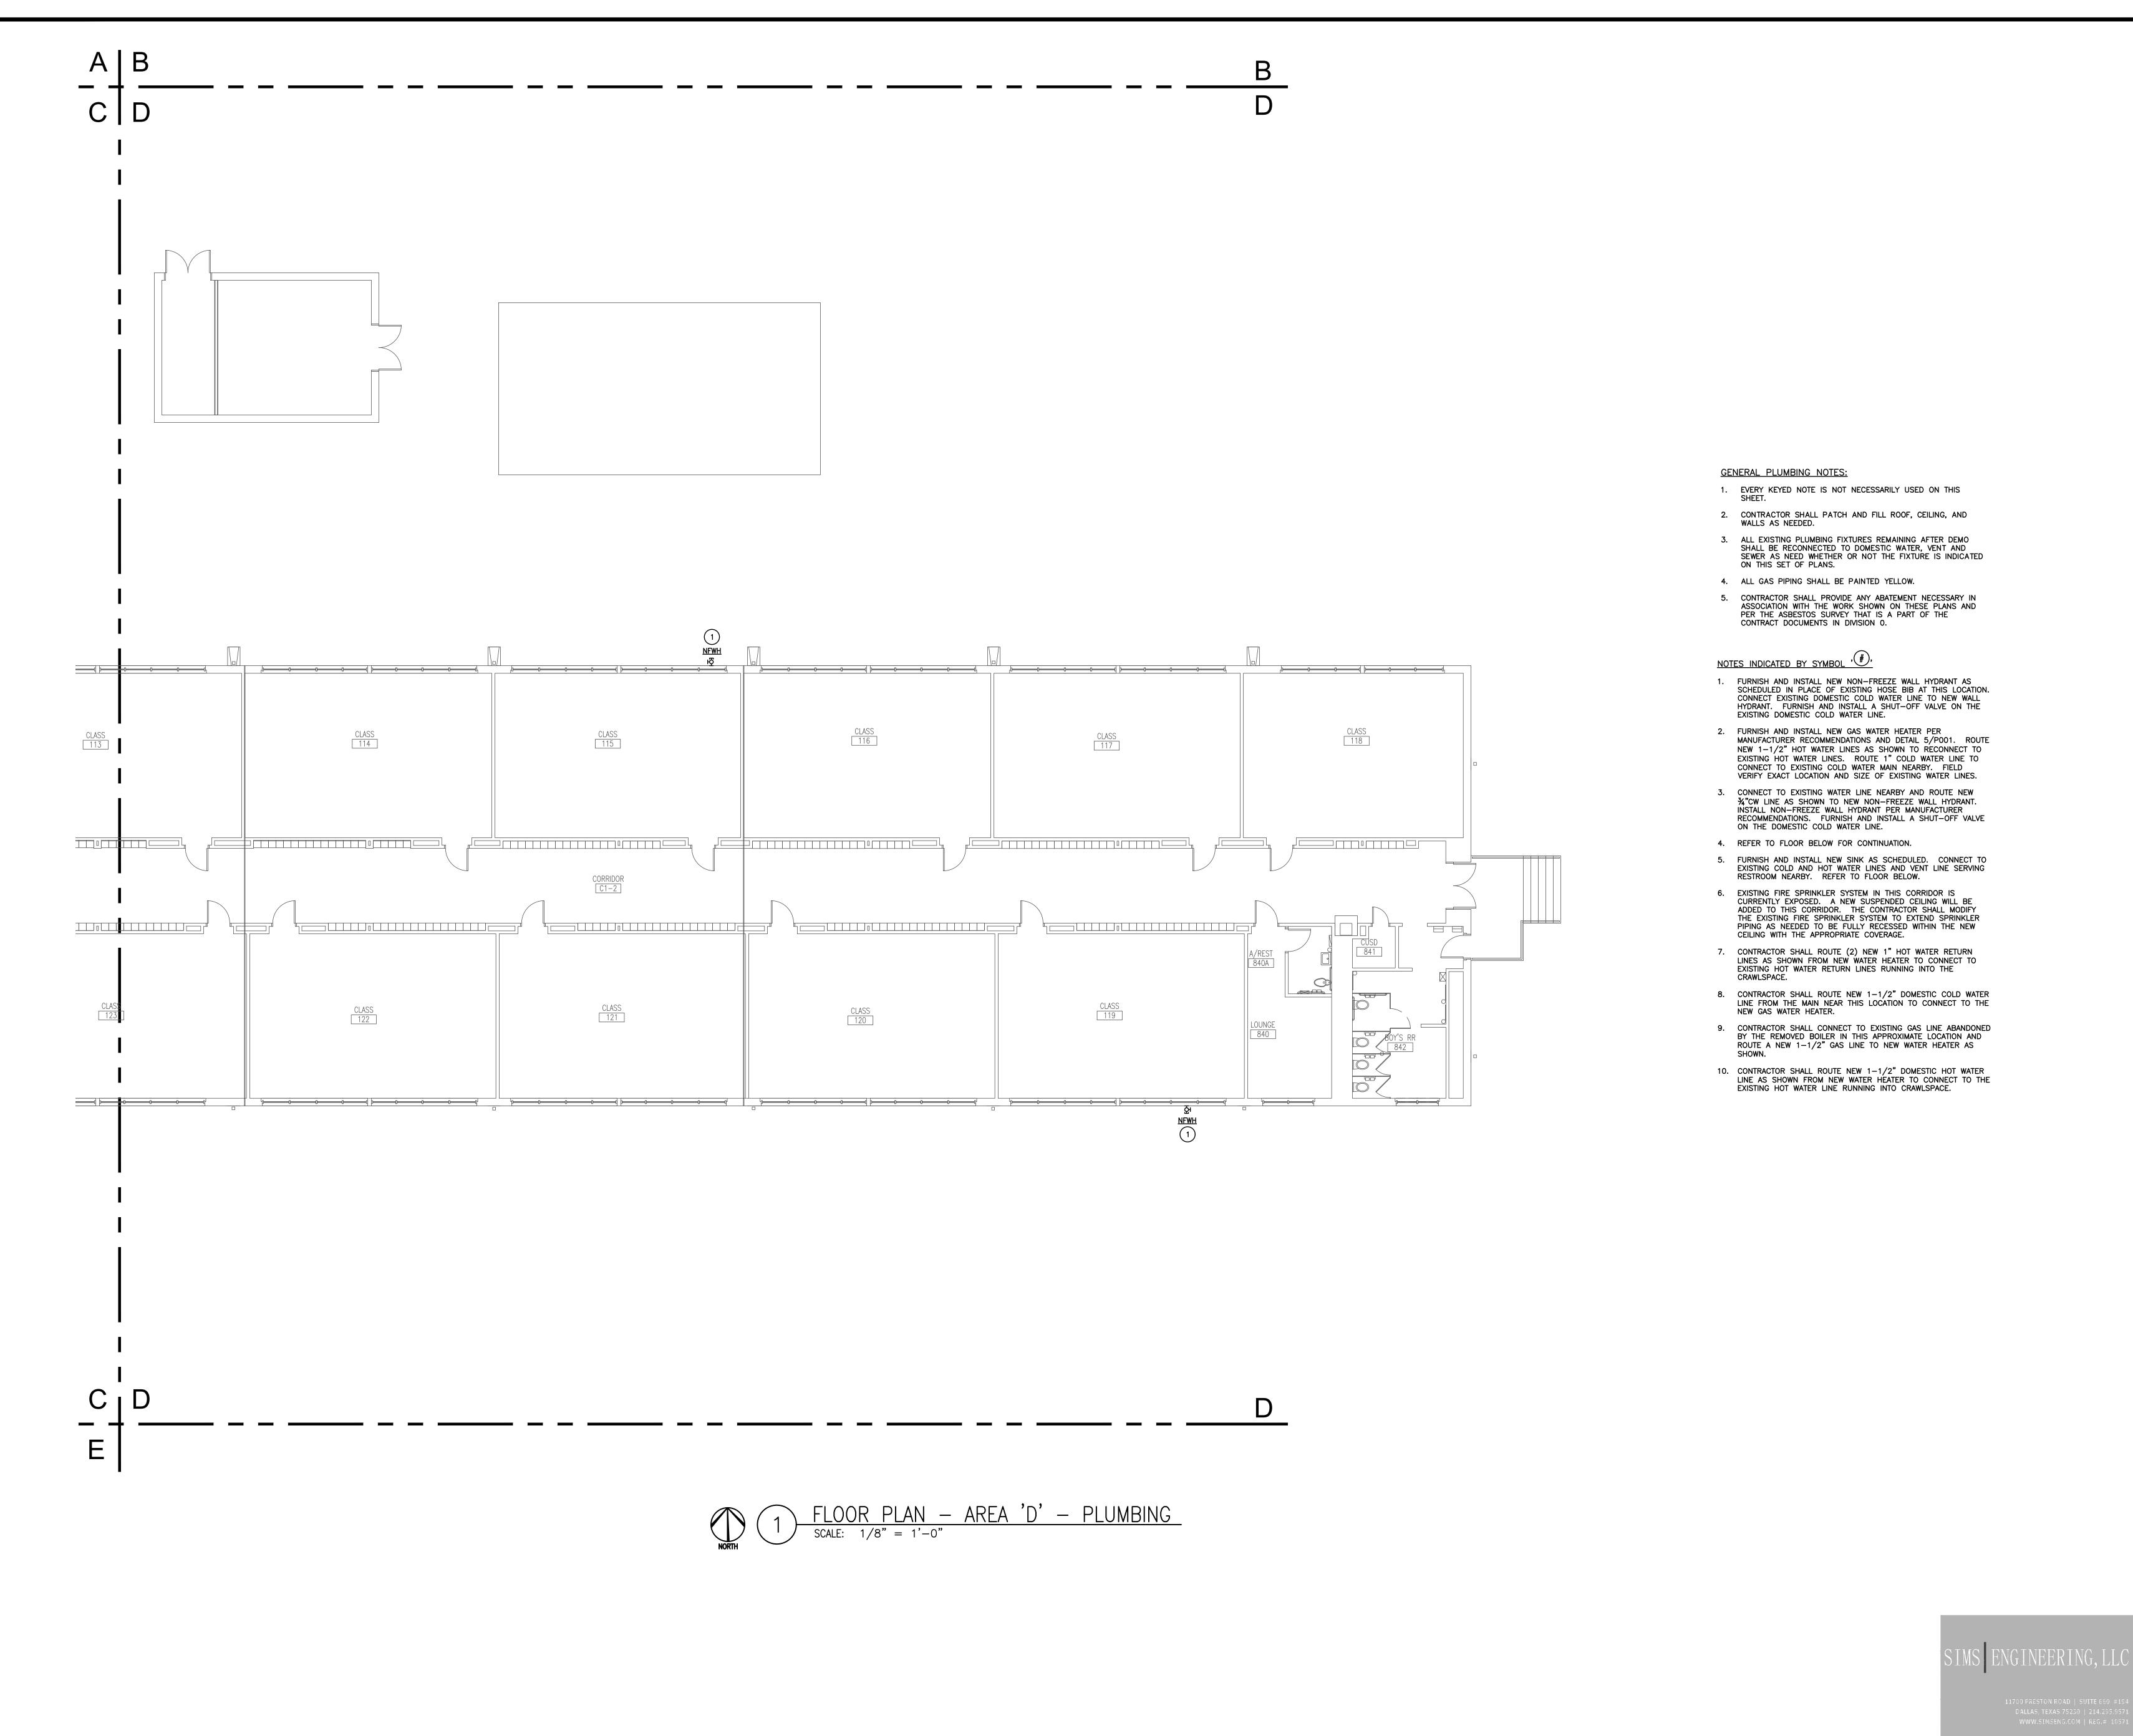
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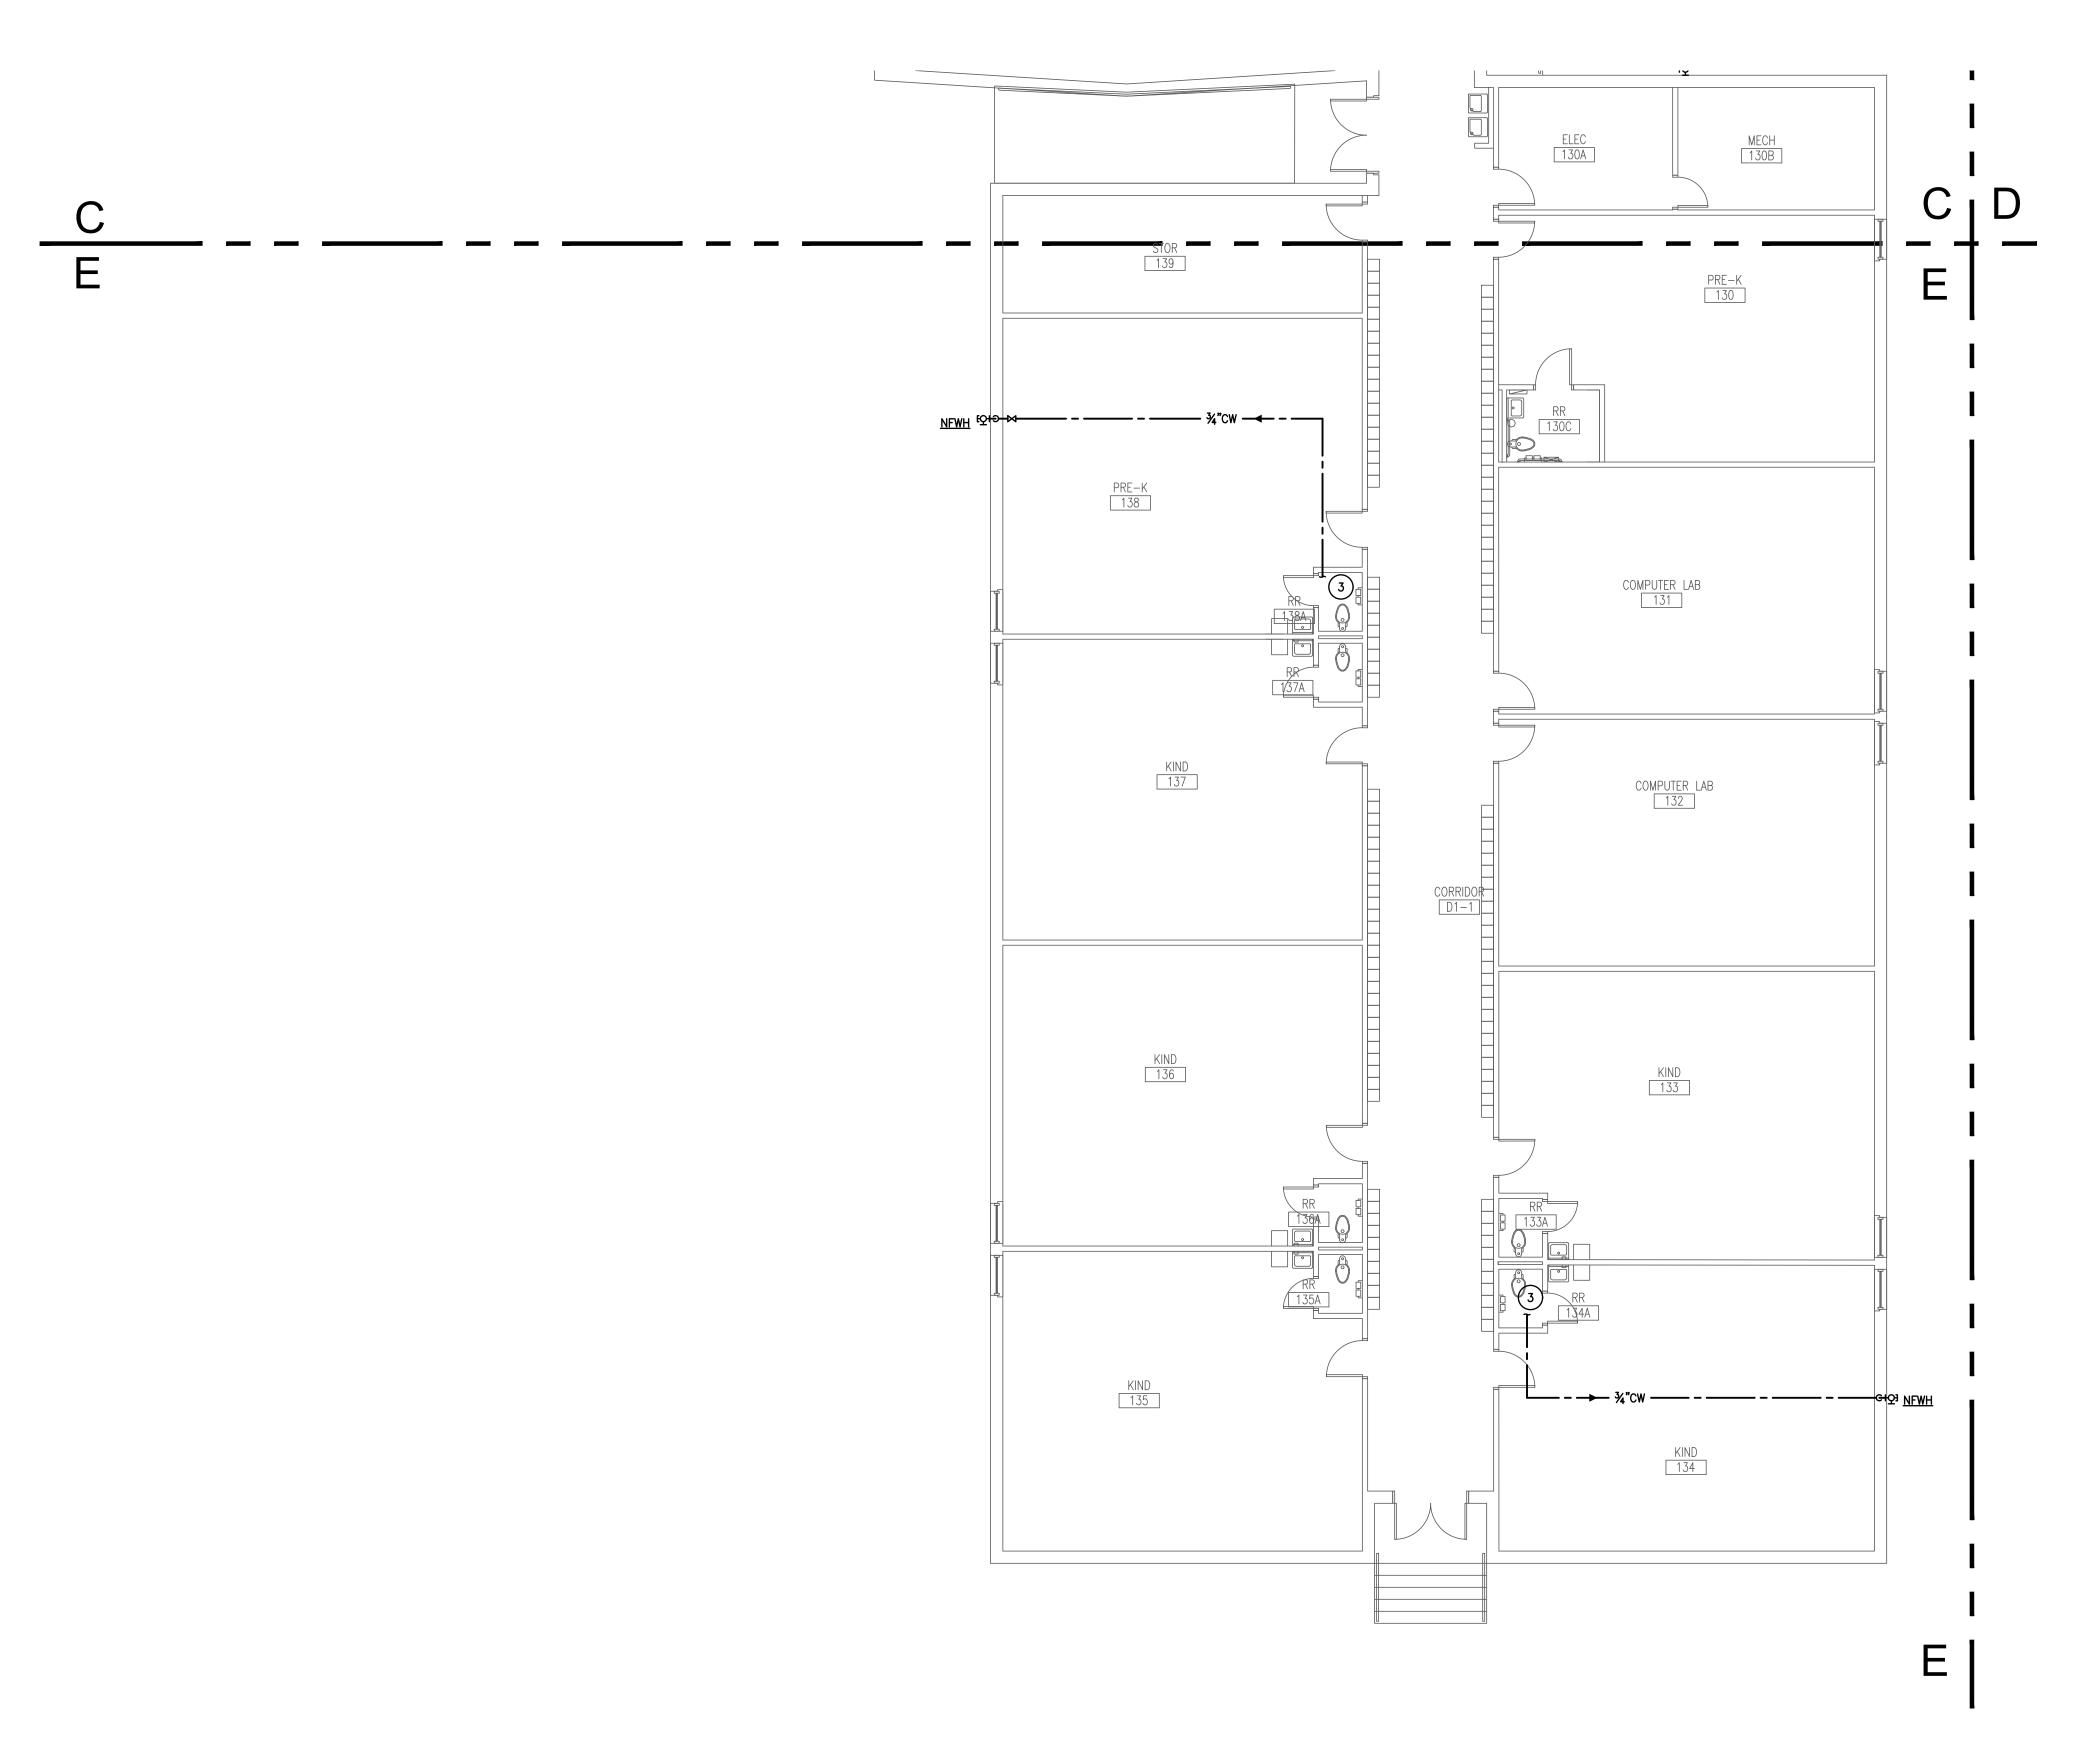
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FLOOR PLAN PLUMBING
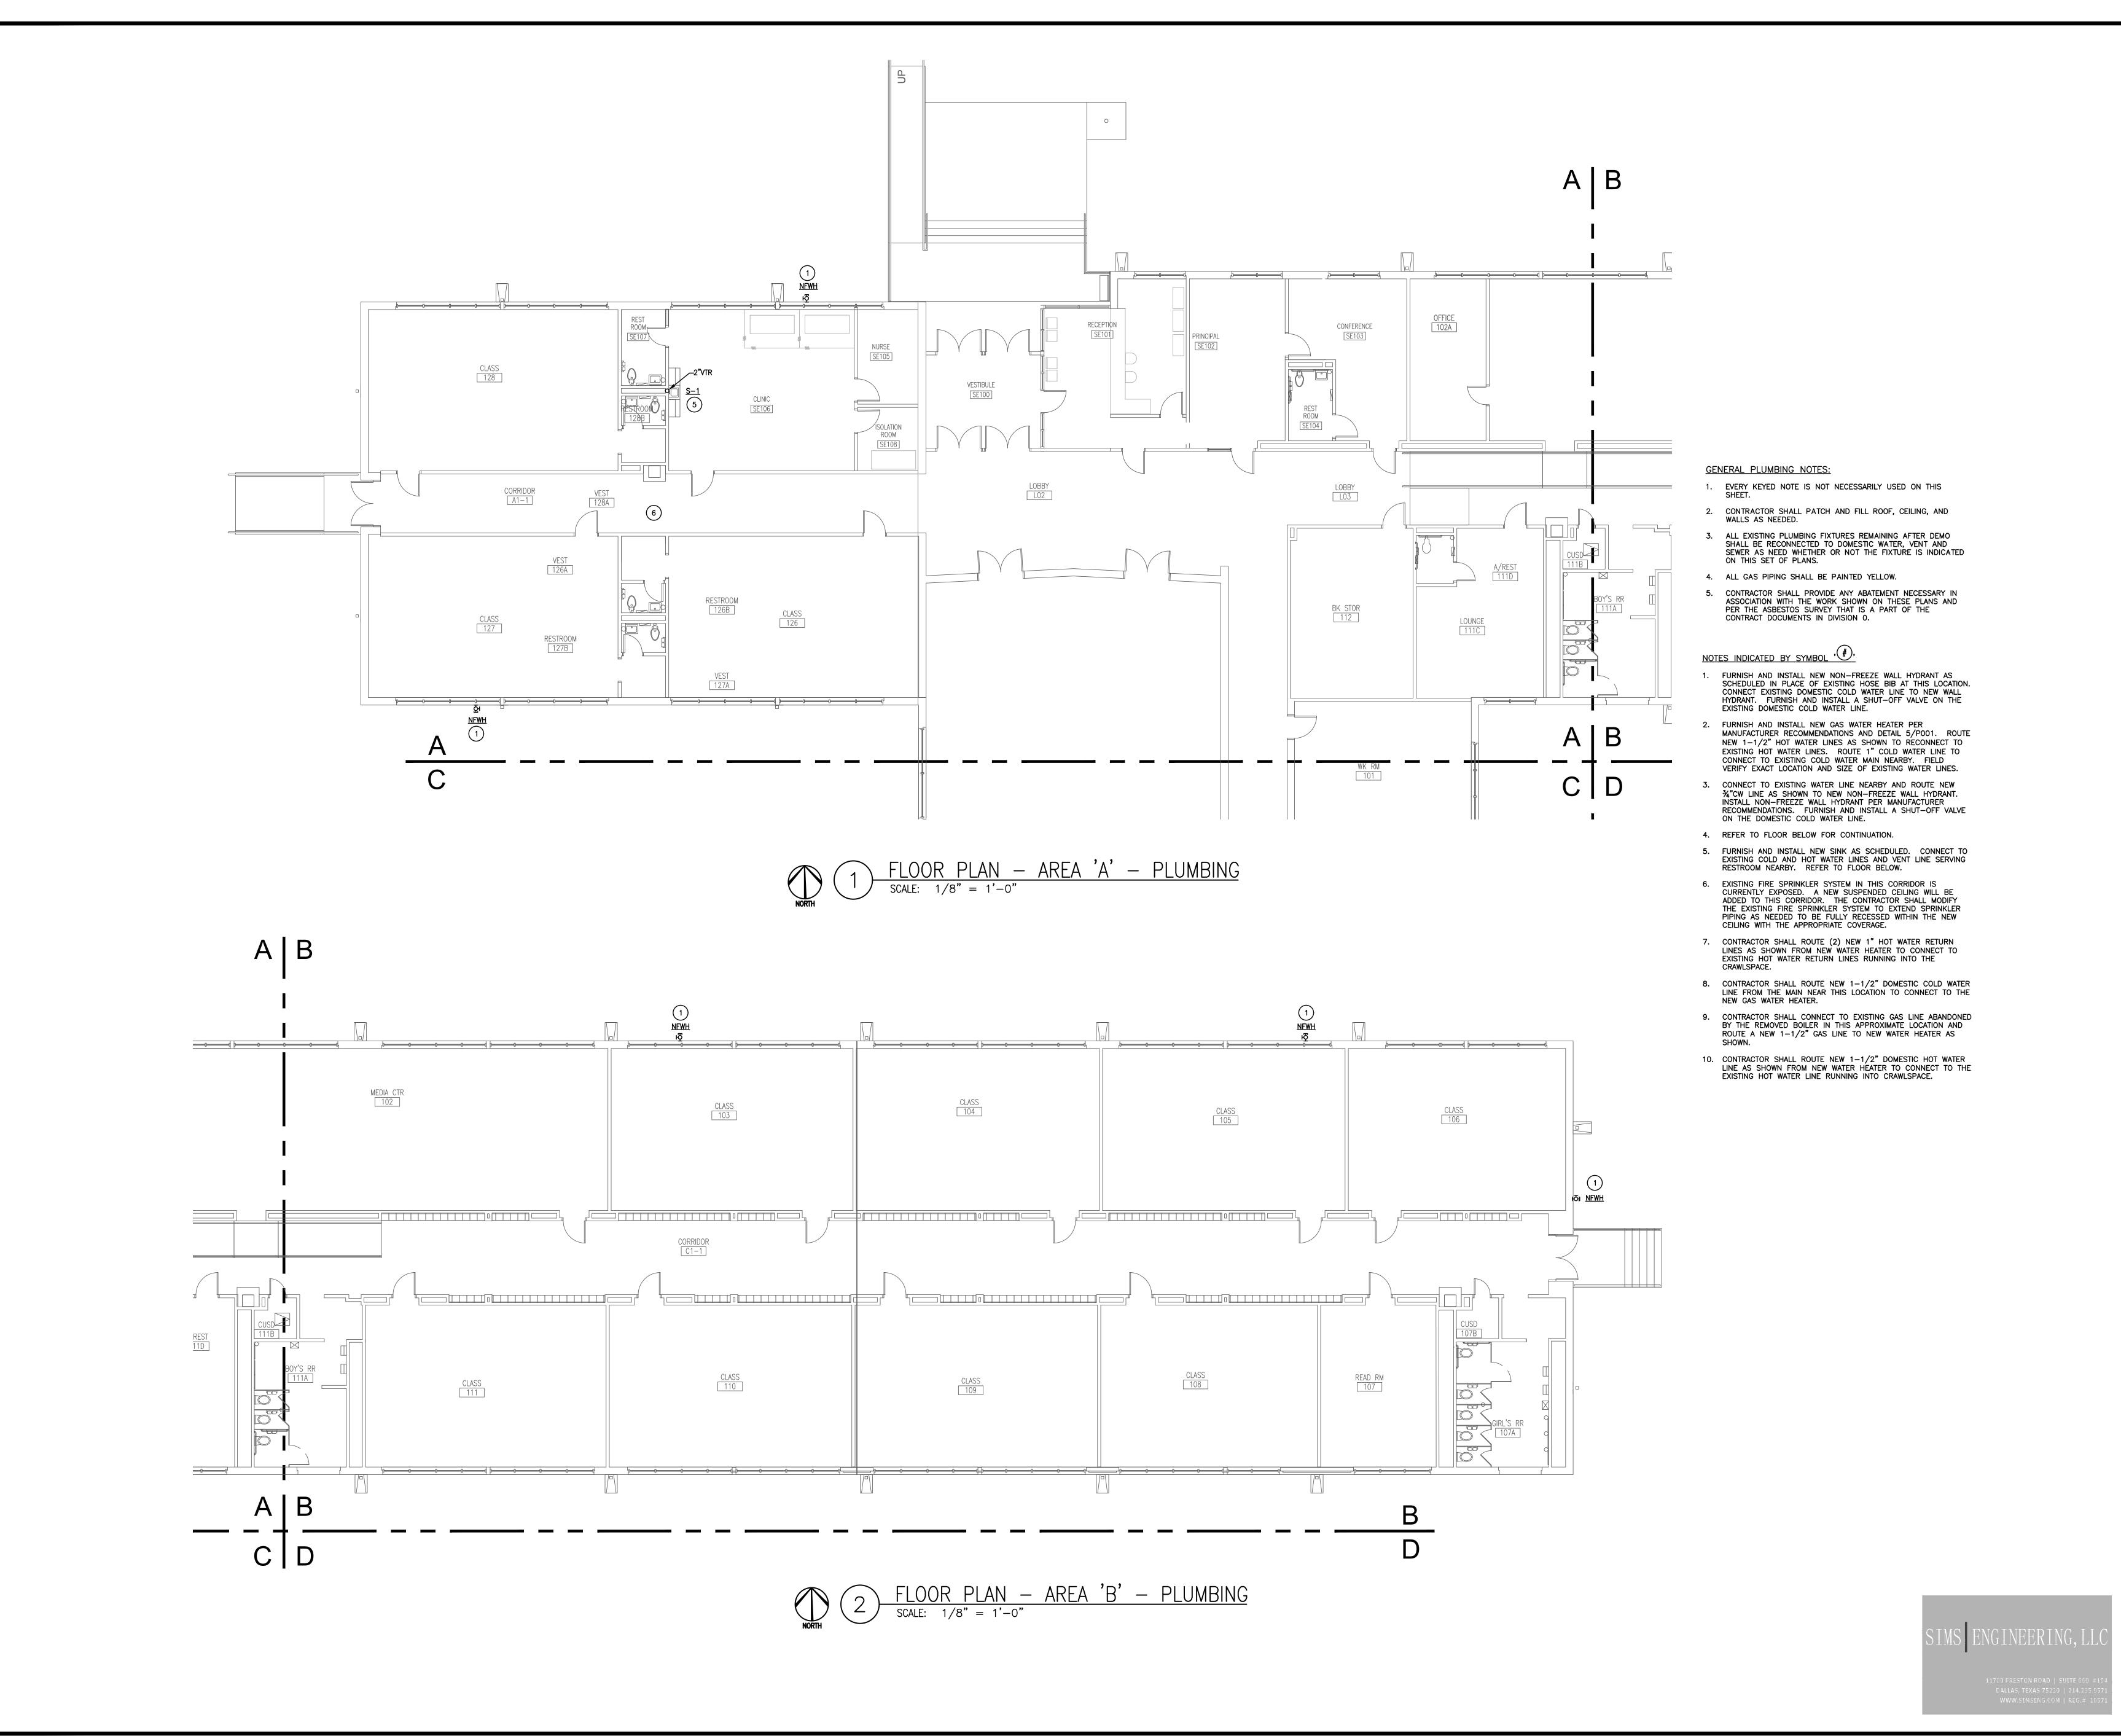
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GENERAL PLUMBING NOTES:

- 1. EVERY KEYED NOTE IS NOT NECESSARILY USED ON THIS
- CONTRACTOR SHALL PATCH AND FILL ROOF, CEILING, AND WALLS AS NEEDED.
- 3. ALL EXISTING PLUMBING FIXTURES REMAINING AFTER DEMO SHALL BE RECONNECTED TO DOMESTIC WATER, VENT AND SEWER AS NEED WHETHER OR NOT THE FIXTURE IS INDICATED ON THIS SET OF PLANS.
- 4. ALL GAS PIPING SHALL BE PAINTED YELLOW.
- 5. CONTRACTOR SHALL PROVIDE ANY ABATEMENT NECESSARY IN ASSOCIATION WITH THE WORK SHOWN ON THESE PLANS AND PER THE ASBESTOS SURVEY THAT IS A PART OF THE CONTRACT DOCUMENTS IN DIVISION 0.

NOTES INDICATED BY SYMBOL , #,

- FURNISH AND INSTALL NEW NON-FREEZE WALL HYDRANT AS SCHEDULED IN PLACE OF EXISTING HOSE BIB AT THIS LOCATION. CONNECT EXISTING DOMESTIC COLD WATER LINE TO NEW WALL HYDRANT. FURNISH AND INSTALL A SHUT-OFF VALVE ON THE EXISTING DOMESTIC COLD WATER LINE.
- 2. FURNISH AND INSTALL NEW GAS WATER HEATER PER MANUFACTURER RECOMMENDATIONS AND DETAIL 5/P001. ROUTE NEW 1-1/2" HOT WATER LINES AS SHOWN TO RECONNECT TO EXISTING HOT WATER LINES. ROUTE 1" COLD WATER LINE TO CONNECT TO EXISTING COLD WATER MAIN NEARBY. FIELD VERIFY EXACT LOCATION AND SIZE OF EXISTING WATER LINES.
- 3. CONNECT TO EXISTING WATER LINE NEARBY AND ROUTE NEW 34"CW LINE AS SHOWN TO NEW NON-FREEZE WALL HYDRANT. INSTALL NON-FREEZE WALL HYDRANT PER MANUFACTURER RECOMMENDATIONS. FURNISH AND INSTALL A SHUT-OFF VALVE ON THE DOMESTIC COLD WATER LINE.
- 4. REFER TO FLOOR BELOW FOR CONTINUATION.
- FURNISH AND INSTALL NEW SINK AS SCHEDULED. CONNECT TO EXISTING COLD AND HOT WATER LINES AND VENT LINE SERVING RESTROOM NEARBY. REFER TO FLOOR BELOW.
- 6. EXISTING FIRE SPRINKLER SYSTEM IN THIS CORRIDOR IS CURRENTLY EXPOSED. A NEW SUSPENDED CEILING WILL BE ADDED TO THIS CORRIDOR. THE CONTRACTOR SHALL MODIFY THE EXISTING FIRE SPRINKLER SYSTEM TO EXTEND SPRINKLER PIPING AS NEEDED TO BE FULLY RECESSED WITHIN THE NEW CEILING WITH THE APPROPRIATE COVERAGE.
- CONTRACTOR SHALL ROUTE (2) NEW 1" HOT WATER RETURN LINES AS SHOWN FROM NEW WATER HEATER TO CONNECT TO EXISTING HOT WATER RETURN LINES RUNNING INTO THE CRAWLSPACE.
- 8. CONTRACTOR SHALL ROUTE NEW 1-1/2" DOMESTIC COLD WATER LINE FROM THE MAIN NEAR THIS LOCATION TO CONNECT TO THE NEW GAS WATER HEATER.
- 9. CONTRACTOR SHALL CONNECT TO EXISTING GAS LINE ABANDONED BY THE REMOVED BOILER IN THIS APPROXIMATE LOCATION AND ROUTE A NEW 1-1/2" GAS LINE TO NEW WATER HEATER AS
- SHOWN.

 10. CONTRACTOR SHALL ROUTE NEW 1-1/2" DOMESTIC HOT WATER LINE AS SHOWN FROM NEW WATER HEATER TO CONNECT TO THE EXISTING HOT WATER LINE RUNNING INTO CRAWLSPACE.

FLOOR PLAN - AREA 'E' - PLUMBING

SCALE: 1/8" = 1'-0"



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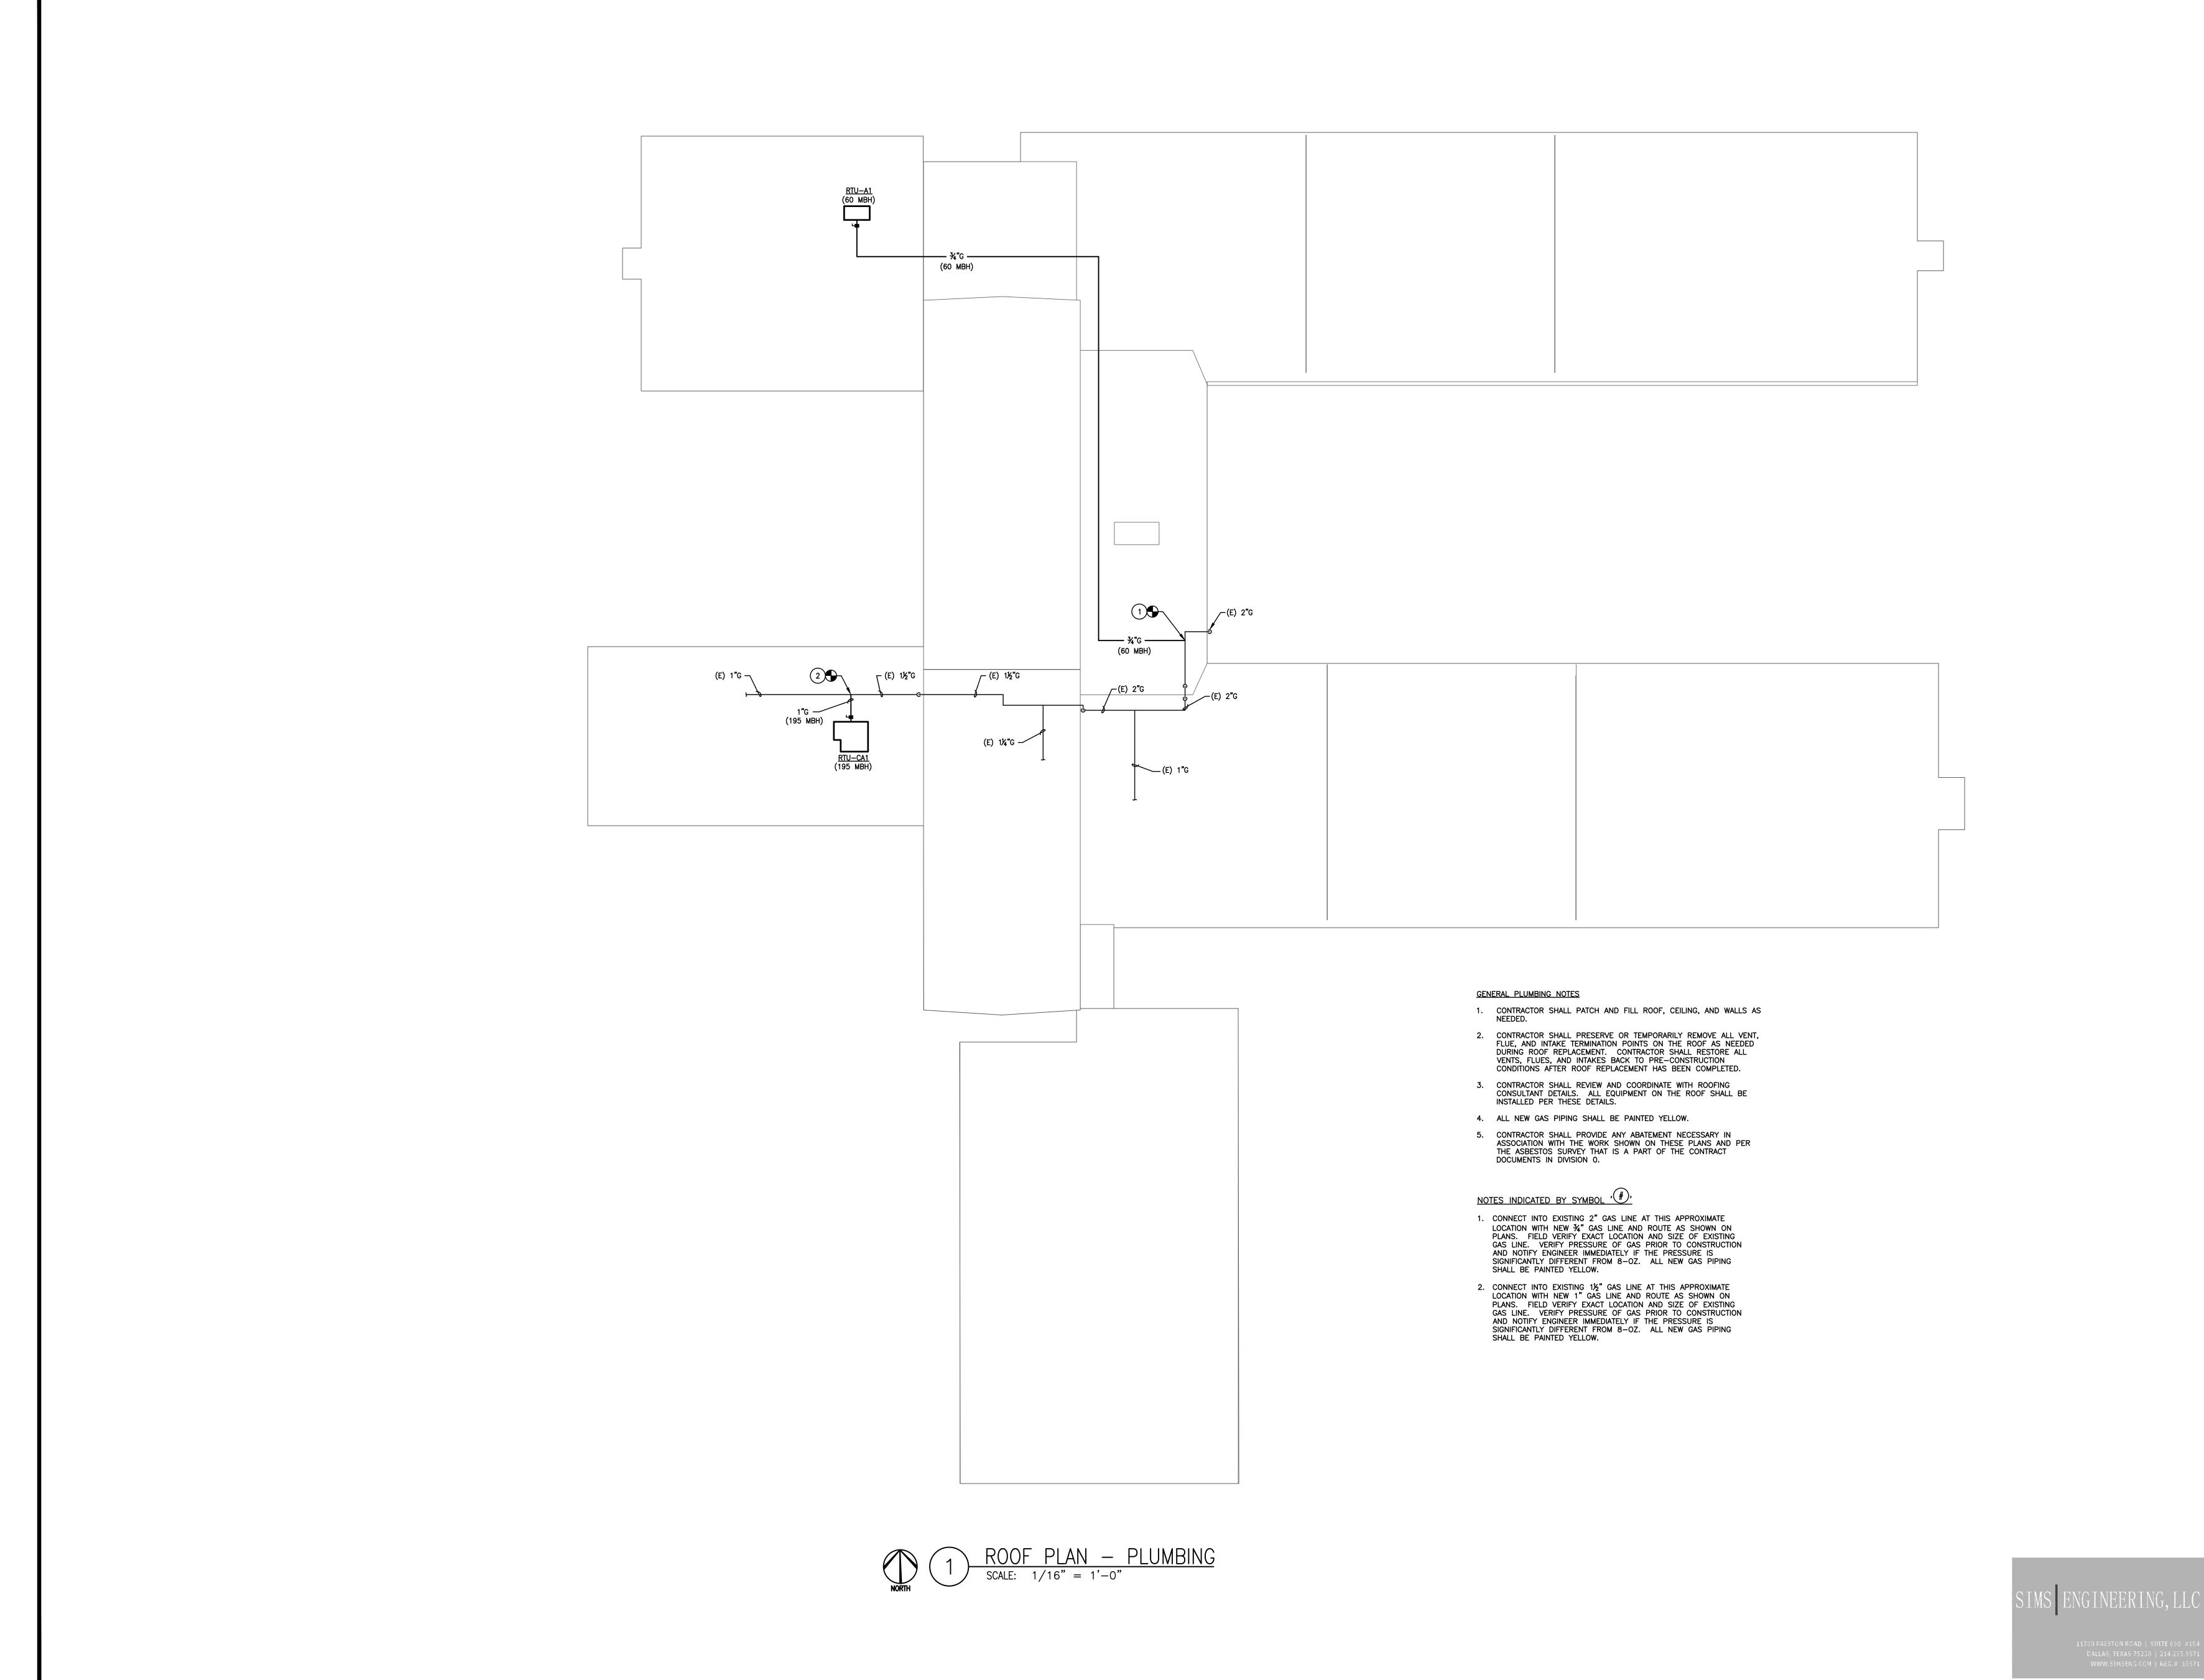
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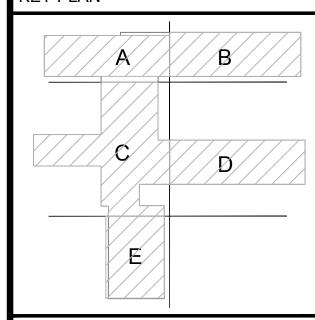
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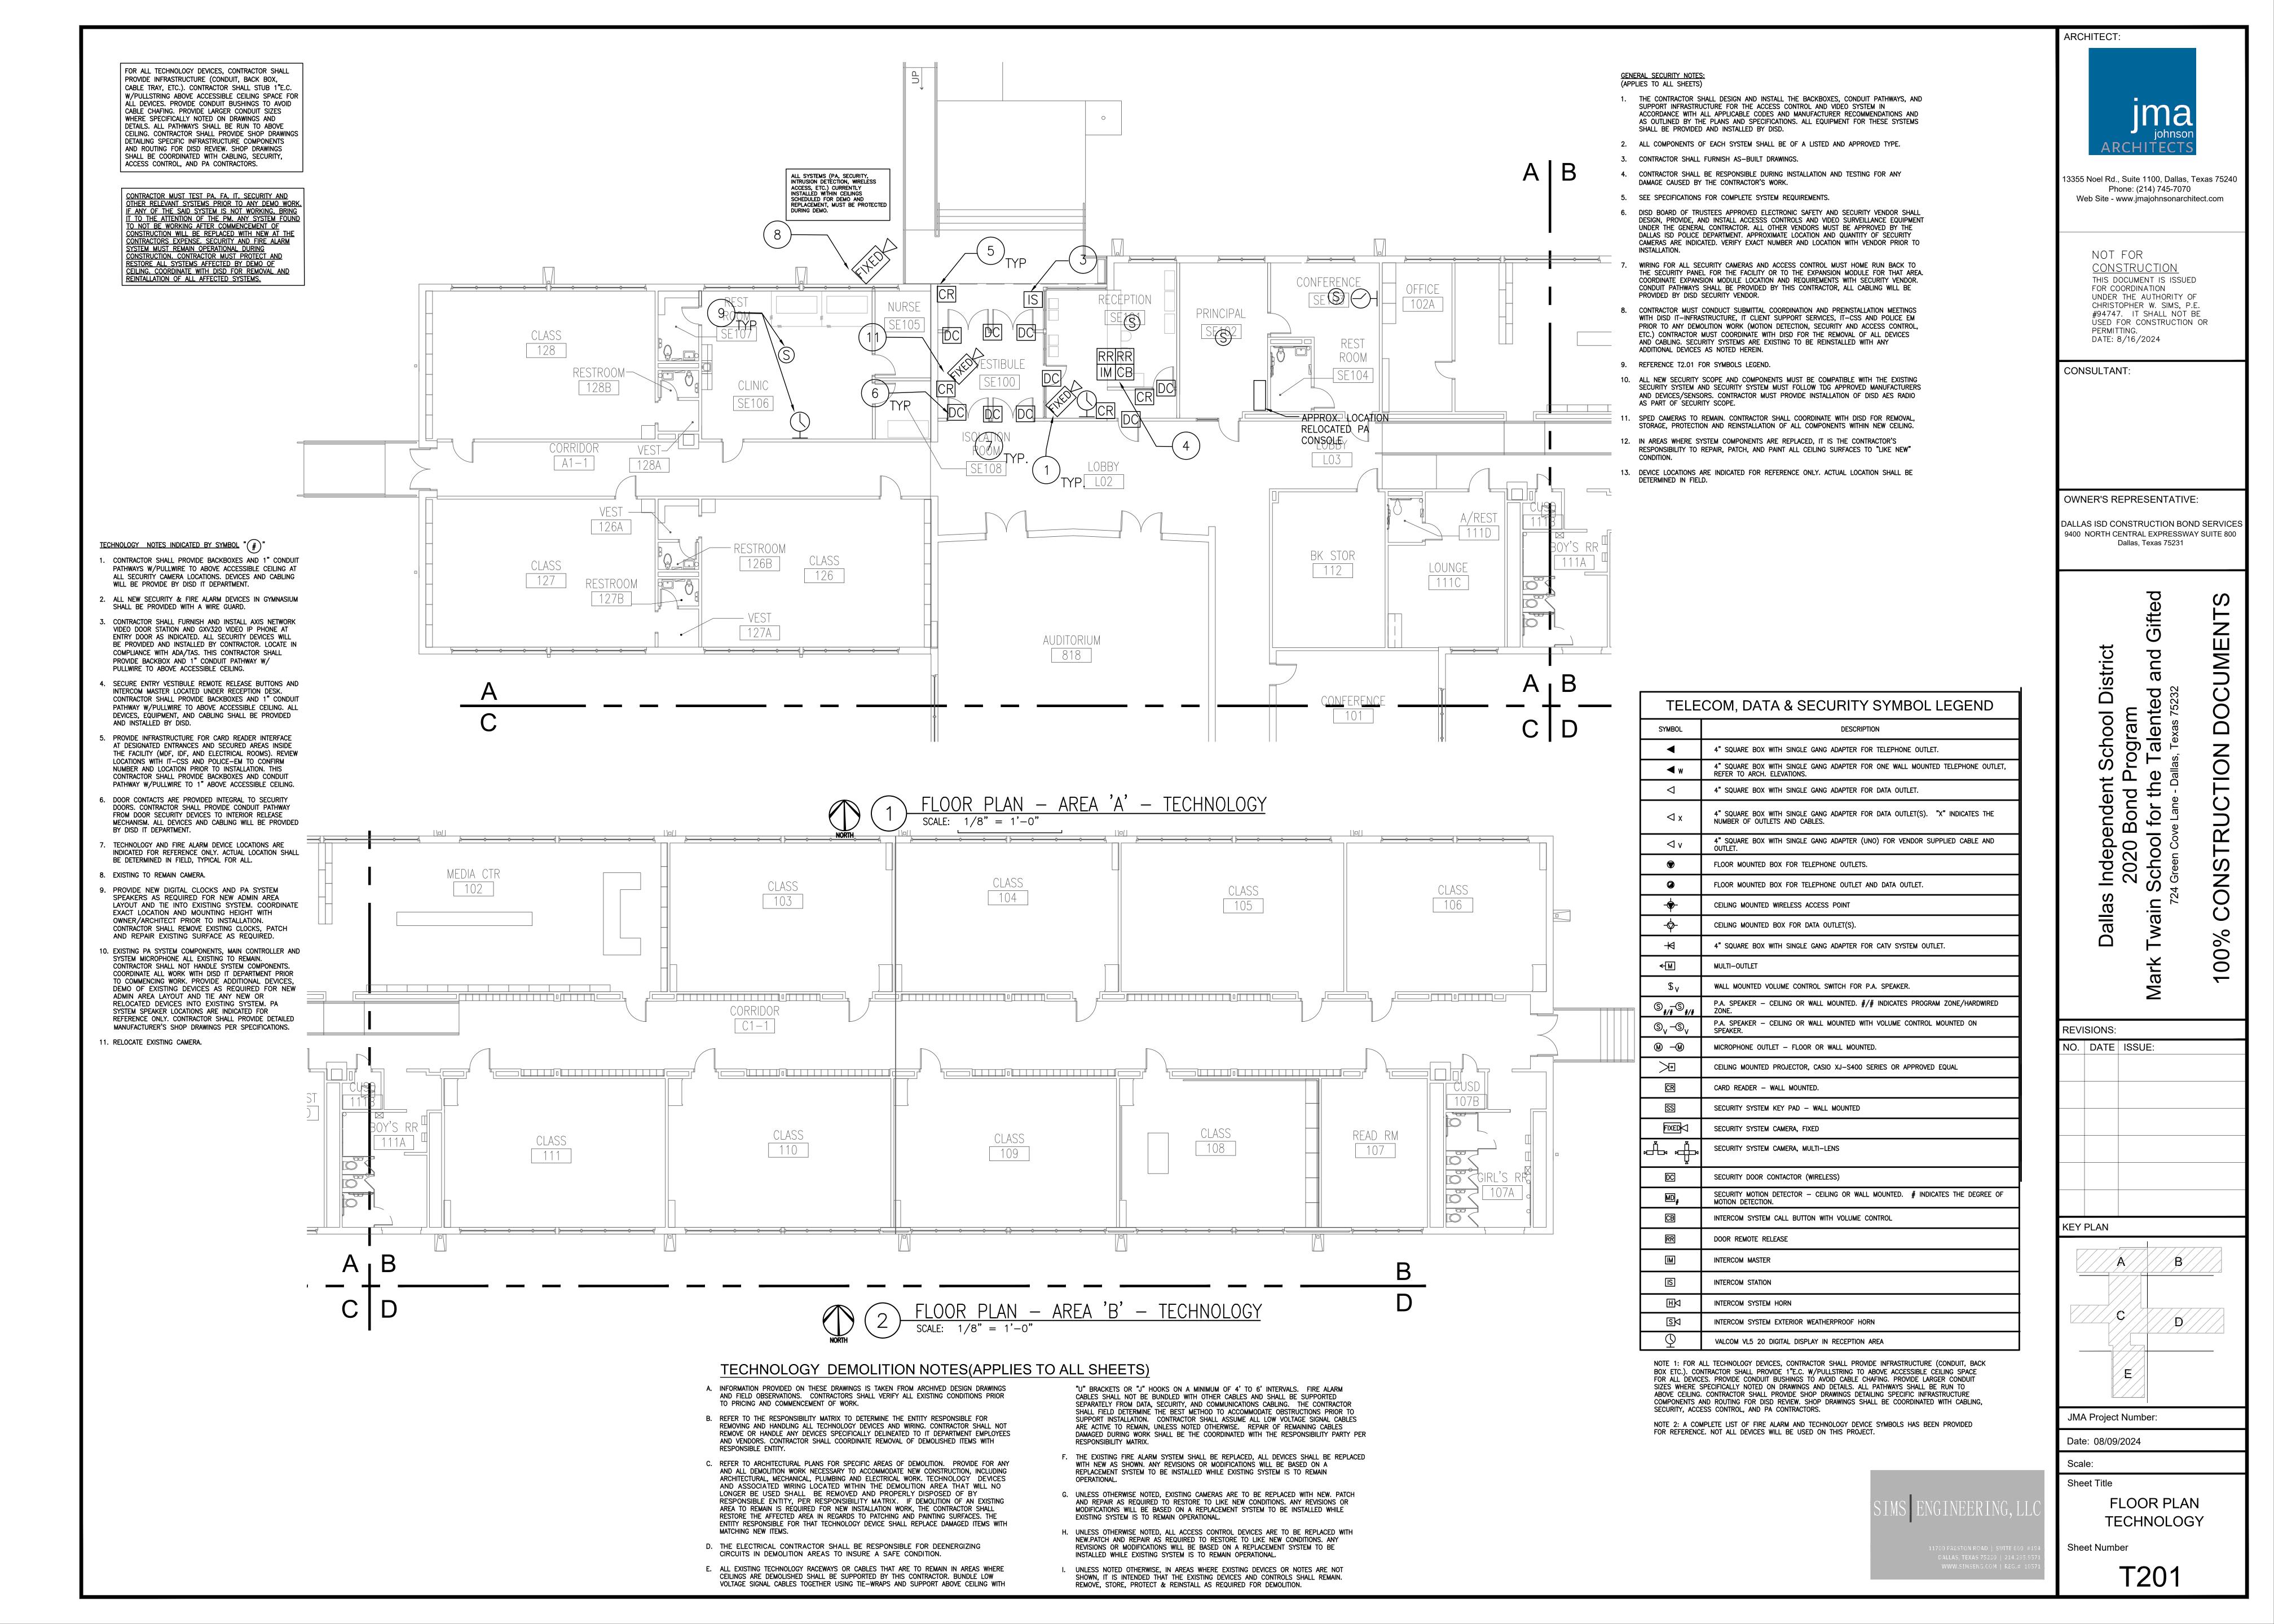
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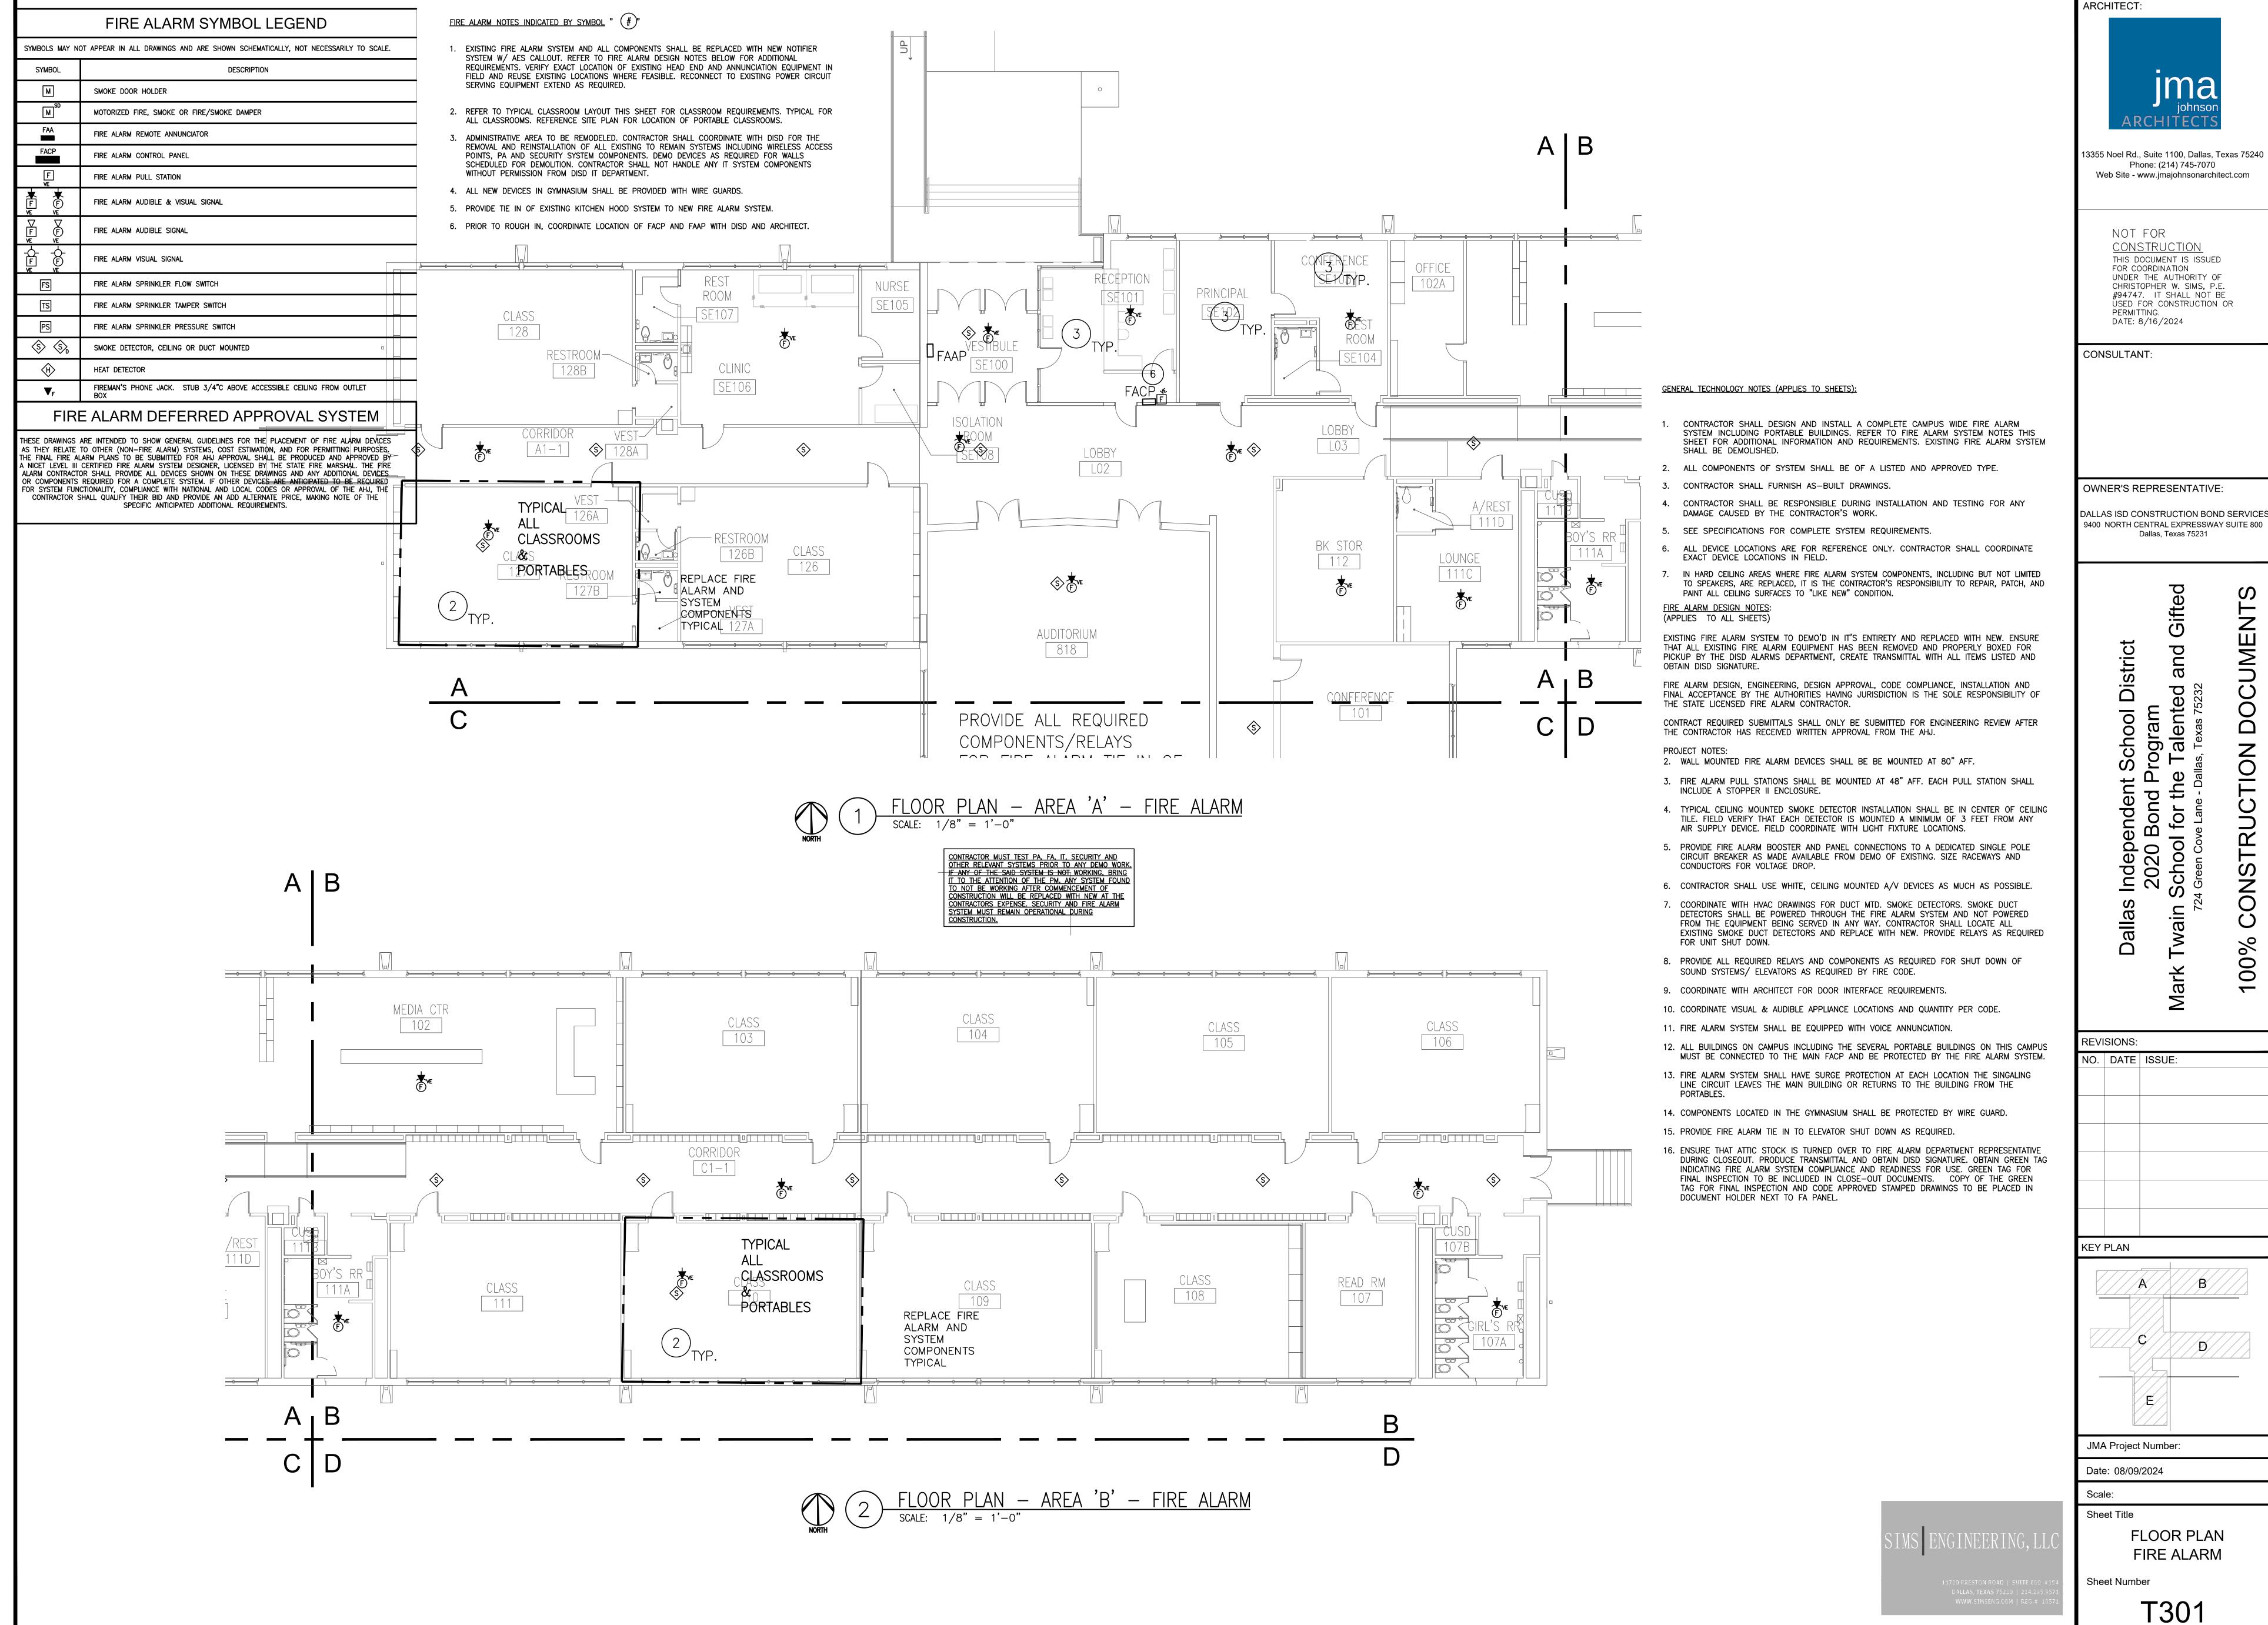
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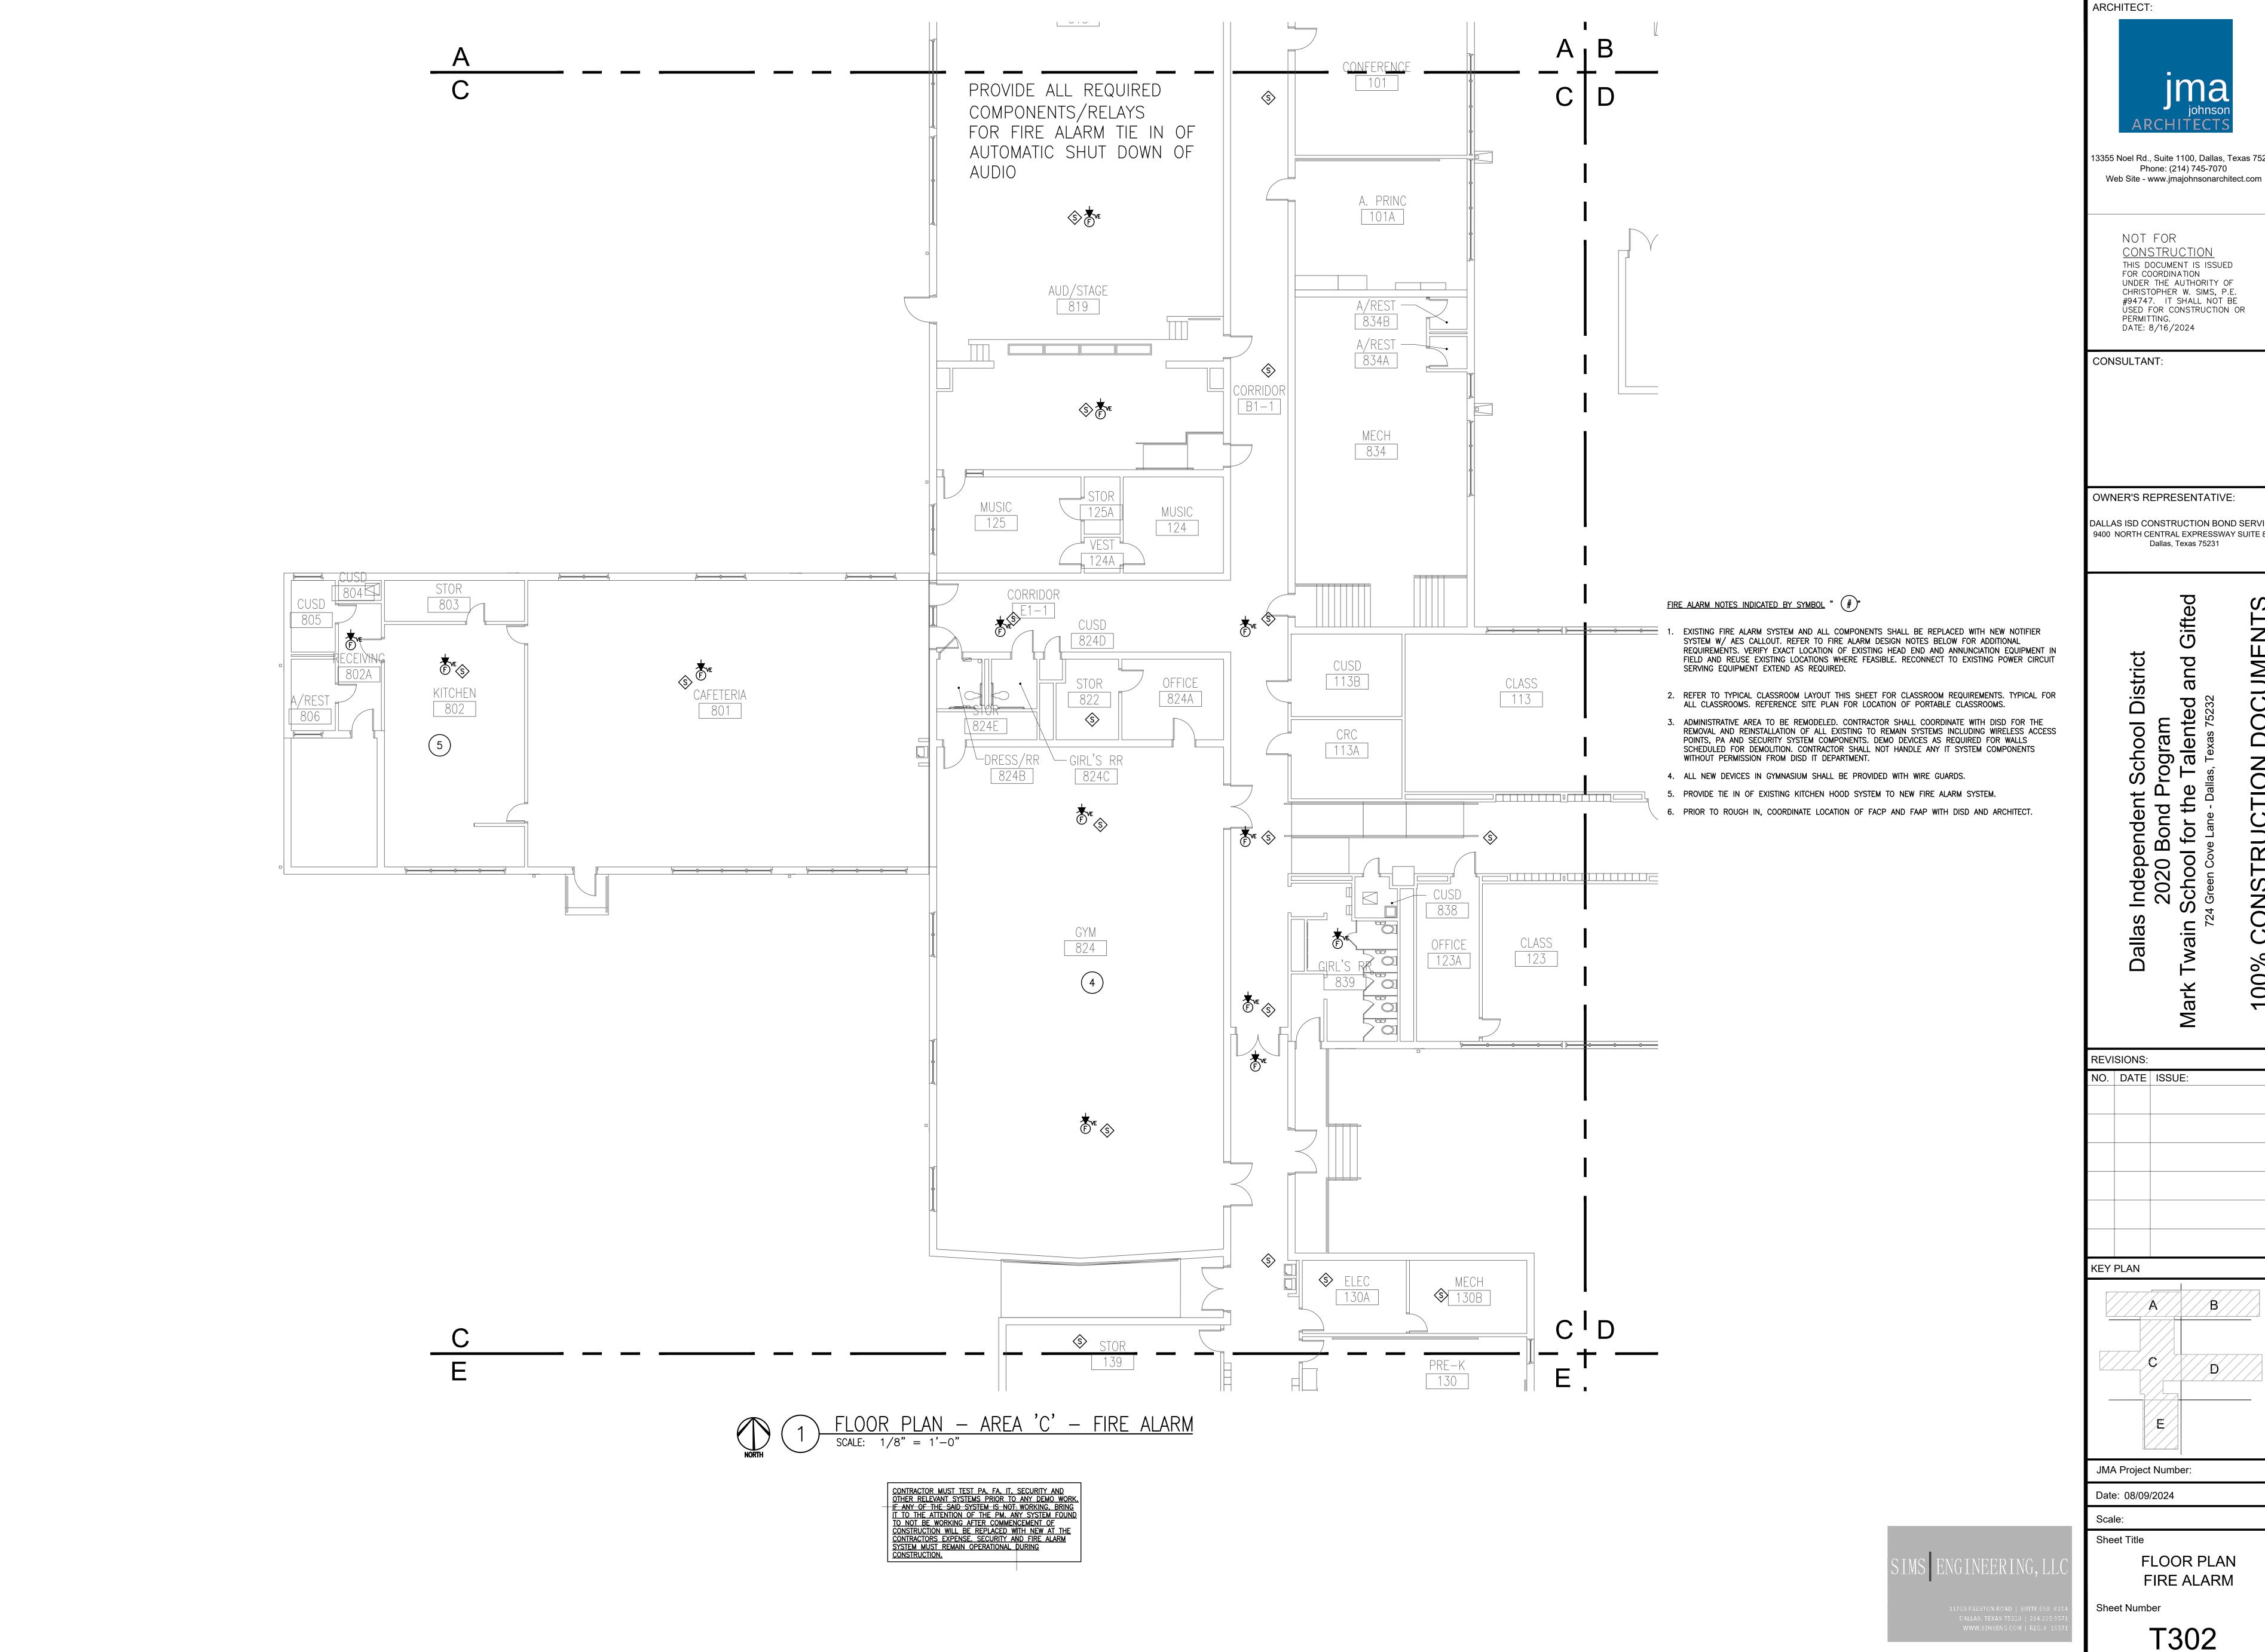
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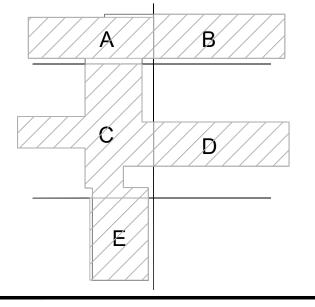



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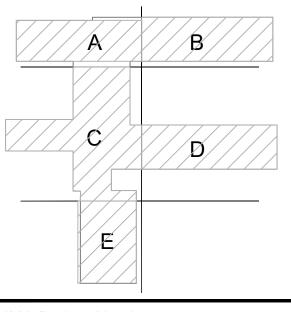
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FLOOR PLAN FIRE ALARM

T303



- 1. EXISTING FIRE ALARM SYSTEM AND ALL COMPONENTS SHALL BE REPLACED WITH NEW NOTIFIER SYSTEM W/ AES CALLOUT. REFER TO FIRE ALARM DESIGN NOTES BELOW FOR ADDITIONAL REQUIREMENTS. VERIFY EXACT LOCATION OF EXISTING HEAD END AND ANNUNCIATION EQUIPMENT IN FIELD AND REUSE EXISTING LOCATIONS WHERE FEASIBLE. RECONNECT TO EXISTING POWER CIRCUIT SERVING EQUIPMENT EXTEND AS REQUIRED.
- REFER TO TYPICAL CLASSROOM LAYOUT THIS SHEET FOR CLASSROOM REQUIREMENTS. TYPICAL FOR ALL CLASSROOMS. REFERENCE SITE PLAN FOR LOCATION OF PORTABLE CLASSROOMS.
- 3. ADMINISTRATIVE AREA TO BE REMODELED. CONTRACTOR SHALL COORDINATE WITH DISD FOR THE REMOVAL AND REINSTALLATION OF ALL EXISTING TO REMAIN SYSTEMS INCLUDING WIRELESS ACCESS POINTS, PA AND SECURITY SYSTEM COMPONENTS. DEMO DEVICES AS REQUIRED FOR WALLS SCHEDULED FOR DEMOLITION. CONTRACTOR SHALL NOT HANDLE ANY IT SYSTEM COMPONENTS WITHOUT PERMISSION FROM DISD IT DEPARTMENT.
- 4. ALL NEW DEVICES IN GYMNASIUM SHALL BE PROVIDED WITH WIRE GUARDS.
- 5. PROVIDE TIE IN OF EXISTING KITCHEN HOOD SYSTEM TO NEW FIRE ALARM SYSTEM.

FIRE ALARM NOTES INDICATED BY SYMBOL " #"

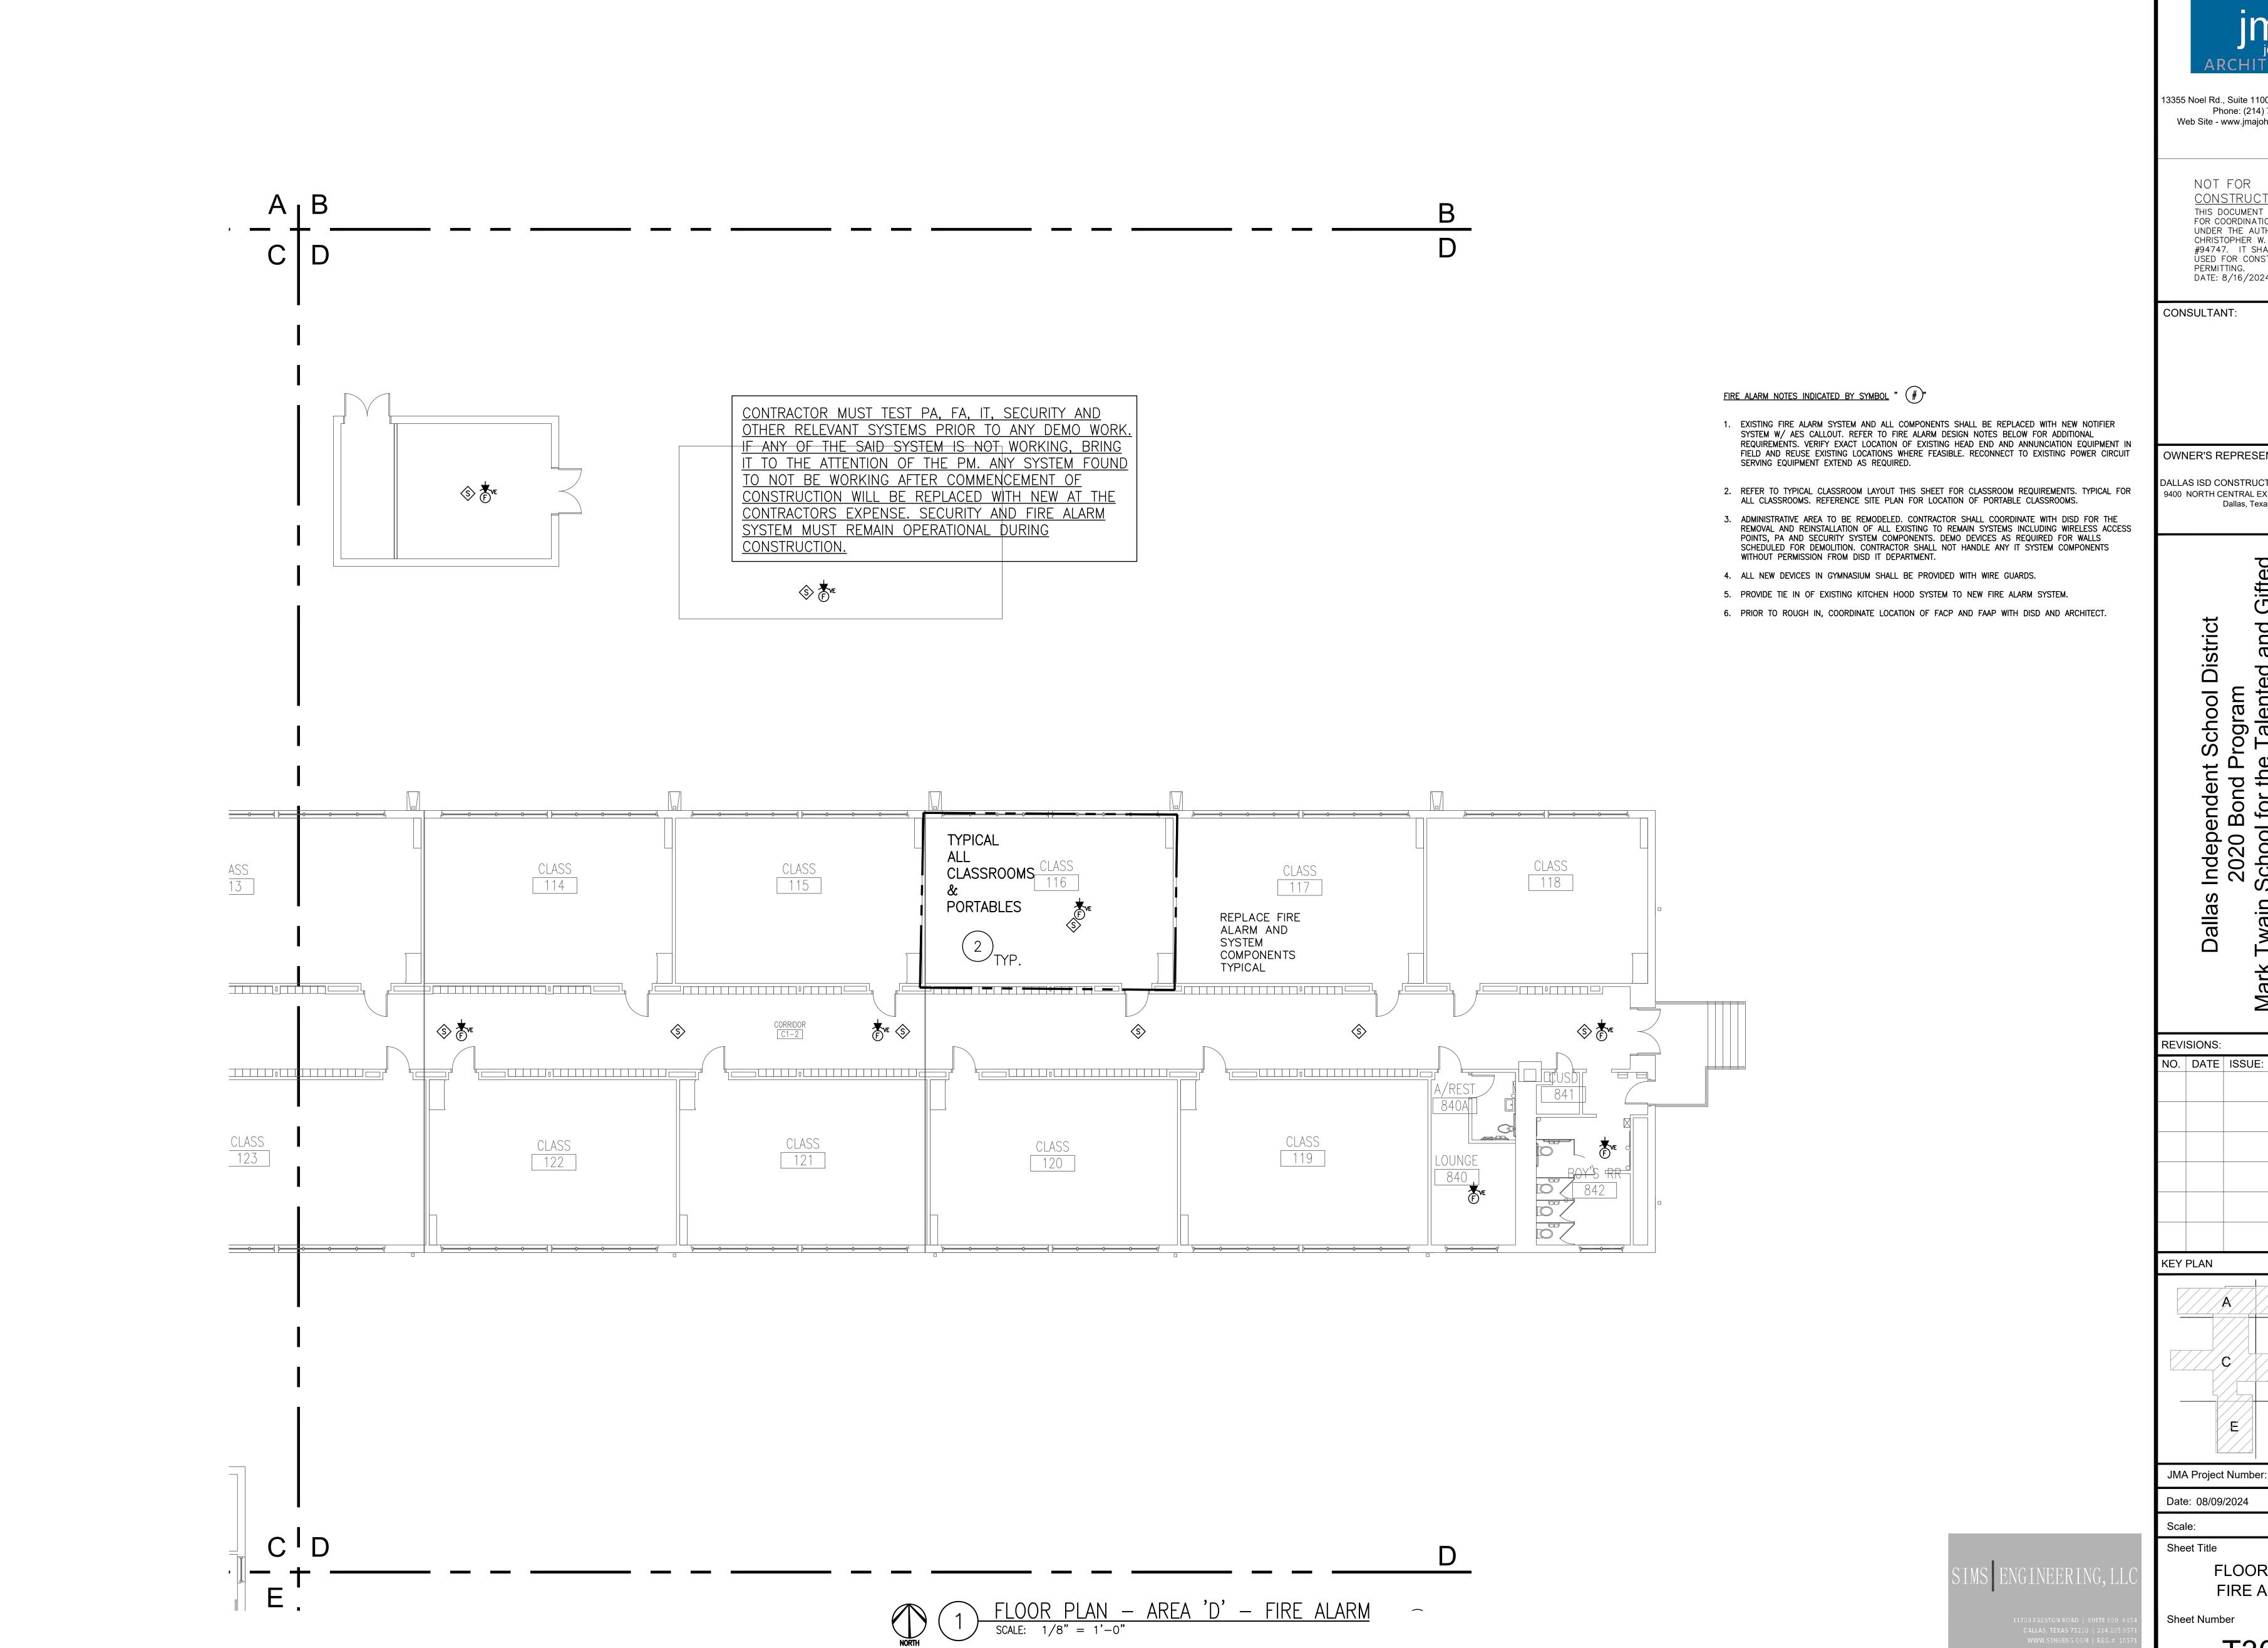6. PRIOR TO ROUGH IN, COORDINATE LOCATION OF FACP AND FAAP WITH DISD AND ARCHITECT.

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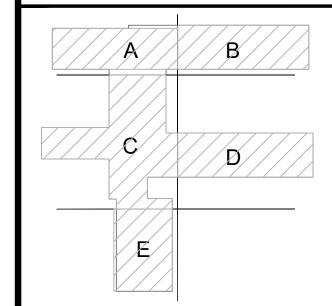
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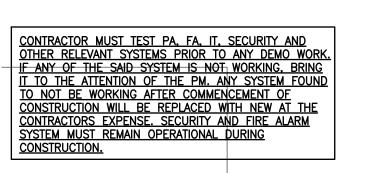
FLOOR PLAN FIRE ALARM

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T304

FLOOR PLAN - AREA 'E' - FIRE ALARM

SCALE: 1/8" = 1'-0"





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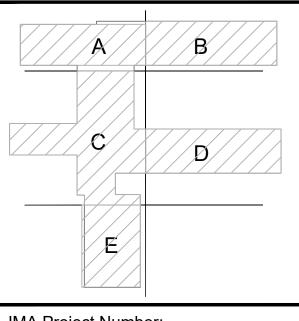
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ROOF PLAN FIRE ALARM

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